

ADDENDUM NO. 1

HOME BLEACHERS

LITTLE JOB #612-12353-10 DSA: A# 03-120515 File #56-H4

Rio Mesa High School

545 Central Avenue Oxnard, CA 93036

August 04, 2020

LITTLE

1300 Dove Street, Suite 100 Newport Beach, CA 92660



Architect Jay R. Tittle, C- 12955

1. PART 1 - GENERAL

- **1.1.** The following revisions and/or clarifications shall be made to the Bidding Requirements and Contract Documents. Revise and amend the Documents for the above named project in accordance with this Addendum. The bid shall reflect these addendum changes and each bidder shall make reference in their bid to this addendum.
- **1.2.** All Bidding Requirements and Contract Documents shall apply to this addendum as originally indicated in the applicable portions of the contract documents, unless otherwise modified by this addendum.
 - **1.2.1.** No Previous Addendum issued.
- 1.3. GENERAL CLARIFICATIONS
 - **1.3.1.** The following clarifications are issued to all bidders as information for use in preparing bids:
 - **1.3.1.1.** ACAD files will be provided to successful Bidder.

- 1.3.1.2. Add 'Partial Underground Utility Map' (sheets 1 3), for reference noting the following: 'DSA approved construction documents were prepared using Armstrong & Brooks Consulting Engineers, Inc. survey files where majority of the existing utilities were mapped using available records and some were verified at field. Recently, 'C-below' was contracted to perform Underground Utility survey and they have provided us with their maps for Contractor's reference. For bidding purposes, Contractor shall consider information shown on these maps in addition to what is shown on DSA approved plans as some of the existing utilities within work area will be impacted by proposed improvements.'
- 1.3.1.3. Add 'TOPOGRAPHIC SITE PLAN' (sheets 1 6), for reference noting the following: 'DSA approved construction documents were prepared using Armstrong & Brooks Consulting Engineers, Inc. topo survey files where the linework on their survey files were mostly from aerial survey. Recently, surveyor was tasked to update their topographic survey files to include linework on their survey maps where detailed foot survey was performed at field. Attached are updated topographic survey files for reference. For bidding purposes, contractor shall consider information shown on these maps in addition to what is shown on DSA approved plans.'

2. PART 2 - PROJECT MANUAL

- 2.1. CHANGES TO PROJECT MANUAL TABLE OF CONTENTS
 - **2.1.1.** None.
- 2.2. SPECIFICATIONS ISSUED
 - **2.2.1.** None.
- 2.3. NARRATIVE CHANGES TO SPECIFICATIONS
 - **2.3.1.** Section **31 23 16**, Excavation Modify this Section as follows:
 - **2.3.1.1.** Paragraph **3.04A7.a**; revise 'building footprint' to read as: 'Bleachers bearing zone including ramps and stairs'

3. PART 3 - DRAWINGS

- 3.1. ARCHITECTURAL DRAWINGS ISSUED
 - **3.1.1.** The following Addendum ("AD") Drawings, marked Delta 1, are issued:
 - **3.1.1.1.** Drawing A1.0.1: Revise currently issued Drawing per AD1-A1.

END OF ADDENDUM NO. 1

Enclosures:

- I) Reference Plans Issued:
 - a) 'Partial Underground Utility Map' (sheets 1 3)
 - b) 'TOPOGRAPHIC SITE PLAN' (sheets 1 6)
- II) New 11 x 17 Drawings Issued:
 - a) Drawings AD1-A1, Delta 1.

DRAWING SHEETS			
SHEET NO.	SHEET TITLE		
1	COVER SHEET		
2-3	UTILITY MAP		

UTILITY QUALITY LEVELS NOTES

INFORMATION PROVIDED FROM AMERICAN SOCIETY OF CIVIL ENGINEERS (ASCE) CI/ASCE 38-02 MANUAL.

<u>utility quality level a</u>

PRECISE HORIZONTAL AND VERTICAL LOCATION OF UTILITIES OBTAINED BY THE ACTUAL EXPOSURE (OR VERIFICATION OF PREVIOUSLY EXPOSED AND SURVEYED UTILITIES) AND SUBSEQUENT MEASUREMENT OF SUBSURFACE UTILITIES, USUALLY AT A SPECIFIC POINT. MINIMALLY INTRUSIVE EXCAVATION EQUIPMENT IS TYPICALLY USED TO MINIMIZE THE POTENTIAL FOR UTILITY DAMAGE. A PRECISE HORIZONTAL AND VERTICAL LOCATION, AS WELL AS OTHER UTILITY ATTRIBUTES, IS SHOWN ON PLAN DOCUMENTS. ACCURACY IS TYPICALLY SET TO 15-MM VERTICAL AND TO APPLICABLE HORIZONTAL SURVEY AND MAPPING ACCURACY AS DEFINED OR EXPECTED BY THE PROJECT OWNER.

UTILITY QUALITY LEVEL B

INFORMATION OBTAINED THROUGH THE APPLICATION OF APPROPRIATE SURFACE GEOPHYSICAL METHODS TO DETERMINE THE EXISTENCE AND APPROXIMATE HORIZONTAL POSITION OF SUBSURFACE UTILITIES. QUALITY LEVEL B DATA SHOULD BE REPRODUCIBLE BY SURFACE GEOPHYSICS AT ANY POINT OF THEIR DEPICTION. THIS INFORMATION IS SURVEYED TO APPLICABLE TOLERANCES DEFINED BY THE PROJECT AND REDUCED ONTO PLAN DOCUMENTS.

UTILITY QUALITY LEVEL C

INFORMATION OBTAINED BY SURVEYING AND PLOTTING VISIBLE ABOVE-GROUND UTILITY FEATURES AND BY USING PROFESSIONAL JUDGMENT IN CORRELATING THIS INFORMATION TO QUALITY LEVEL D INFORMATION.

UTILITY QUALITY LEVEL D

INFORMATION DERIVED FROM EXISTING RECORDS OR ORAL RECOLLECTIONS.

UTILITY NOTES

- 1 FACILITIES (UTILITY LINES) SHALL BE LOCATED AND MARKÈD PRIOR TO ÉXCAVATION. CALL (800) 90-BELOW.
- (2) CONTRACTOR SHALL HAND-EXPOSE TO A POINT OF NO CONFLICT 24" ON EITHER SIDE OF THE UNDERGROUND FACILITY, REGARDLESS OF THE ESTIMATED DEPTH.
- (3) DEPTHS SHOWN ARE APPROXIMATE. ESTIMATED DEPTHS ARE FROM THE GROUND SURFACE TO THE CENTER OF THE FACILITY, INVERT OF WASTE LINES, OR TO THE FACILITY TRACER WIRE. DEPTH ESTIMATES SHOULD BE USED WITH CAUTION AND MAY VARY ALONG THE LENGTH OF THE FACILITY.
- (4) UTILITY BRACKETS ARE SHOWN TO DEMONSTRATE MULTIPLE LINES TRAVELING TOGETHER IN EITHER A DUCTBANK OR BUNDLE.
- (5) THE SCOPE OF THIS SURVEY DOES NOT INCLUDE FACILITY SIZE OR NUMBER OF CONDUIT IN MULTIPLE CONDUIT RUNS. IRRIGATION LINES ARE NOT INCLUDED IN THIS SURVEY.
- (6) THE BACKGROUND SITE PLAN USED IN PREPARING THIS MAP WAS PREPARED BY OTHERS AND PROVIDED TO C BELOW BY THE CLIENT. C BELOW MAKES NO REPRESENTATION AS TO THE ACCURACY OF THE PLAN.
- (7) IN THE EVENT THE INFORMATION SHOWN IN THIS PLAN VARIES FROM THE ACTUAL SITE CONDITIONS, C BELOW SHALL BE NOTIFIED WITHIN 24 HOURS AFTER DISCOVERY OF THE CONFLICT.

: 909-606-6555

www.cbelow.com

UNDERGROUND UTILITY MAP


WITHIN THE CITY OF OXNARD, COUNTY OF VENTURA, CALIFORNIA PREPARED FOR:

OXNARD UNION HIGH SCHOOL DISTRICT



NOT TO SCALE

ELECTRICAL — E — — —

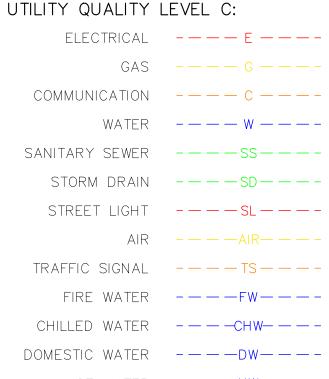



UNDERGROUND LINE LEGEND

UTILITY QUALITY LEVEL B:

POSSIBLE LINE LOCATION, BASED

ON GPR DETECTION

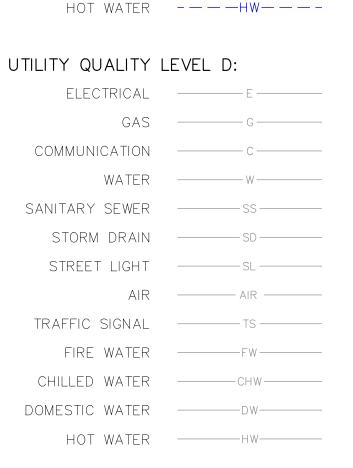

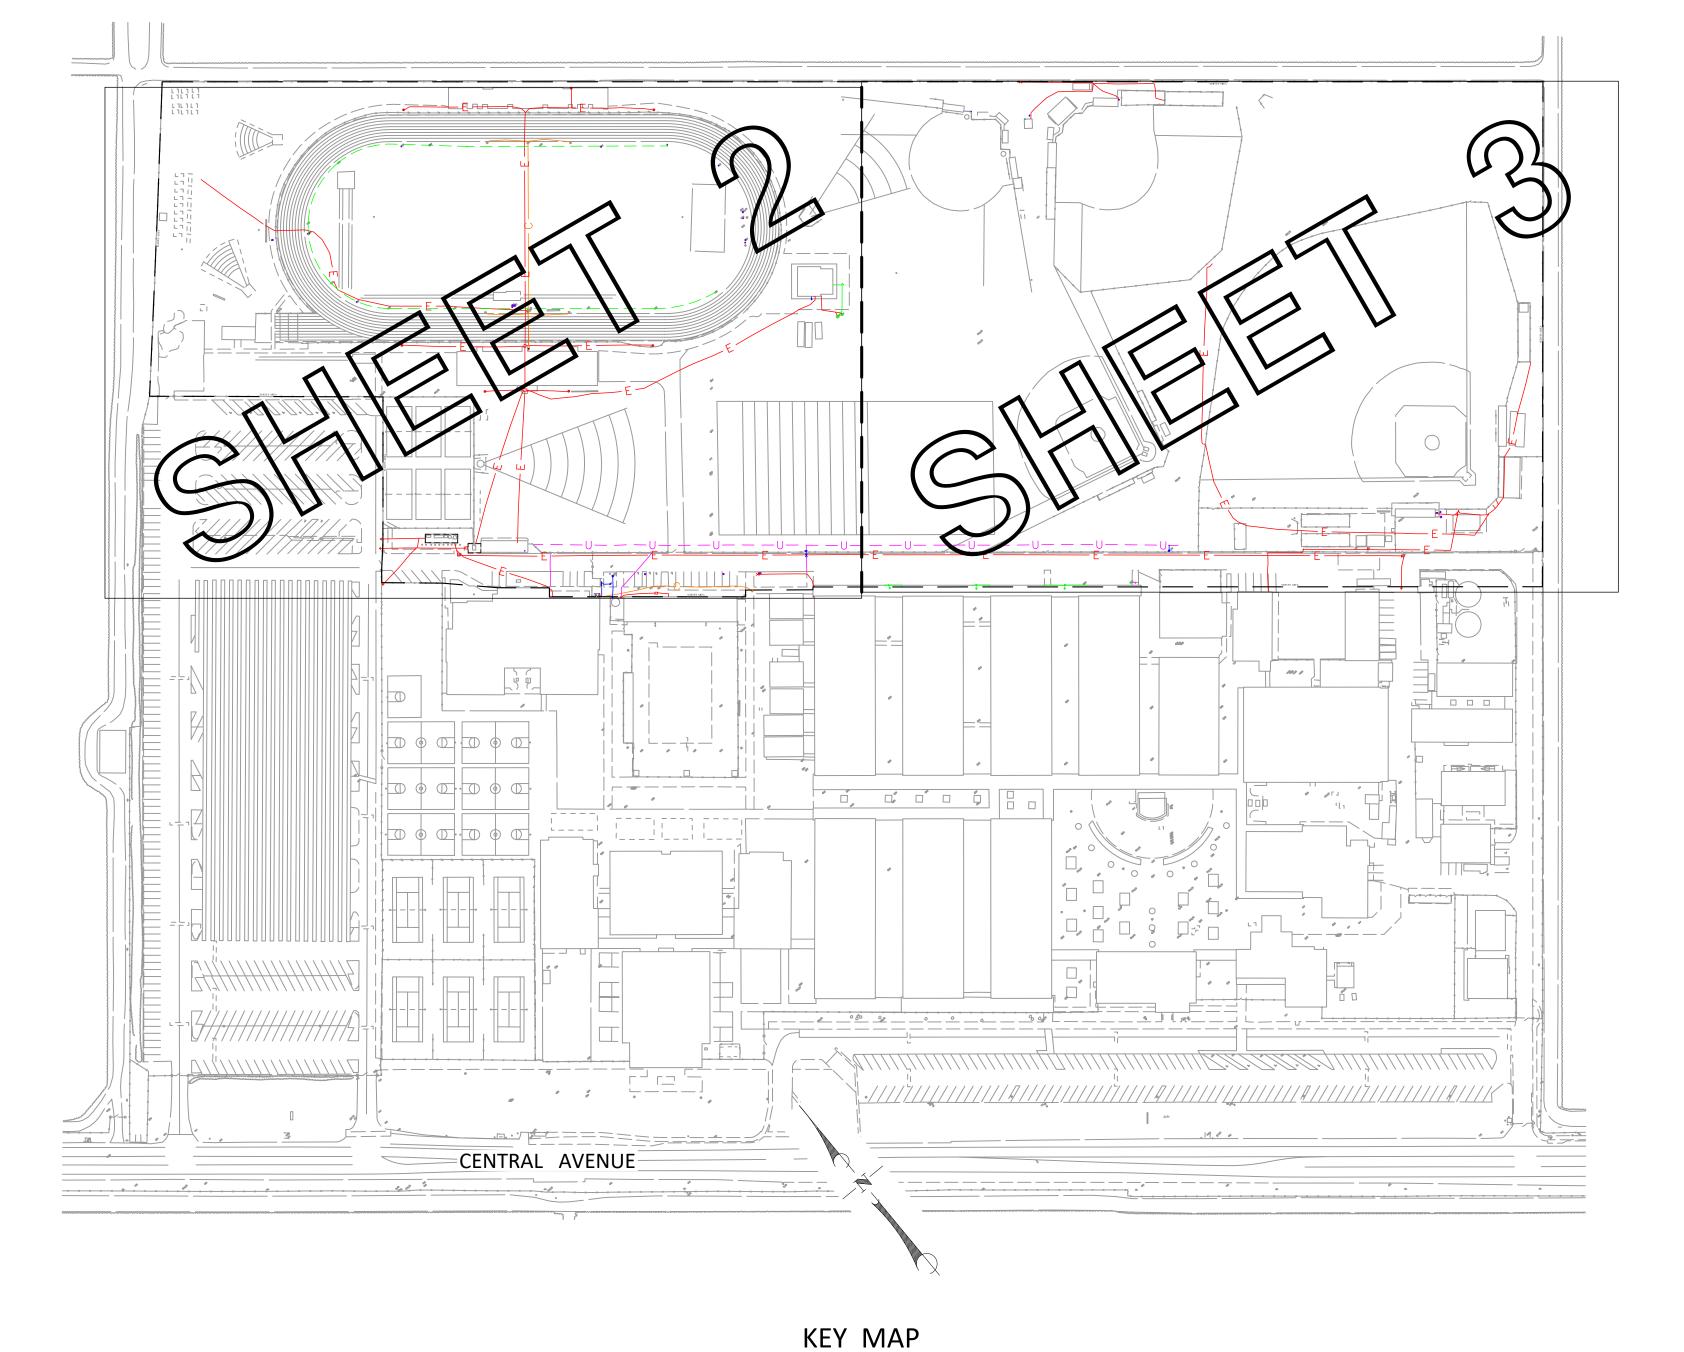

KEY NOTES

NON-CONDUCTIVE, UNABLE TO LOCATE PAST THIS POINT.

NO ACCESS, UNABLE TO LOCATE PAST THIS POINT.

(3) BLOCKED

4 AT BUILDING

5 AT DROP

6 AT RISER

ABBREVIATIONS

BACKFLOW PREVENTER CAB CABINET

CLEAN OUT

ELECTRIC GROUND

ELECTRIC

ICV IRRIGATION CONTROL

MANHOLE

PULL BOX

STORM DRAIN SANITARY SEWER

UNK UNKNOWN

WATER VALVE

LEGEND/SYMBOL

BACKFLOW PREVENTER

CLEAN OUT √1'-6" DEPTH FROM SURFACE

FIRE HYDRANT

LIGHT POLE MANHOLE

PULL BOX

VALVE

VAULT

UTILITY DEPICTION

UNDERGROUND UTILITY DEPICTION SHOWN HEREON IS BASED ON LOCAL CONTROL AND/OR ON THE SMARTNET RTK NETWORK, UNLESS STATED OTHERWISE.



BELOW SUBSURFACE IMAGING 14280 EUCLID AVE CHINO, CA 91710 / GROUND PENETRATING RADAR (GPR) UTILITY LOCATING RADIOGRAPHY P: 888-902-3569

POTHOLING

MAPPING


NOTES: The services provided by C Below, Inc. do not relieve the Client and/or property owner of the responsibility of having to comply with California Government Code §§4216-4216.9. It is expressly understood by the Client and/or owner that CBSI services are not a substitute for compliance with California Code §§4216-4216.9.

PARTIAL UNDERGROUND UTILITY MAP FOR: RIO MESA HIGH SCHOOL **545 CENTRAL AVENUE** OXNARD, CA 93036

OXNARD UNION HIGH SCHOOL DISTRICT 309 S. "K" STREET OXNARD, CA 93030

NOT TO SCALE

CLIENT:

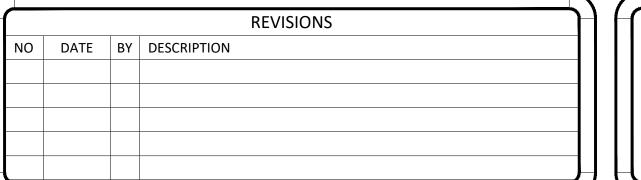



DATE LOCATED: 10/2019 DRAWN BY/DATE: LB 10/14/2019 TECHNICIAN QC CHECKED BY/DATE: OG 10/15/2019

CHECK BY/DATE: D. MONTES SHEET 1 OF 2 DRAWING NAME: COVER SHEET

SCALE: N.T.S.


PROJECT NO: 19-0972

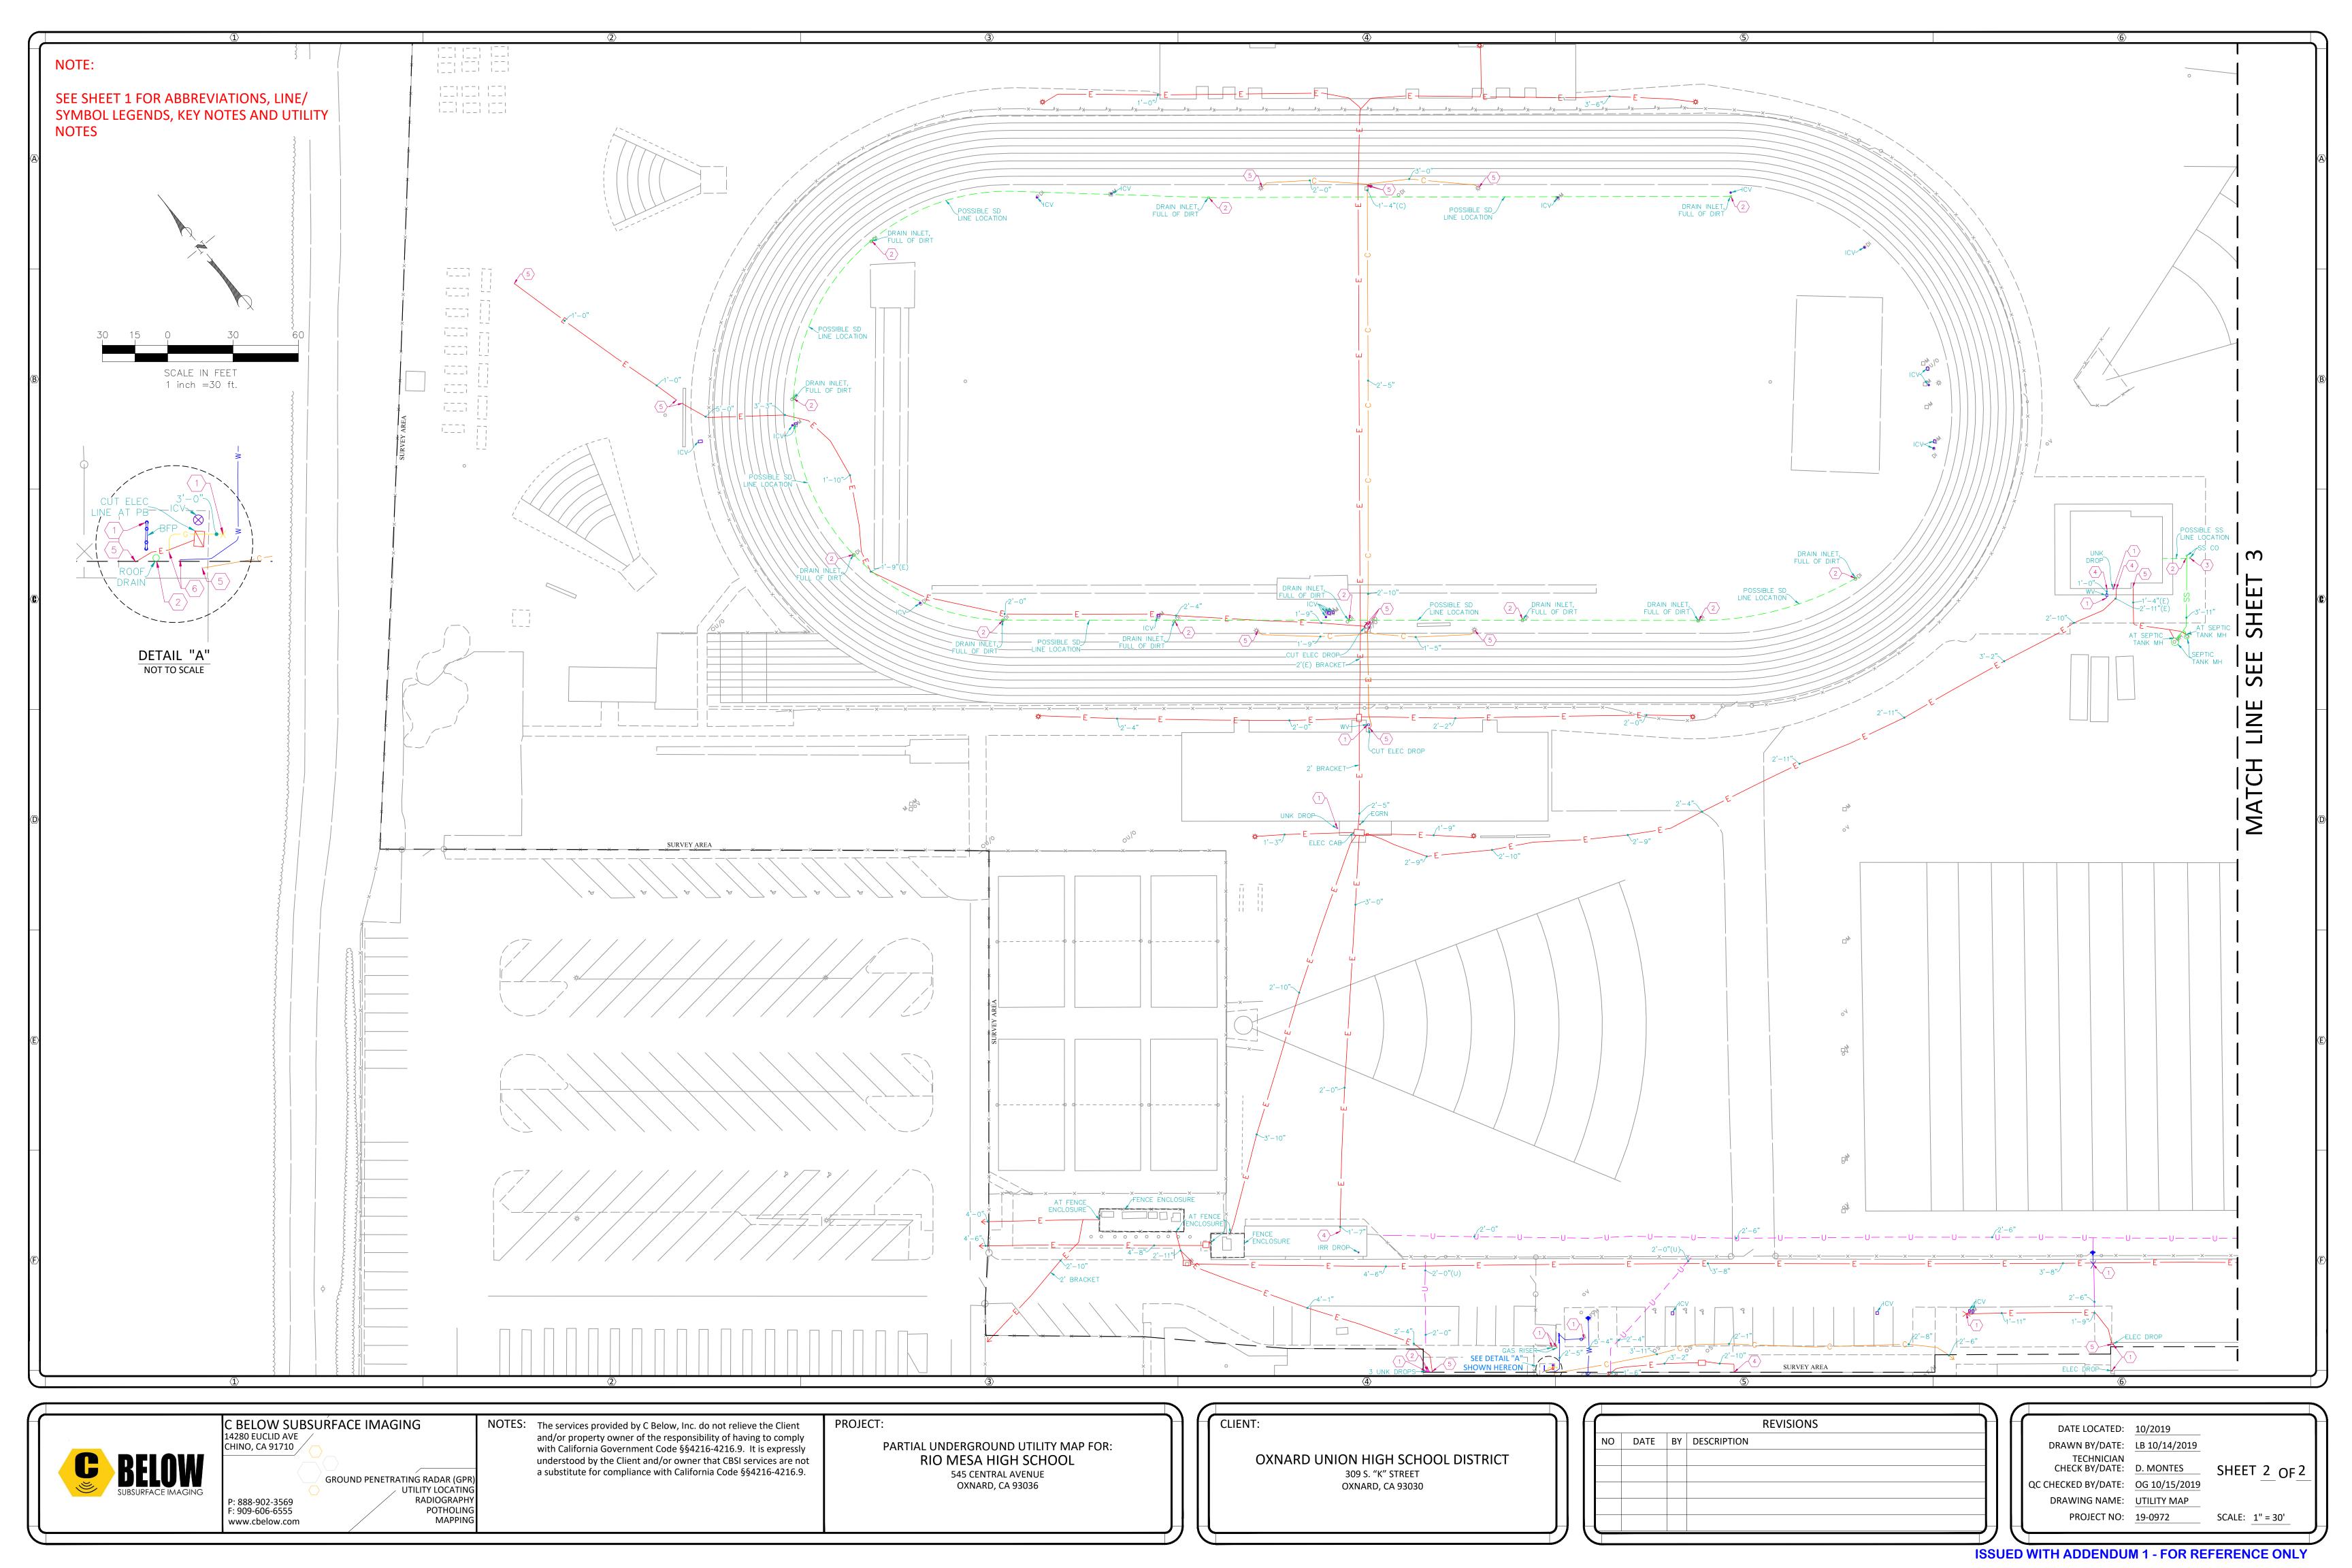


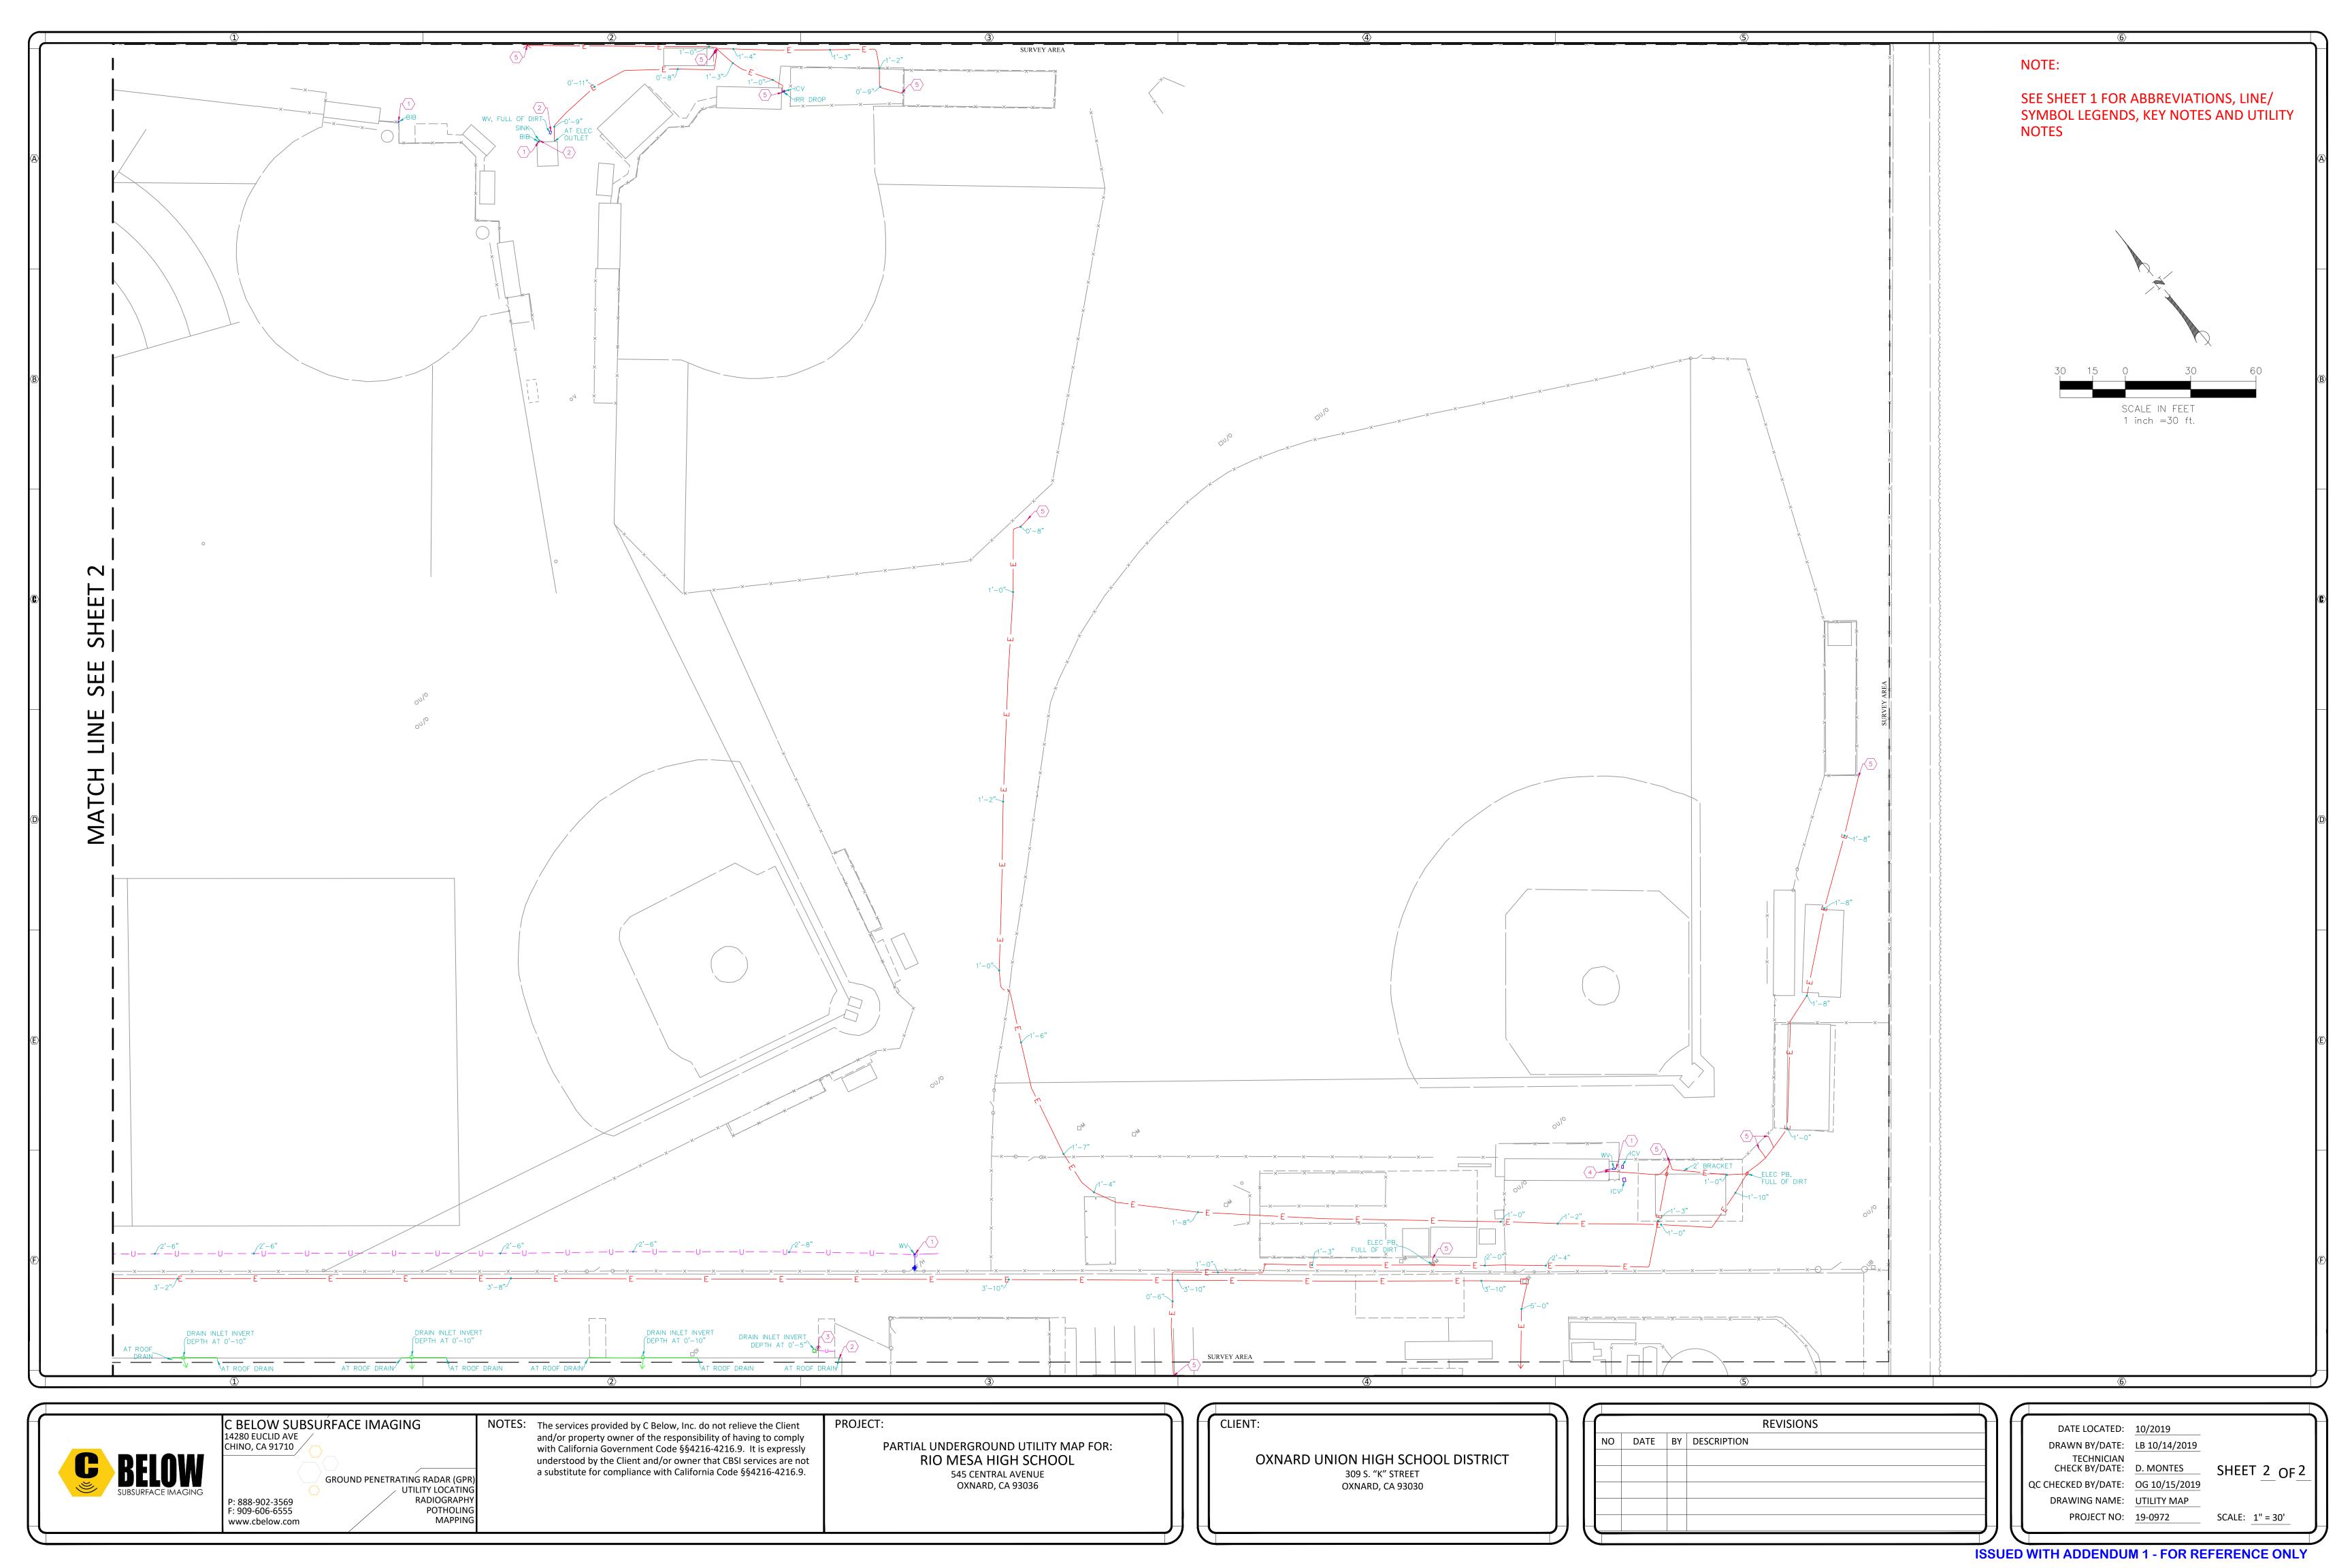

TOPOGRAPHIC SITEPLAN

RIO MESA HIGH SCHOOL OXNARD, CA

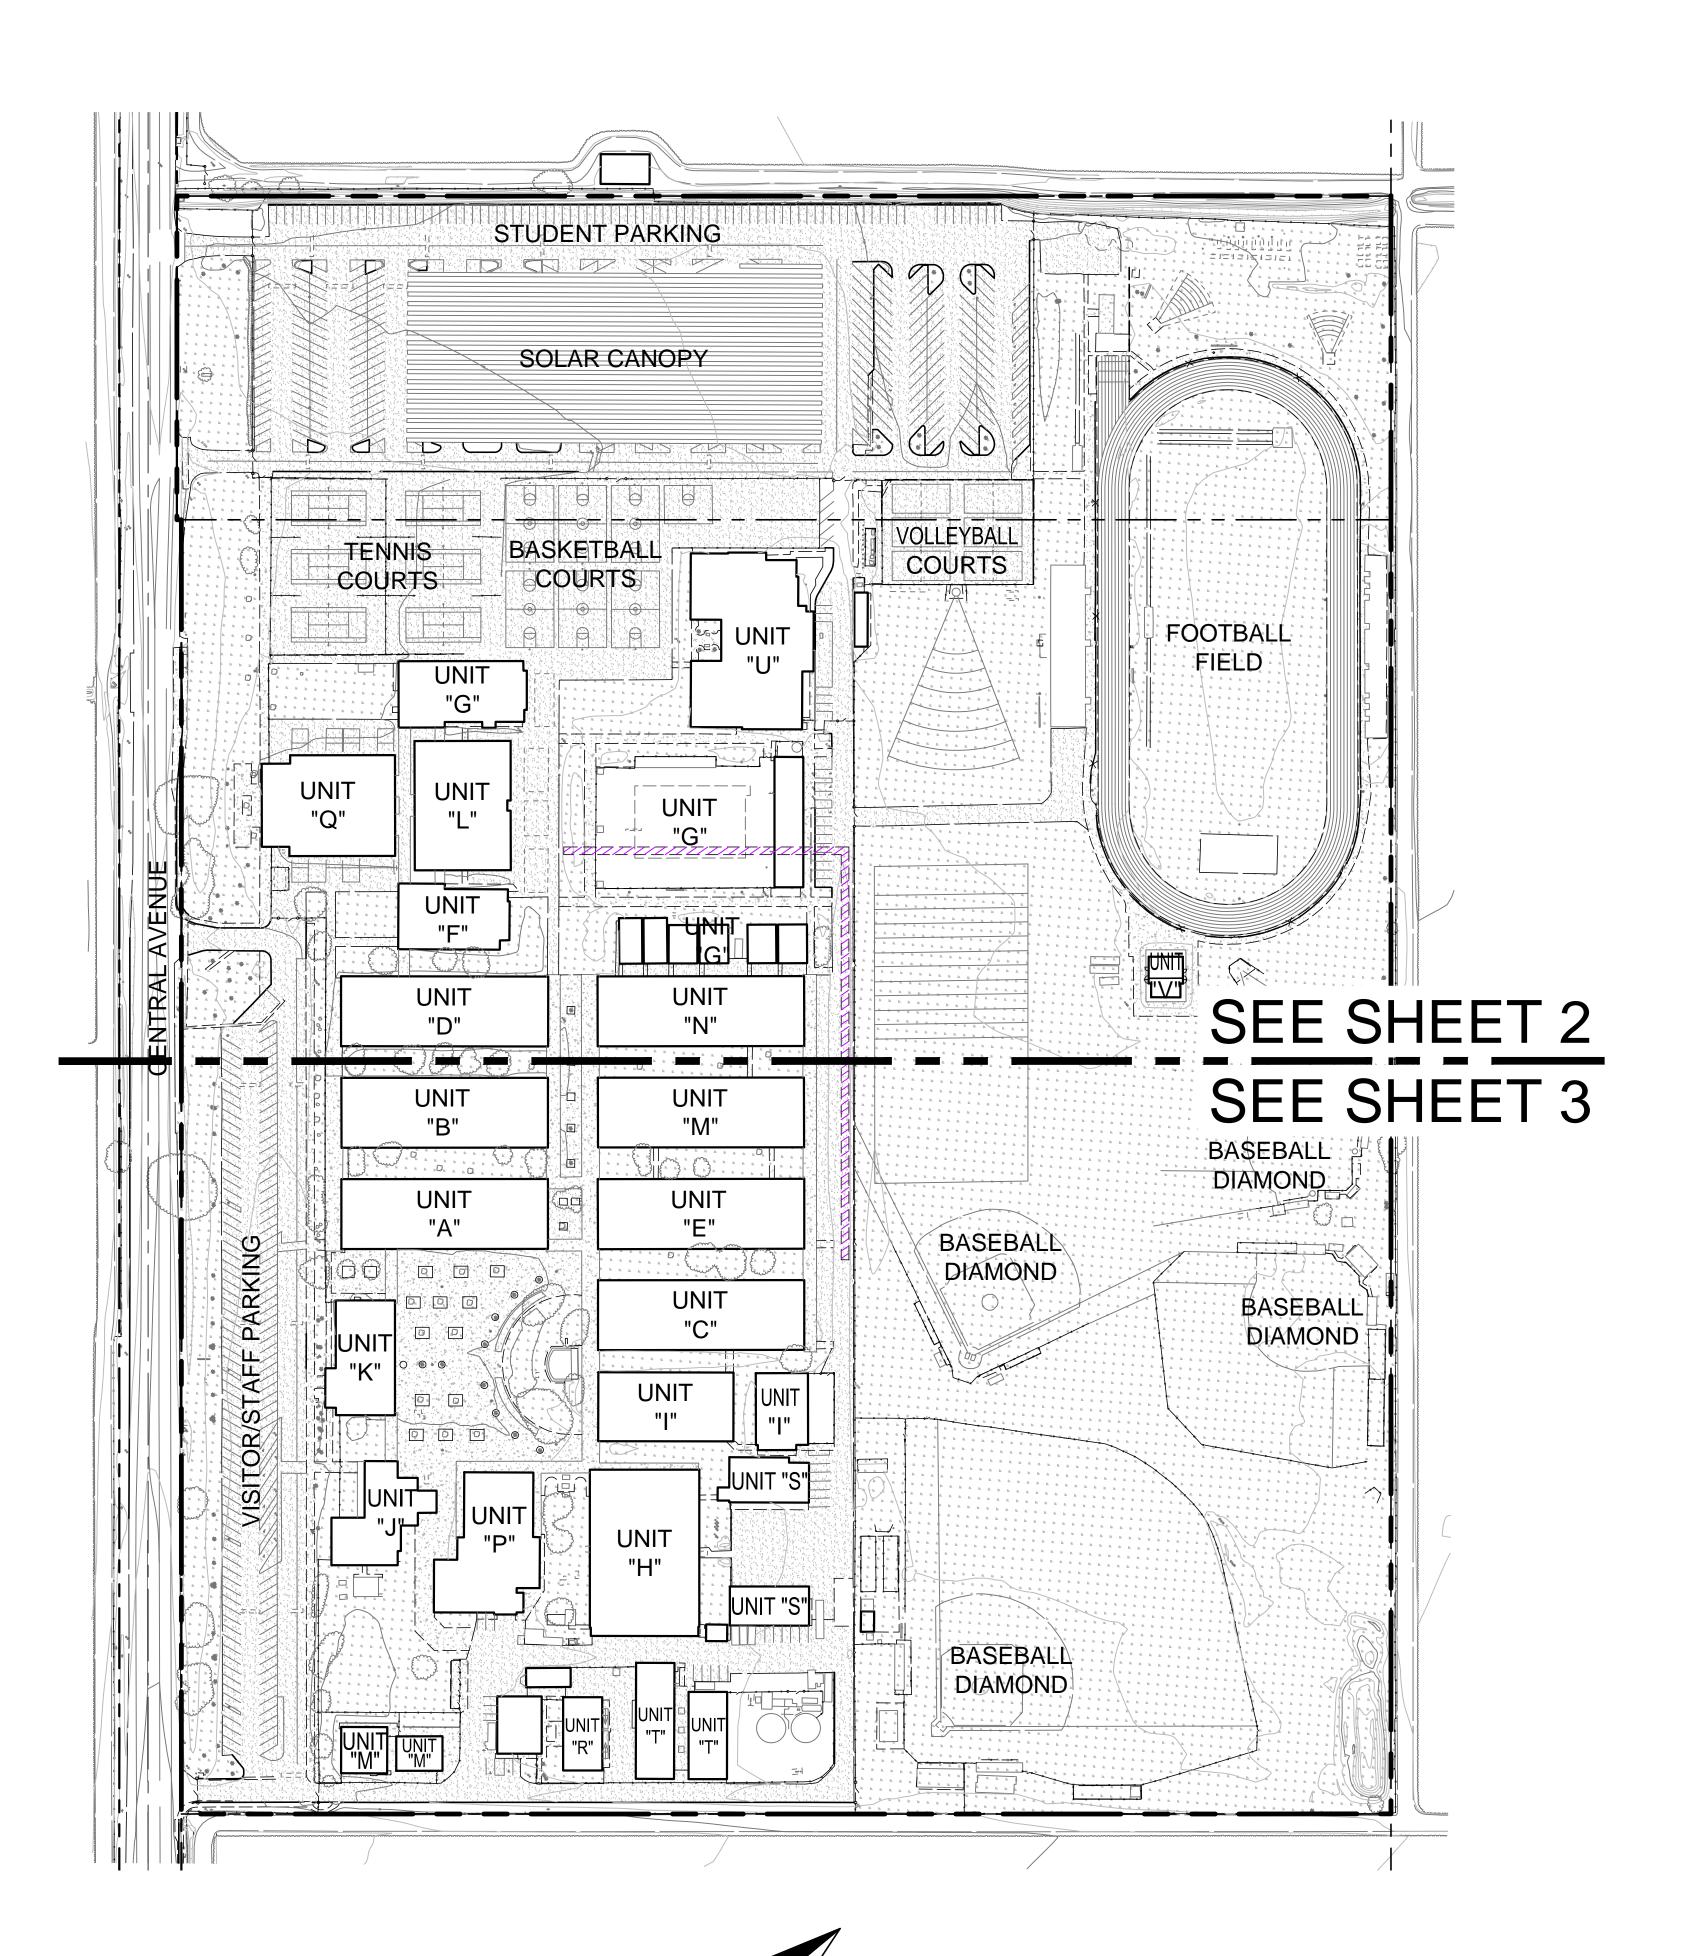

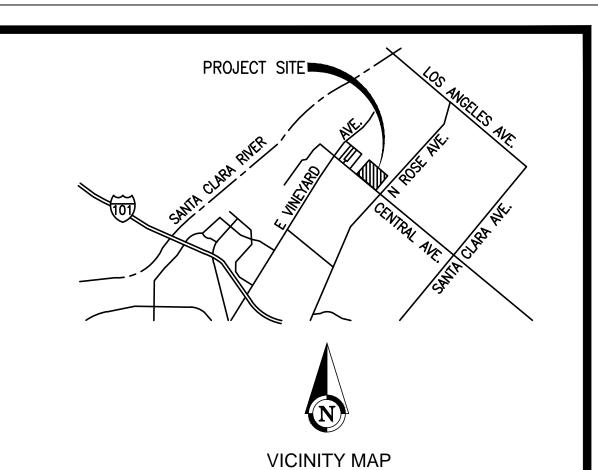

LEGAL DESCRIPTION (FROM TITLE REPORT) ALL THAT CERTAIN REAL PROPERTY SITUATED IN THE COUNTY OF VENTURA, STATE OF CALIFORNIA, DESCRIBED AS FOLLOWS:

THAT PORTION OF LOT 98, RANCHO SANTA CLARA DEL NORTE, IN THE COUNTY OF VENTURA, STATE OF CALIFORNIA, ACCORDING TO THE MAP THEREOF RECORDED IN BOOK 3 PAGE 26 OF MAPS, IN THE OFFICE OF THE COUNTY RECORDER OF SAID COUNTY, DESCRIBED AS FOLLOWS:

BEGINNING AT A POINT ON THE NORTHEASTERLY LINE OF CENTRAL AVENUE, 60 FEET WIDE, DISTANT ALONG SAID NORTHEASTERLY LINE SOUTH 50° 20' EAST 3336.96 FEET FROM THE INTERSECTION OF SAID NORTHEASTERLY LINE WITH THE SOUTHEASTERLY LINE OF VINEYARD AVENUE, 50 FEET WIDE, AT THE MOST WESTERLY CORNER OF THE LAND DESCRIBED IN THE DEED TO JOHN A. LAGOMARSINO AND WIFE, RECORDED JANUARY 13, 1937 IN BOOK 514 PAGE 323 OF OFFICIAL RECORDS; THENCE CONTINUING ALONG SAID NORTHEASTERLY LINE,

1ST: — SOUTH 50° 20' EAST 346 FEET; THENCE PARALLEL WITH THE NORTHWESTERLY LINE OF SAID LAND OF JOHN A. LAGOMARSINO, 2ND: — NORTH 39° 40' EAST 1259.94 FEET TO THE NORTHEASTERLY LINE OF SAID LOT 98; THENCE ALONG SAID NORTHEASTERLY LINE, 3RD: - NORTH 50° 20' WEST 346 FEET TO THE MOST NORTHERLY CORNER OF SAID LAND OF JOHN A. LAGOMARSINO; THENCE ALONG THE NORTHWESTERLY LINE THEREOF,

4TH: - SOUTH 39' 40' WEST 1259.94 FEET TO THE POINT OF EXCEPT ALL OIL AND MINERAL RIGHTS BELOW 500 FEET FROM THE PRESENT SURFACE BUT WITHOUT RIGHT OF SURFACE ENTRY THEREIN, AS RESERVED BY JOHN A. LAGOMARSINO AND IDA CLAIRE LAGOMARSINO, HUSBAND AND WIFE, IN DEED RECORDED NOVEMBER 4, 1960 AS INSTRUMENT NO. 44425, OF OFFICIAL RECORDS.

PART OF LOT 98, RANCHO SANTA CLARA DEL NORTE, IN THE COUNTY OF VENTURA, STATE OF CALIFORNIA, AS PER MAP RECORDED IN BOOK 3 PAGE 26 OF MAPS, IN THE OFFICE OF THE COUNTY RECORDER OF SAID COUNTY, DESCRIBED AS FOLLOWS:

BEGINNING AT A POINT IN THE NORTHEASTERLY LINE OF CENTRAL AVENUE, AT THE SOUTHEAST CORNER OF THAT CERTAIN TRACT OF LAND CONVEYED TO OXNARD CITRUS ASSOCIATION IN DEED RECORDED IN BOOK 511 PAGE 283 OF OFFICIAL RECORDS, SAID POINT BEING DISTANT SOUTH 50° 20' EAST 1066.07 FEET FROM A 6" X 6" REDWOOD POST MARKED "LOT 98" AND "G.C.P." AT THE POINT O INTERSECTION OF SAID NORTHEASTERLY LINE OF CENTRAL AVENUE WITH THE SOUTHEASTERLY LINE OF VINEYARD AVENUE; THENCE FROM SAID POINT OF BEGINNING,

1ST: — NORTH 39° 40' EAST 1264.50 FEET, ALONG THE EASTERLY LINE OF THE LAND DESCRIBED IN SAID DEED TO A POINT IN THE NORTHEASTERLY LINE OF SAID LOT 98; THENCE,

2ND: - SOUTH 50° 20' EAST 2270.89 FEET, MORE OR LESS, ALONG THE NORTHEASTERLY LINE OF SAID LOT 98, TO THE MOST NORTHERLY CORNER OF THE PARCEL OF LAND CONVEYED TO JOHNA. LAGOMARSINO AND WIFE, IN DEED RECORDED IN BOOK 514 PAGE 323, OF OFFICIAL

3RD: — SOUTH 39° 40' WEST 1264.50 FEET, ALONG THE NORTHWESTERLY LINE OF THE LAND DESCRIBED IN SAID LAST-MENTIONED DEED, TO A POINT IN THE NORTHEASTERLY LINE OF SAID CENTRAL AVENUE; THENCE, 4TH: - NORTH 50° 20' WEST 2270.89 FEET, MORE OR LESS, ALONG SAID NORTHEASTERLY LINE, TO THE POINT OF BEGINNING. EXCEPT THAT PORTION THEREOF DESCRIBED IN THE DEED TO W. ROY GUYER AND WIFE, RECORDED IN BOOK 606 PAGE 279 OF OFFICIAL

ALSO EXCEPT THAT PORTION THEREOF CONVEYED TO BRYAN K. COMPTON AND FAYNELL COMPTON IN DEED RECORDED FEBRUARY 4, 1948 AS DOCUMENT NO. 2020 IN BOOK 819 PAGE 137 OF OFFICIAL

ALSO EXCEPT ALL OIL AND MINERAL RIGHTS BELOW 500 FEET FROM THE PRESENT SURFACE BUT WITHOUT THE RIGHT OF SURFACE ENTRY THEREIN AS RESERVED BY JAMES R. LAGOMARSINO AND FLORENCE LAGOMARSINO, HUSBAND AND WIFE, IN DEED RECORDED NOVEMBER 4 1960 AS INSTRUMENT NO. 44424, OF OFFICIAL RECORDS. APN: 147-0-060-325

TOPOGRAPHY

EXISTING SITE TOPOGRAPHY HAS BEEN GENERATED FROM FROM AN AERIAL SURVEY COMPILED FROM PHOTOGRAPHY BY ARROWHEAD MAPPING CORPORATION DATED MARCH 29, 2019 AND FIELD TOPOGRAPHIC SURVEY PERFORMED BY ARMSTRONG & BROOKS CONSULTING ENGINEERS, INC. DATED MAY 30, 2019.

BENCHMARK

CITY OF OXNARD 110-4 ELEVATION: 113.962

DESCRIPTION: BRASS DISK STAMPED "110-4 1977"

LOCATION: BRASS DISK STAMPED "110-4 1985" SET FLUSH IN TOP AND MIDDLE OF CONCRETE CURB RETURN AT NORTHEASTERLY CORNER OF THE INTERSECTION OF VINEYARD AVENUE AND CENTRAL AVENUE.

BASIS OF BEARING

N50°24'28"W BEING THE CENTERLINE OF CENTRAL AVENUE PER EASEMENT DEED RECORDED AS INSTRUMENT NUMBER 03-337299 OF OFFICIAL RECORDS, IN THE OFFICE OF THE COUNTY RECORDER OF VENTURA COUNTY, STATE OF CALIFORNIA.

EXISTING UTILITIES NOTE

THE EXISTENCE AND LOCATION OF ANY UNDERGROUND UTILITY PIPES, CONDUITS, OR STRUCTURES SHOWN ON THESE PLANS WERE OBTAINED BY A SEARCH OF AVAILABLE RECORDS. IN ORDER TO TAKE PRECAUTIONARY MEASURES TO PROTECT ALL UTILITY LINES SHOWN AND NOT SHOWN ON THESE DRAWINGS, IT IS RECOMMENDED TO CALL IN A LOCATION REQUEST TO UNDERGROUND SERVICE ALERT (USA) PH. 811, TWO (2) WORKING DAYS PRIOR TO ANY DIGGING.

		NTS
SITE	ADDR	ESS

3400 OXNARD ROAD OXNARD, CA 93036

LEGEND — E — EXISTING ELECTRICAL EXISTING COMMUNICATION EXISTING GAS (SIZE PER PLAN) EXISTING SEWER (<12"-SIZE PER PLAN) EXISTING SEWER (>12"-SIZE PER PLAN)

> EXISTING WATER (<12"-SIZE PER PLAN) EXISTING WATER (>12"-SIZE PER PLAN) EXISTING FIRE WATER (SIZE PER PLAN) EXISTING STORM DRAIN (<12"-SIZE PER PLAN) EXISTING STORM DRAIN (>12"-SIZE PER PLAN) EXISTING C.L. FENCE

EXISTING W.I. FENCE EASEMENT (TYPE PER PLAN)

ASPHALT CONCRETE ANGLE POINT AERIAL TARGET BEGIN CURVE BEGINNING BUILDING BENCHMARK

BOTTOM X CENTER LINE CONCRETE CORNER CONTROL POINT END CURVE EDGE OF GUTTER

> ELECTRIC EDGE OF PAVEMENT FINISH FLOOR FINISH GRADE FENCE FINISH SURFACE

IRRIGATION CONTROL BOX

IRRIGATION MONUMENT NORTH EAST

> NORTH WEST PEDESTAL PARALLEL POINT ON LINE SOUTH WEST


STORM DRAIN STREET LIGHT SIDEWALK TOP OF CURB VERIZON


WATER METER WATER VALVE


LANDSCAPED AREA

TOPOGRAPHIC SITEPLAN RIO MESA HIGH SCHOOL


OXNARD, CA

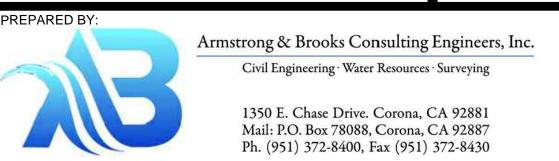


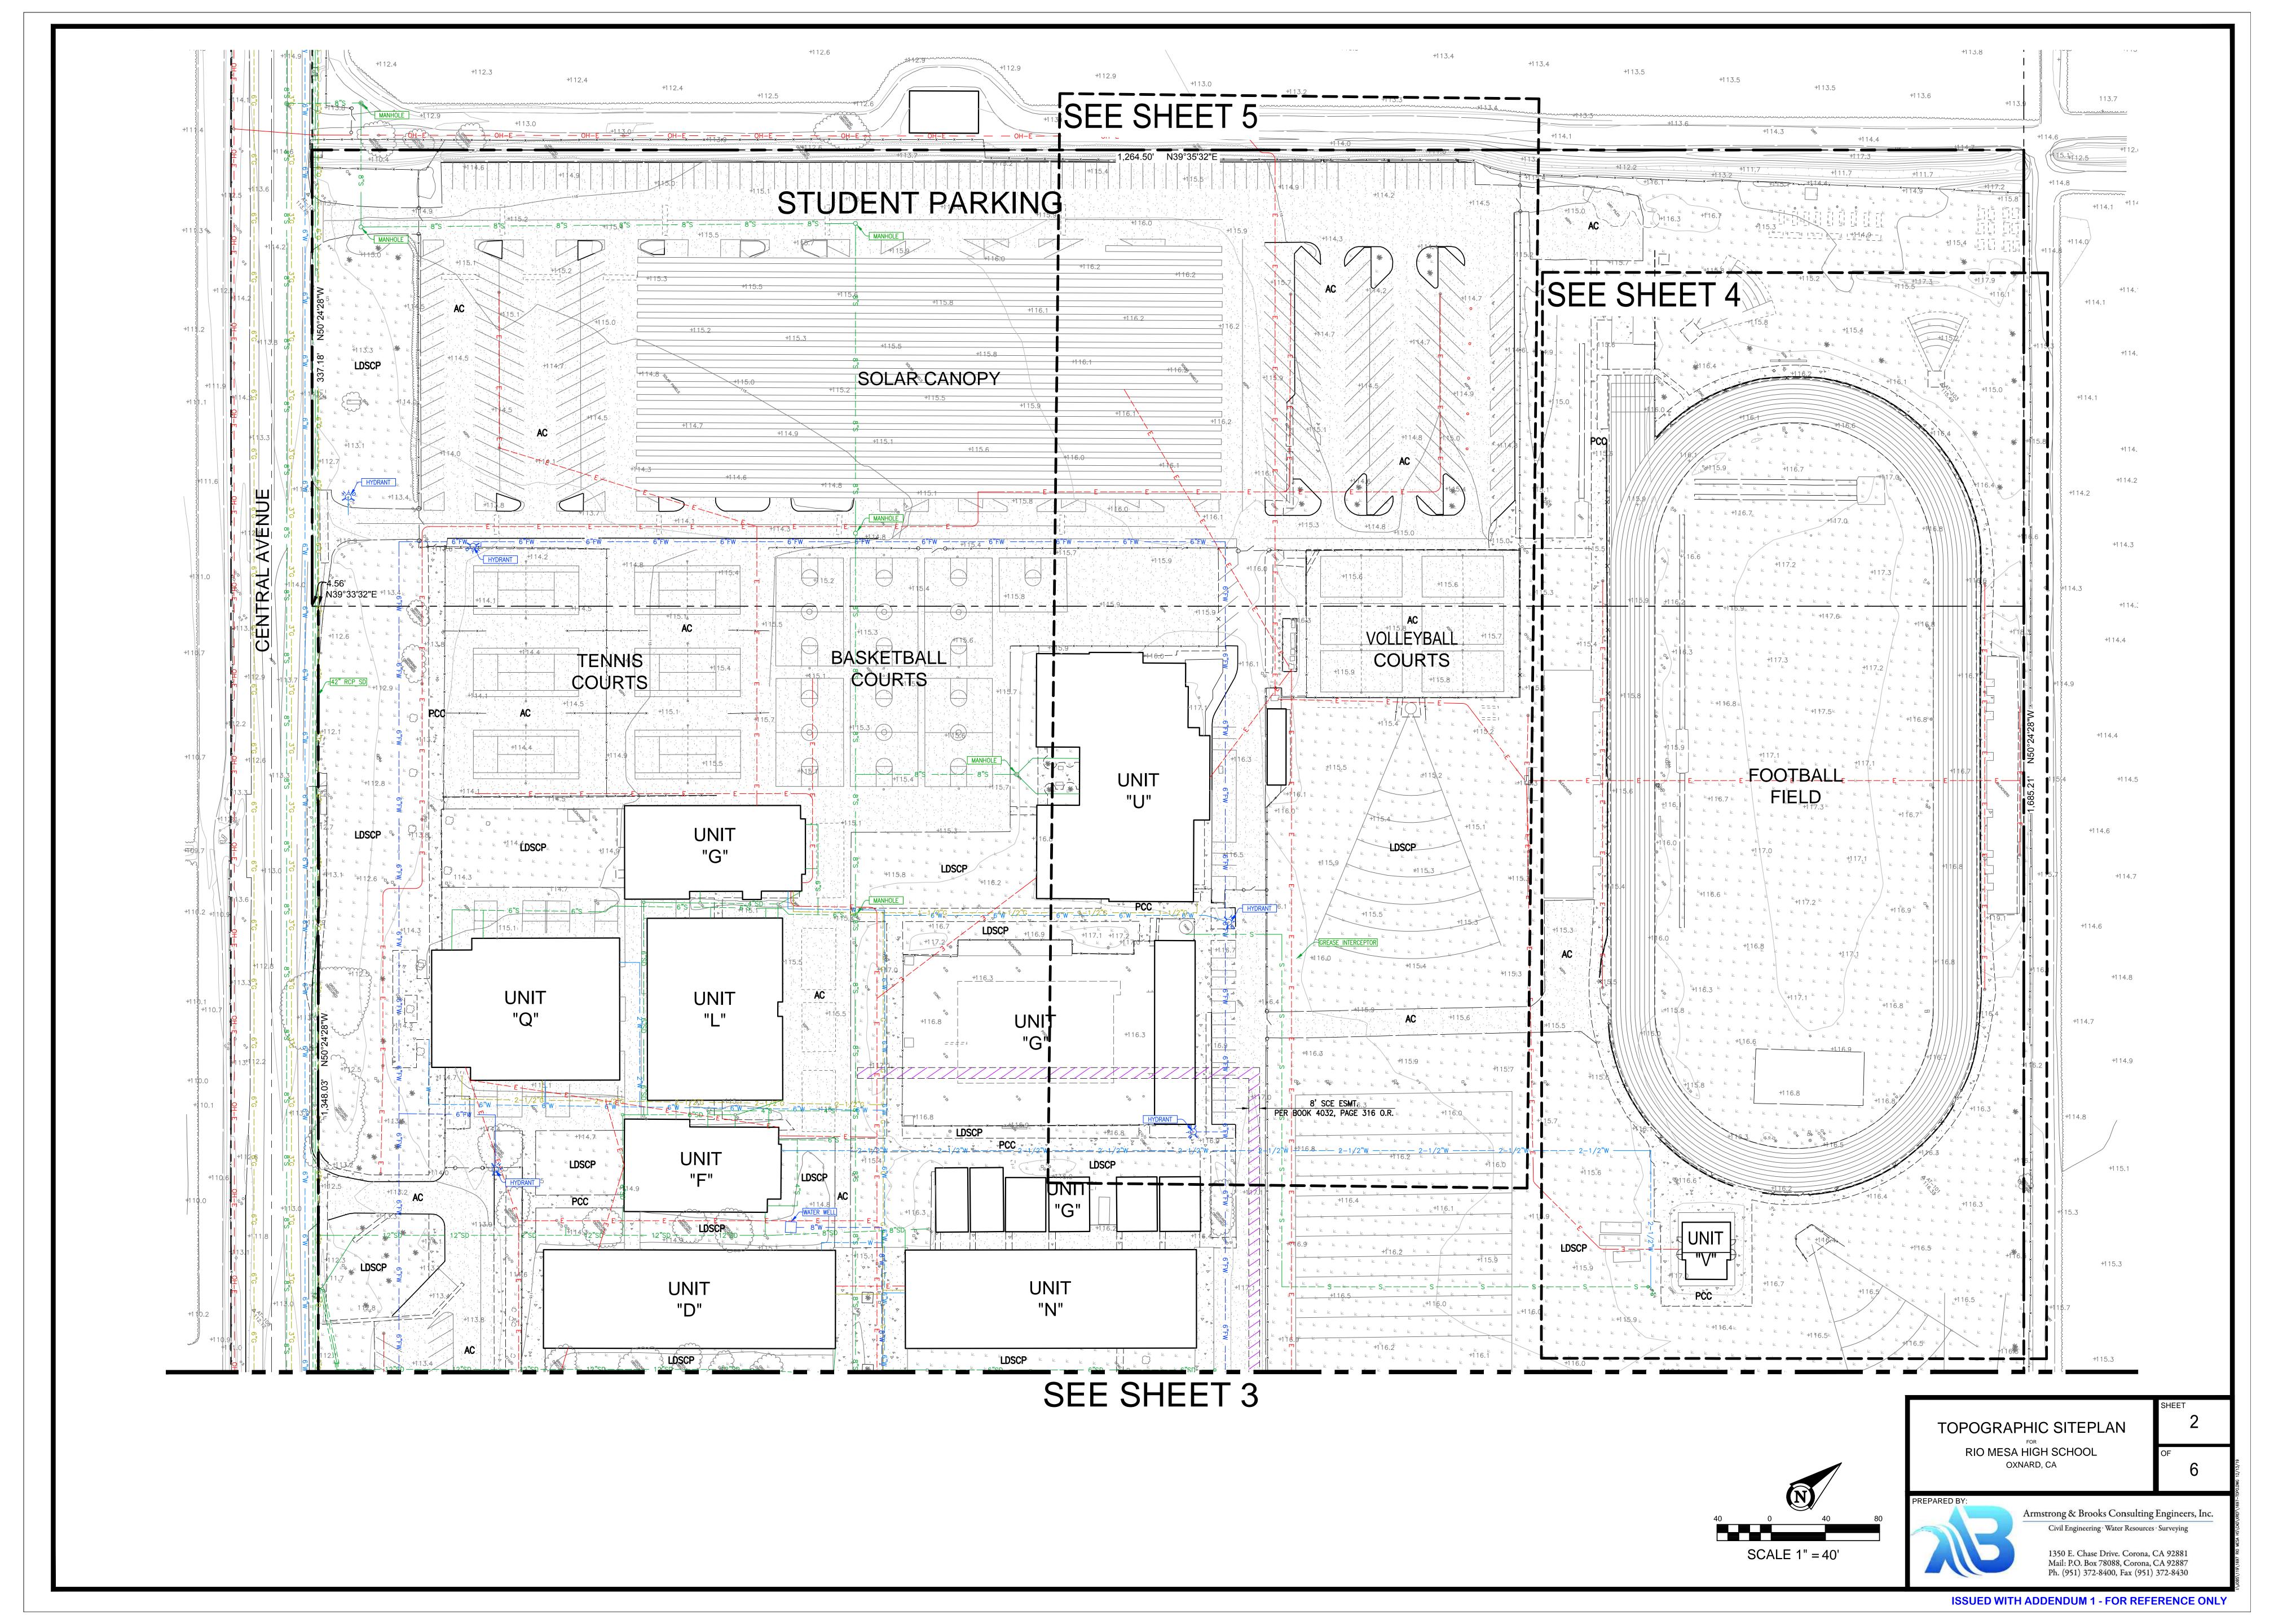


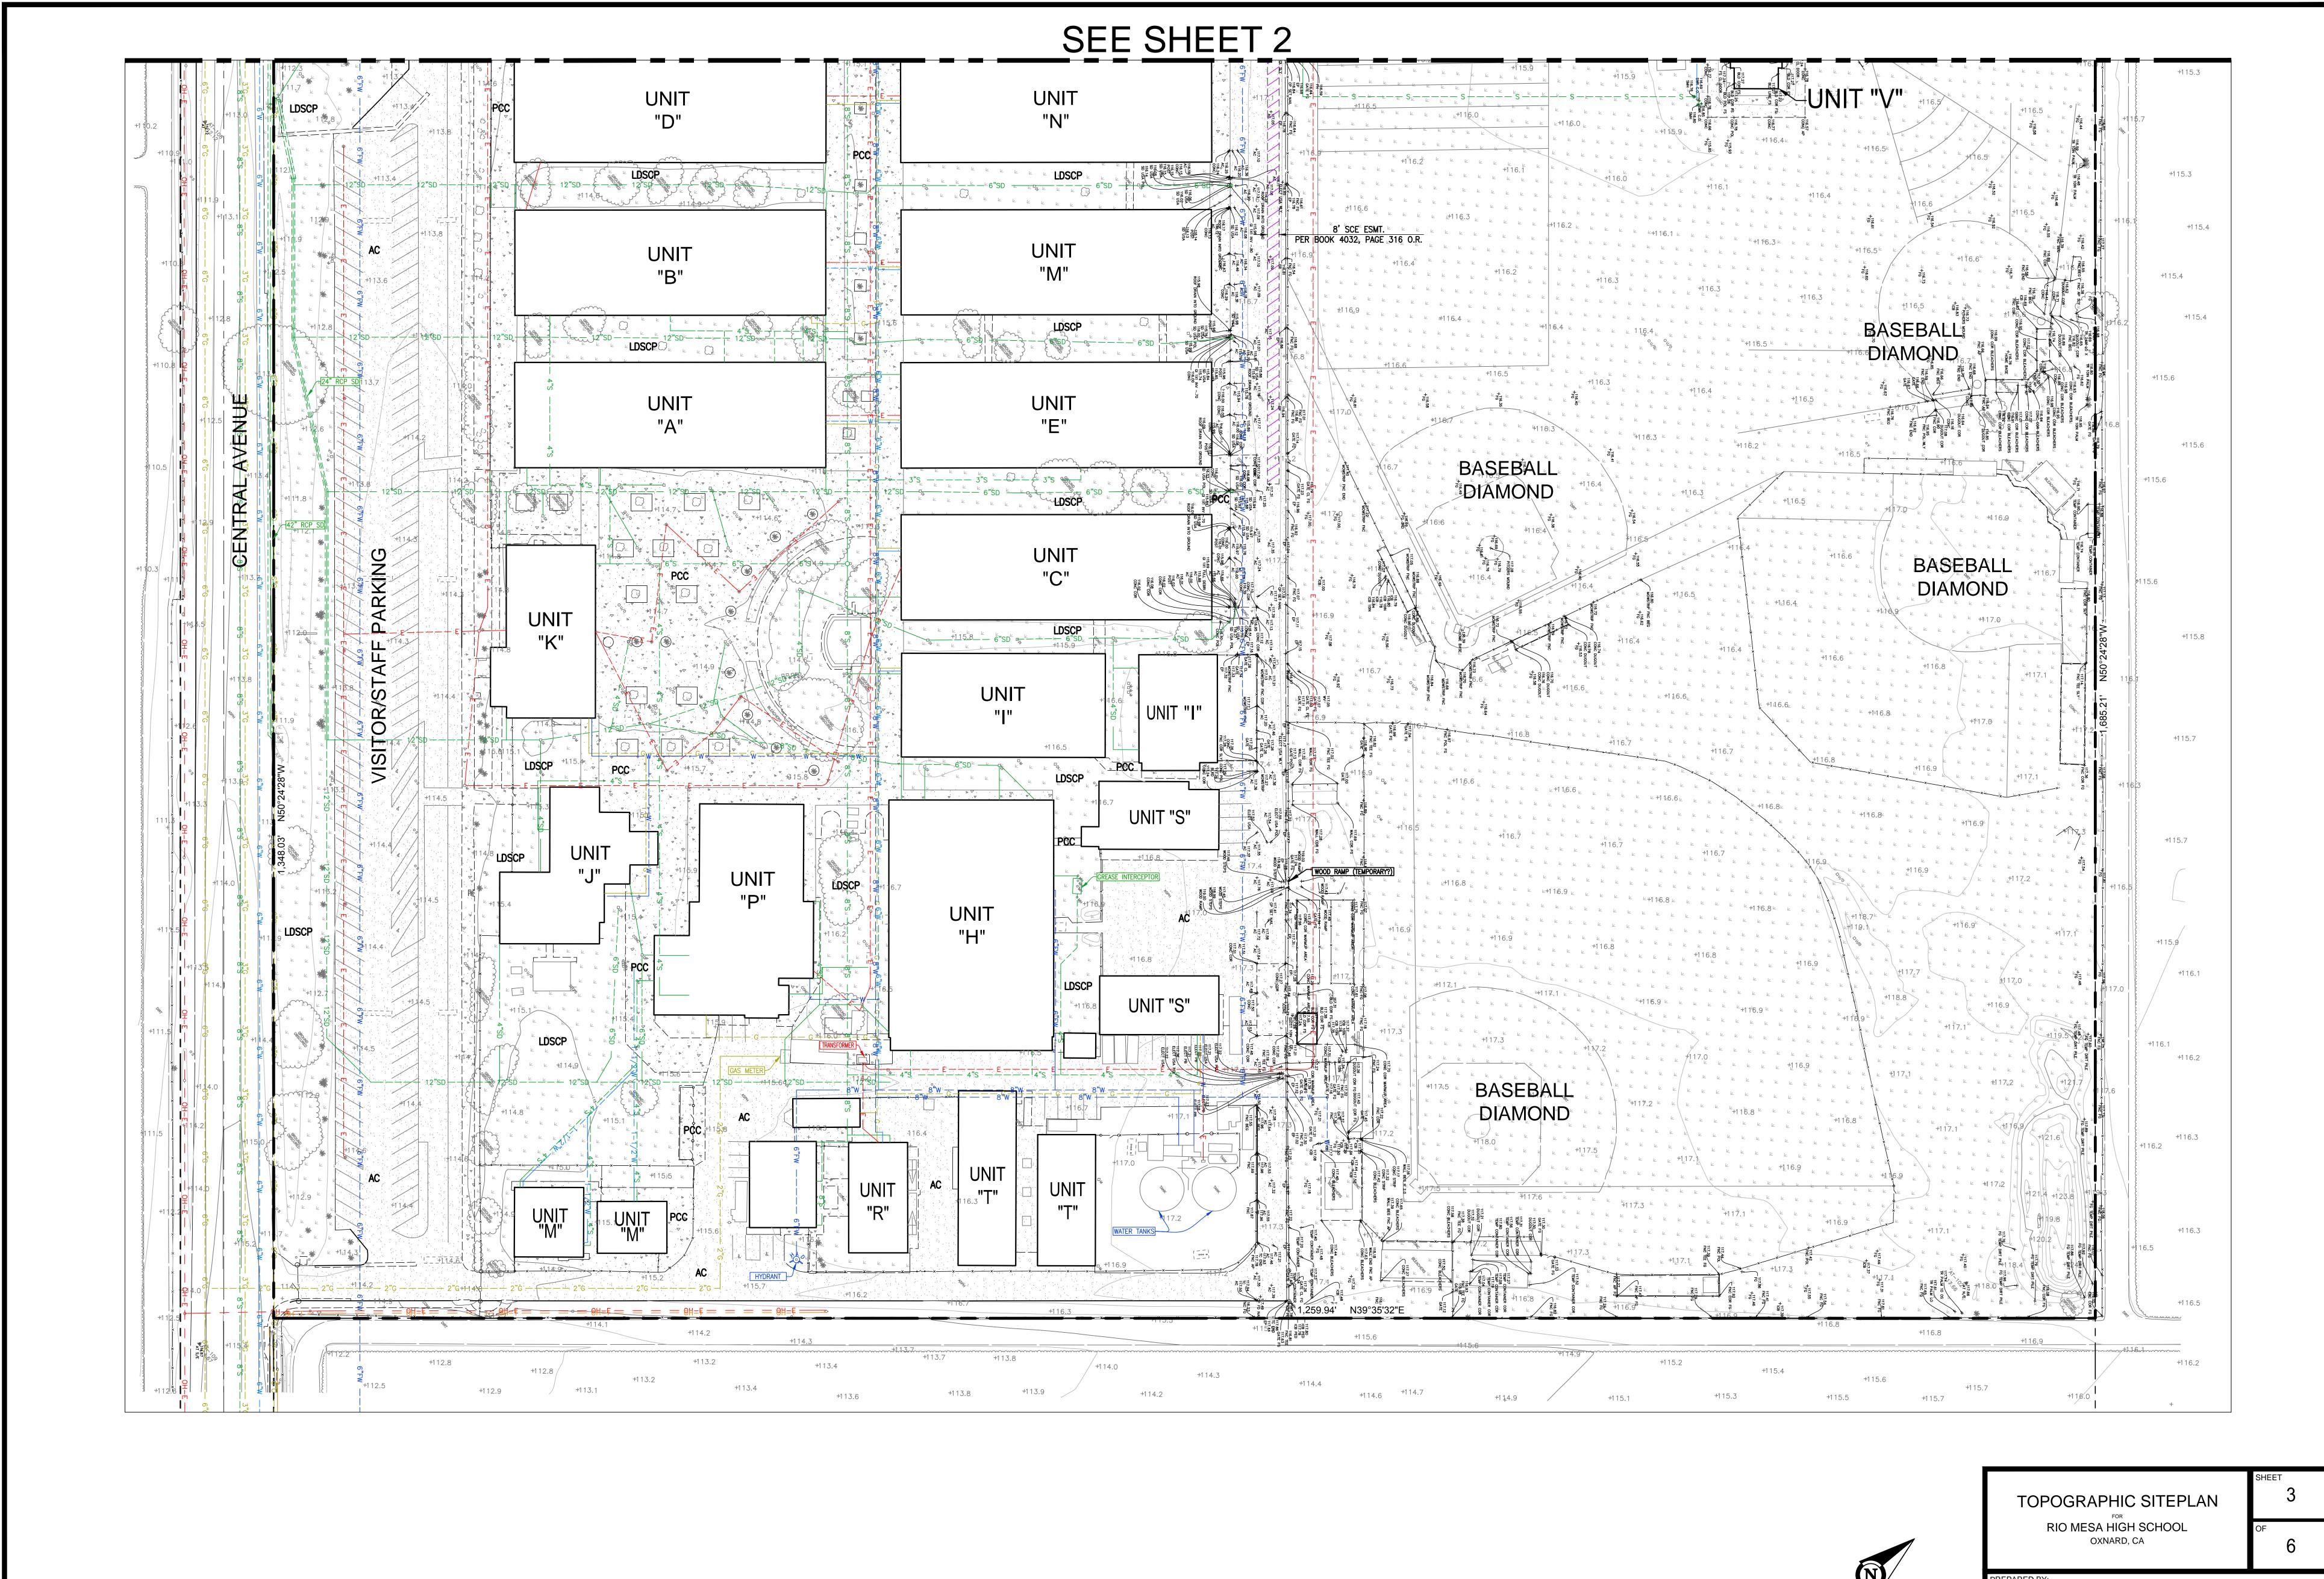




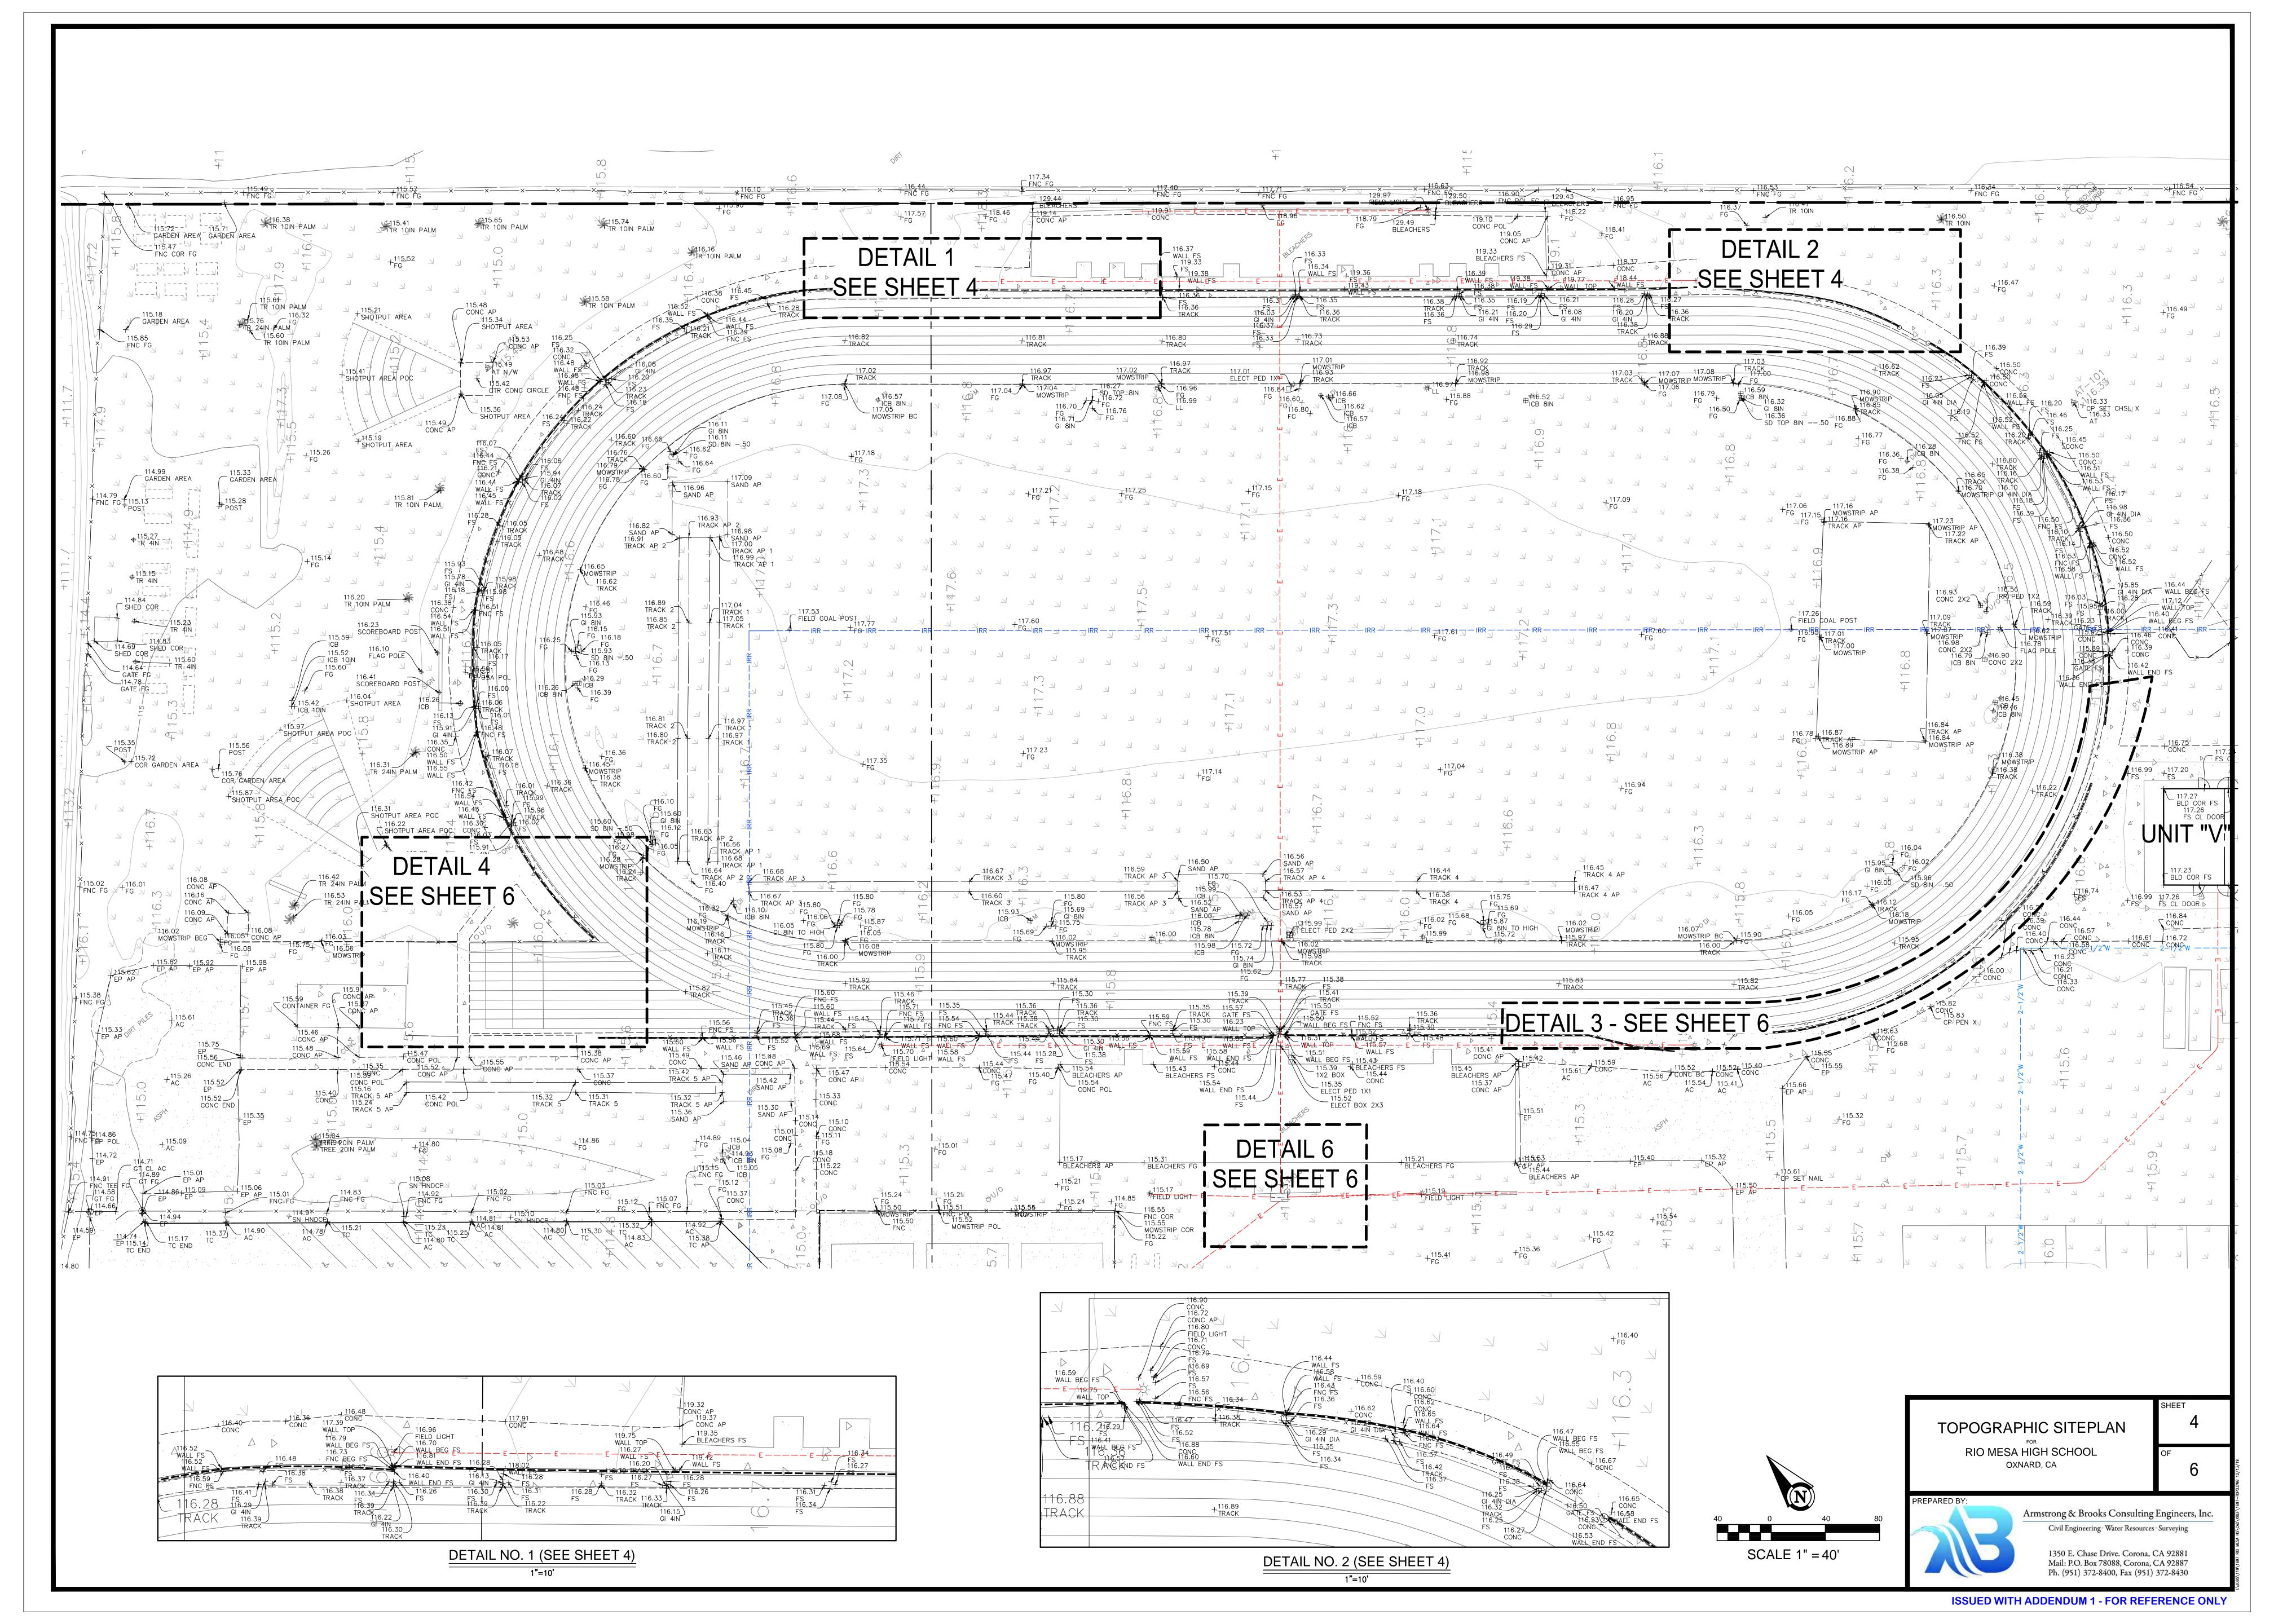

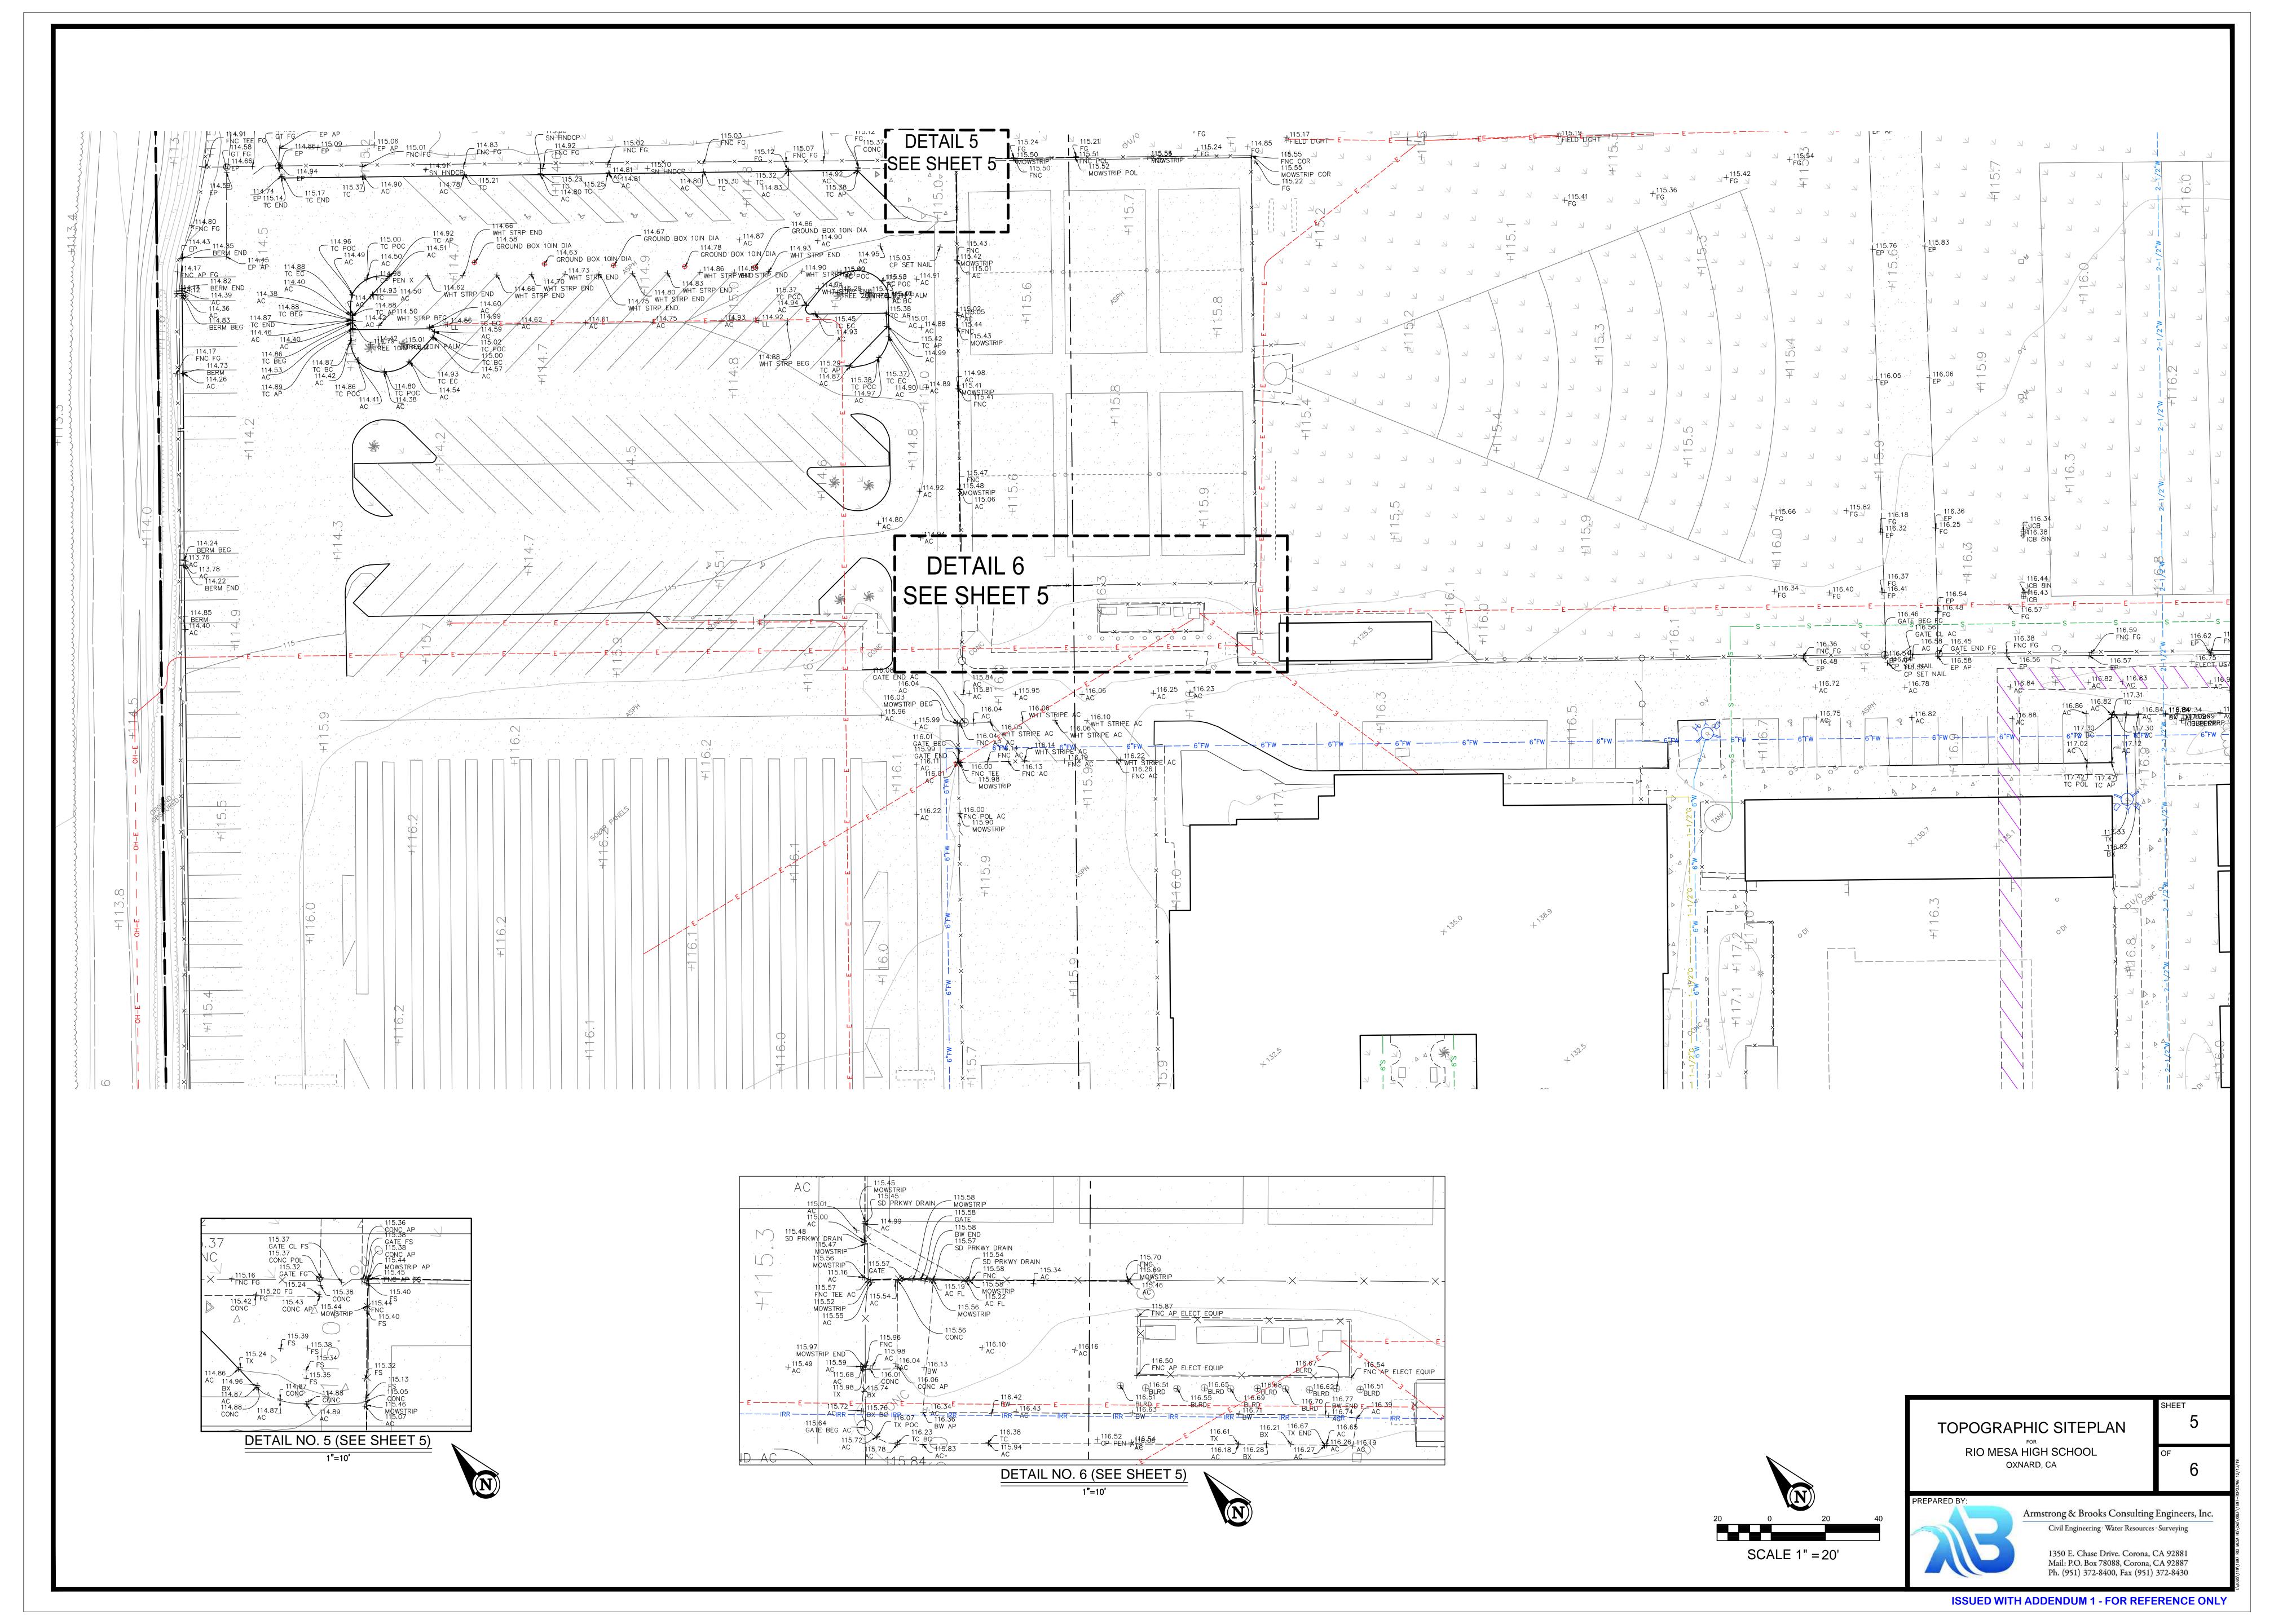

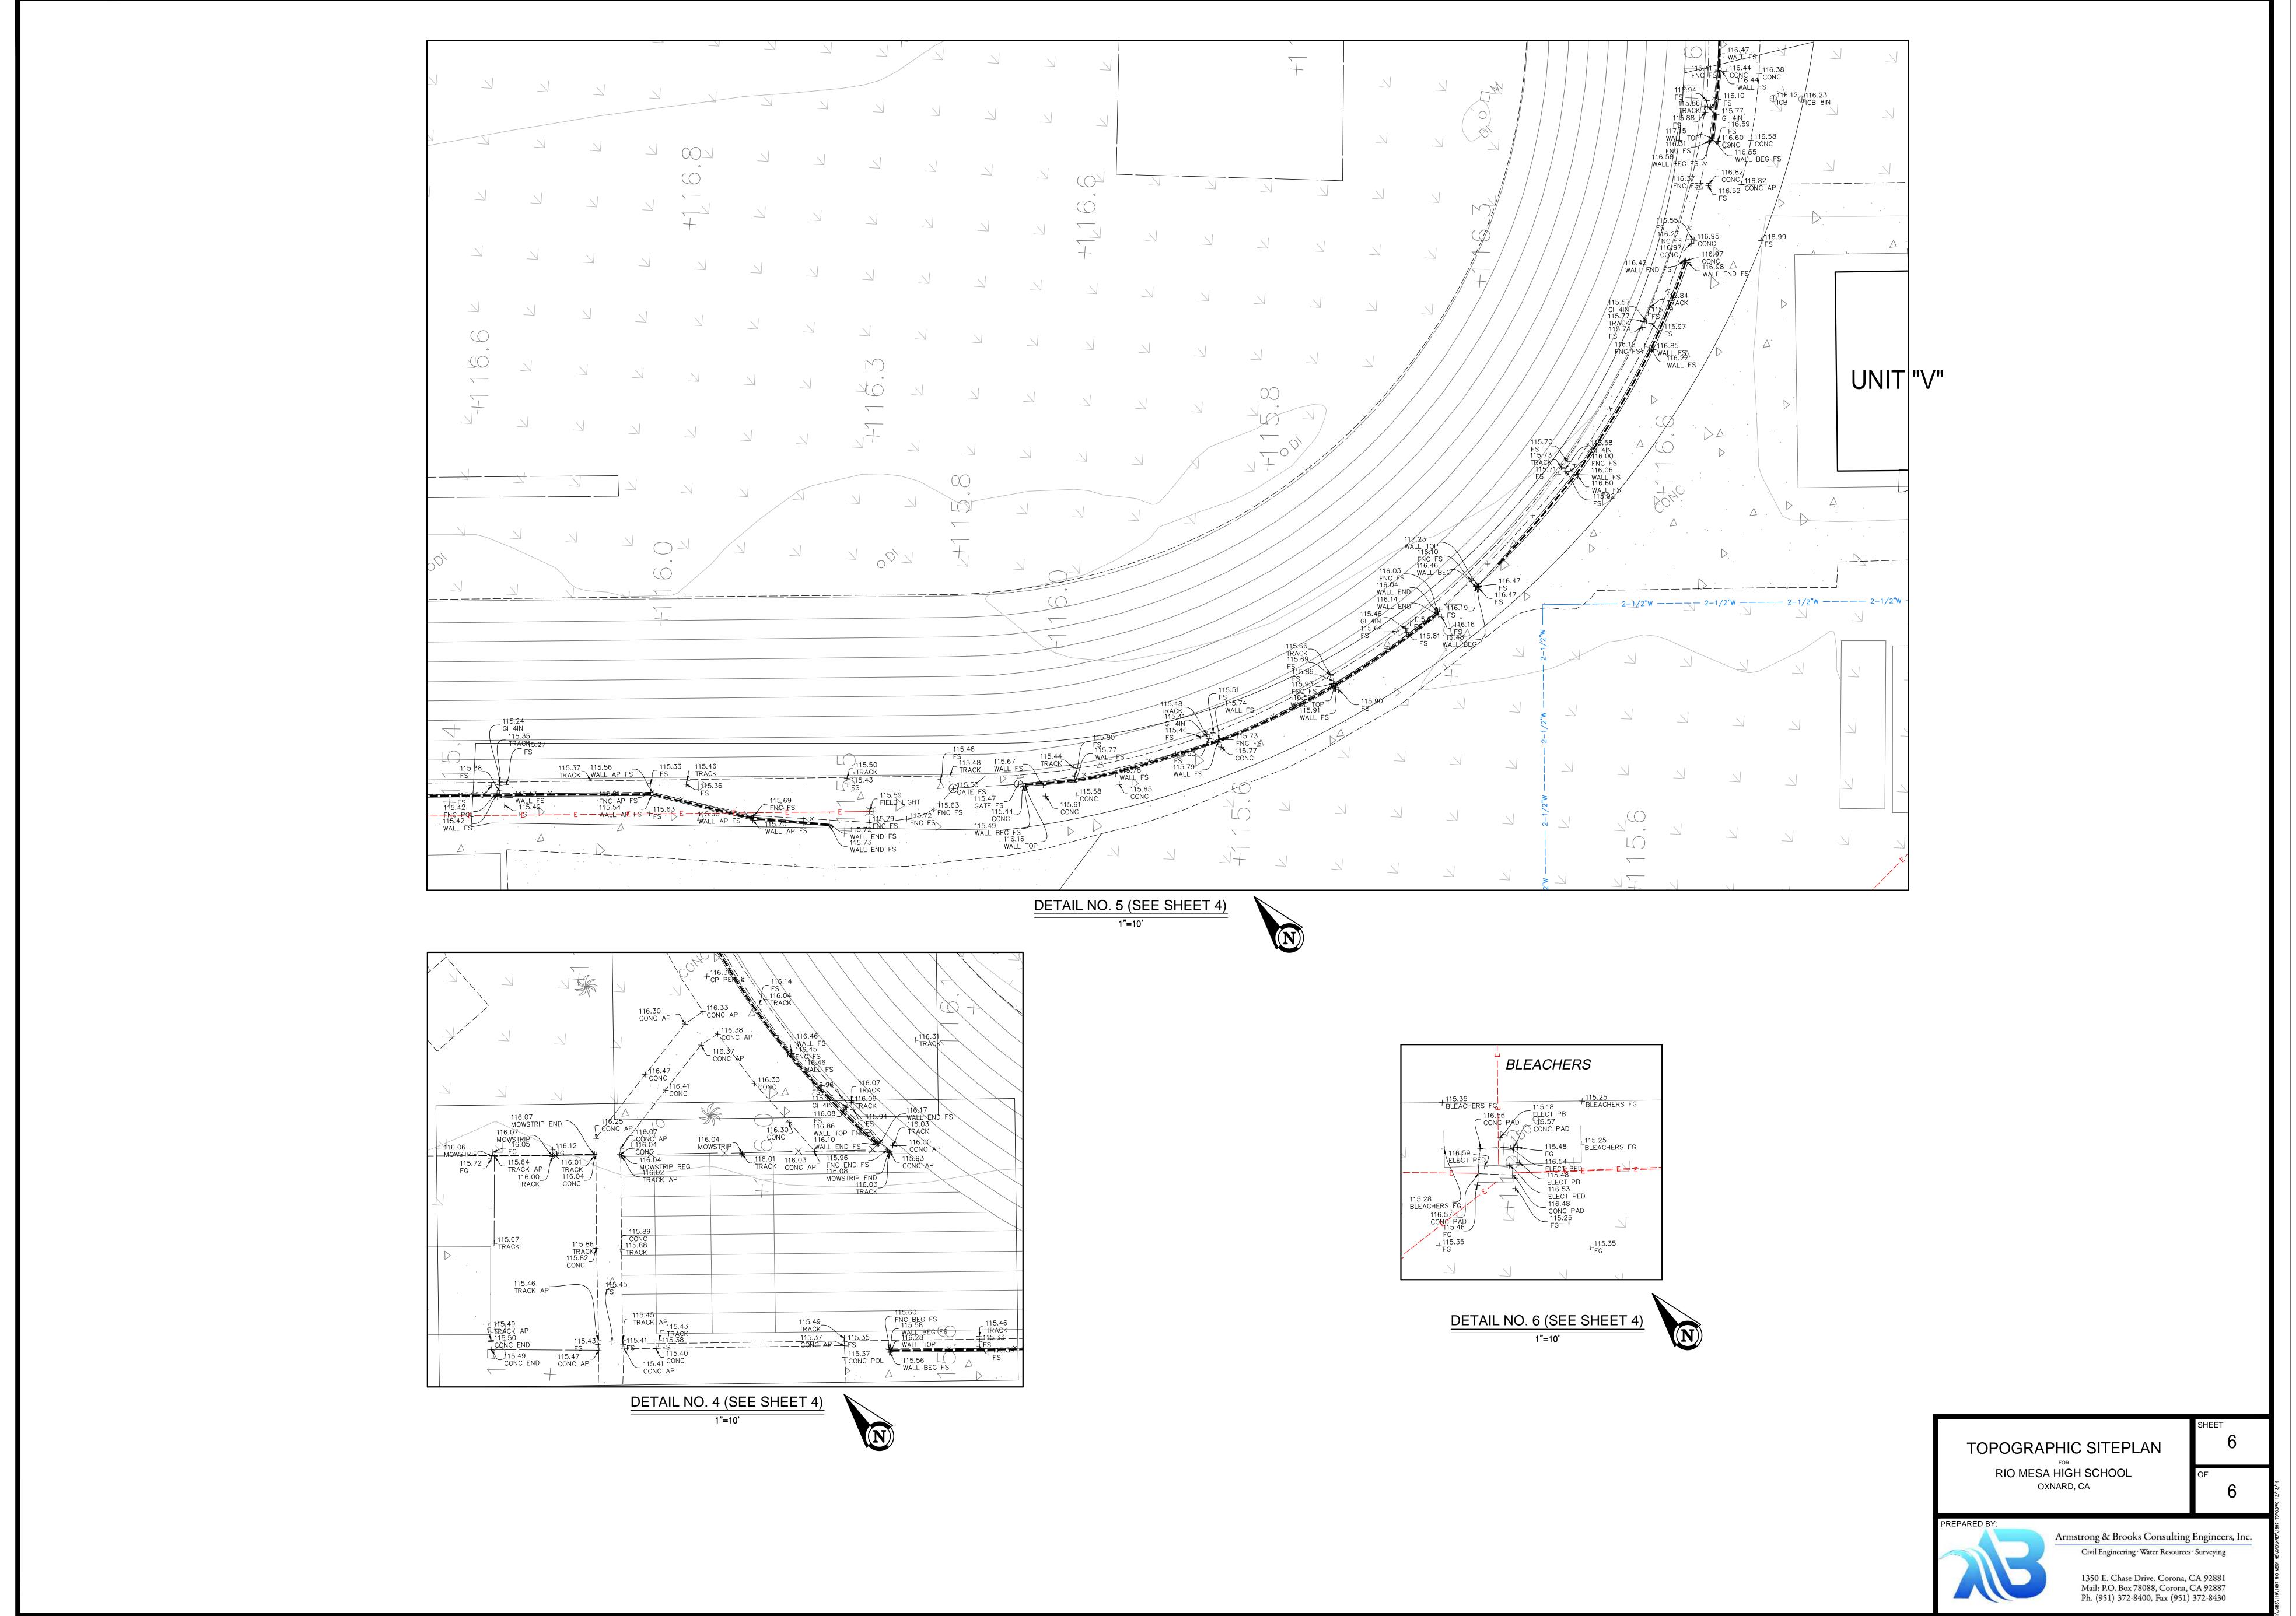

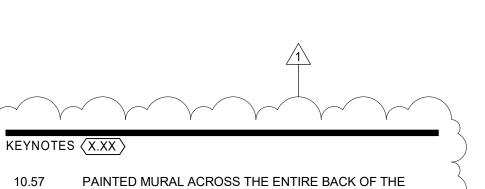

PRESS BOX WITH ARTWORK TO BE PROVIDED BY THE

DISTRIÇT.

SAFE DISPERSAL AREA TOTAL NO. OF OCCUPANTS: 4,402 OCC. x 5 SF/OCC. = 22,010 SF PROVIDED = 22,150 SF 10.57 DG SURFACE @ 2,235 SF TO ACCOMMODATE 221 OCCUPANTS (5% -10 OCCUPANT CALCULATION: OF 4,402 OCCUPANTS) @ 10 SF (30" x HOME BLEACHERS: 48") PER OCCUPANT 82 2,976 NET 18" SEATS 32 WHEELCHAIRS 32 COMPANIONS 167' - 0" 32 SEMI-AMBULANT 14 AISLE 3,086 TOTAL 27'-0" (E) WALKWAY VISITOR BLEACHERS: 1,295 NET 18" SEATS 15 WHEELCHAIRS 1,310 TOTAL UNIT 'V': 6 CCUPANTS GRAND TOTAL: 5 4,402 OCCUPANTS 0 50

AGENCY REVIEW



www.littleonline.com

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PRINCIPAL IN CHARGE: JT PROJECT MANAGER: FM

DESIGN TEAM:

PROJECT NAME	PROJECT NO.
RIO MESA HIGH SCHOOL	6121235310
HOME BLEACHERS	ISSUE DATE
⚠ ADDENDUM	08/04/2020
DESCRIPTION	REFERENCE
PARTIAL SITE PLAN	A1.0.1
FARTIAL SITE FLAN	BULLETIN DRAWING
	AD1-A1

