

ADOLFO CAMARILLO HIGH SCHOOL VISITOR BLEACHERS

OXNARD UNION HIGH SCHOOL DISTRICT

DSA SUBMITTAL

07/22/2020



ADOLFO CAMARILLO HIGH SCHOOL VISITOR BLEACHERS

OXNARD UNION HIGH SCHOOL DISTRICT

APPLICABLE STATE CODES	PROJECT DIRECTORY	VICINITY MAP	SHEET INDEX																																																																					
<div><div>1.</div><div>ALL CONSTRUCTION SHALL BE DONE IN ACCORDANCE WITH: 2019 CALIFORNIA ADMINISTRATIVE CODE, PART 1, TITLE 24 C.C.R. 2019 CALIFORNIA BUILDING CODE (CBC), PART 2, TITLE 24 C.C.R. (2018 INTERNATIONAL BUILDING CODE VOLUMES 1 & 2 AND 2013 CALIFORNIA AMENDMENTS) 2019 CALIFORNIA ELECTRICAL CODE (CEC), PART 3, TITLE 24 C.C.R. (2018 NATIONAL ELECTRICAL CODE AND 2013 CALIFORNIA AMENDMENTS) 2019 CALIFORNIA MECHANICAL CODE (CMC) PART 4, TITLE 24 C.C.R. (2018 UNIFORM MECHANICAL CODE AND 2013 CALIFORNIA AMENDMENTS) 2019 CALIFORNIA PLUMBING CODE (CPC), PART 5, TITLE 24 C.C.R. (2018 UNIFORM PLUMBING CODE AND 2013 CALIFORNIA AMENDMENTS) 2019 CALIFORNIA ENERGY CODE (CEC), PART 6, TITLE 24 C.C.R. 2019 CALIFORNIA FIRE CODE, PART 9, TITLE 24 C.C.R. (2018 INTERNATIONAL FIRE CODE AND 2013 CALIFORNIA AMENDMENTS) 2019 CALIFORNIA GREEN BUILDING STANDARDS CODE (CALGREEN), PART 11, TITLE 24 C.C.R. 2019 CALIFORNIA REFERENCE STANDARDS, PART 12, TITLE 24 C.C.R. TITLE 19 C.C.R., PUBLIC SAFETY, STATE FIRE MARSHAL REGULATIONS</div><div>2.</div><div>ALL WORK AND MATERIALS SHALL BE IN FULL ACCORDANCE WITH THE REQUIREMENTS OF THESE CODES AND ALL APPLICABLE LOCAL ORDINANCES. WHERE CONTRACT DOCUMENTS EXCEED SUCH REQUIREMENTS, WITHOUT VIOLATING SUCH CODES, REGULATIONS AND ORDINANCES, CONTRACT DOCUMENTS TAKE PRECEDENCE. WHERE CODES CONFLICT, THE MORE STRINGENT SHALL APPLY.</div><div>3.</div><div>THE PROVISIONS OF 2016 CFC CHAPTER 11 AND 2019 CBC CHAPTER 33 SHALL BE ENFORCED ON THIS PROJECT.</div><div>4.</div><div>A DSA ACCEPTED TESTING LABORATORY DIRECTLY EMPLOYED BY THE DISTRICT (OWNER) SHALL CONDUCT ALL THE REQUIRED TESTS AND INSPECTIONS FOR THE PROJECT.</div><div>5.</div><div>GRADING PLANS, DRAINAGE IMPROVEMENTS, ROAD AND ACCESS REQUIREMENTS AND ENVIRONMENTAL HEALTH CONSIDERATIONS SHALL COMPLY WITH ALL LOCAL ORDINANCES.</div></div> <div><div>PROJECT</div><div>ADOLFO CAMARILLO HIGH SCHOOL TRACK & FIELD IMPROVEMENTS - INCREMENT 2 4660 MISSION OAKS BLVD CAMARILLO, CA 93012</div><div>OWNER</div><div>OXNARD UNION HIGH SCHOOL DISTRICT 309 S. "K" STREET OXNARD, CA 93030 (805) 385-2500</div><div>ARCHITECT</div><div>LITTLE 1300 DOVE STREET, SUITE 100 NEWPORT BEACH, CA 92660 (949) 698-1400 (949) 698-1433 (FAX)</div><div>CIVIL</div><div>LITTLE 1300 DOVE STREET, SUITE 100 NEWPORT BEACH, CA 92660 (949) 698-1400 (949) 698-1433 (FAX)</div></div> <div></div> <div><table><tr><td>GENERAL</td><td>B3</td><td>FOOTING LAYOUT</td></tr><tr><td>G0.1</td><td>B4</td><td>FOOTING DETAILS</td></tr><tr><td>G1.1</td><td>B5</td><td>UNDERSTRUCTURE LAYOUT</td></tr><tr><td>G2.1</td><td>B6</td><td>ELEVATION VIEWS</td></tr><tr><td></td><td>B7</td><td>SECTION VIEW</td></tr><tr><td>CIVIL</td><td>B8</td><td>SECTION VIEW</td></tr><tr><td>C1.0</td><td>B9</td><td>SECTION VIEW</td></tr><tr><td>C1.1</td><td>B10</td><td>SIGHT LINES</td></tr><tr><td>C2.0</td><td>B11</td><td>SEATING LAYOUT</td></tr><tr><td>C2.1</td><td>B12</td><td>EXITS</td></tr><tr><td>C3.0</td><td>B13</td><td>EXITS</td></tr><tr><td>C3.1</td><td>B14</td><td>EXIT DETAILS</td></tr><tr><td>C4.0</td><td>B15</td><td>EXIT DETAILS</td></tr><tr><td>C4.1</td><td>B16</td><td>EXIT DETAILS</td></tr><tr><td>C5.0</td><td>B17</td><td>SEAT BRACKET LAYOUT</td></tr><tr><td>C5.1</td><td>B18</td><td>PLANK DETAILS</td></tr><tr><td>C6.0</td><td>B19</td><td>DETAILS</td></tr><tr><td></td><td>B20</td><td>DETAILS</td></tr><tr><td>ARCHITECTURAL</td><td></td><td></td></tr><tr><td>A1.1</td><td></td><td>SYMBOLS AND NOTES</td></tr><tr><td></td><td>E-000</td><td>ELECTRICAL SITE PLAN</td></tr><tr><td>SOUTHERN BLEACHER COMPANY</td><td>E-200</td><td>ELECTRICAL PLANS - BLEACHERS</td></tr><tr><td>B1</td><td>E-201</td><td></td></tr><tr><td>B2</td><td></td><td>GRAND TOTAL: 38</td></tr></table></div>	GENERAL	B3	FOOTING LAYOUT	G0.1	B4	FOOTING DETAILS	G1.1	B5	UNDERSTRUCTURE LAYOUT	G2.1	B6	ELEVATION VIEWS		B7	SECTION VIEW	CIVIL	B8	SECTION VIEW	C1.0	B9	SECTION VIEW	C1.1	B10	SIGHT LINES	C2.0	B11	SEATING LAYOUT	C2.1	B12	EXITS	C3.0	B13	EXITS	C3.1	B14	EXIT DETAILS	C4.0	B15	EXIT DETAILS	C4.1	B16	EXIT DETAILS	C5.0	B17	SEAT BRACKET LAYOUT	C5.1	B18	PLANK DETAILS	C6.0	B19	DETAILS		B20	DETAILS	ARCHITECTURAL			A1.1		SYMBOLS AND NOTES		E-000	ELECTRICAL SITE PLAN	SOUTHERN BLEACHER COMPANY	E-200	ELECTRICAL PLANS - BLEACHERS	B1	E-201		B2		GRAND TOTAL: 38
GENERAL	B3	FOOTING LAYOUT																																																																						
G0.1	B4	FOOTING DETAILS																																																																						
G1.1	B5	UNDERSTRUCTURE LAYOUT																																																																						
G2.1	B6	ELEVATION VIEWS																																																																						
	B7	SECTION VIEW																																																																						
CIVIL	B8	SECTION VIEW																																																																						
C1.0	B9	SECTION VIEW																																																																						
C1.1	B10	SIGHT LINES																																																																						
C2.0	B11	SEATING LAYOUT																																																																						
C2.1	B12	EXITS																																																																						
C3.0	B13	EXITS																																																																						
C3.1	B14	EXIT DETAILS																																																																						
C4.0	B15	EXIT DETAILS																																																																						
C4.1	B16	EXIT DETAILS																																																																						
C5.0	B17	SEAT BRACKET LAYOUT																																																																						
C5.1	B18	PLANK DETAILS																																																																						
C6.0	B19	DETAILS																																																																						
	B20	DETAILS																																																																						
ARCHITECTURAL																																																																								
A1.1		SYMBOLS AND NOTES																																																																						
	E-000	ELECTRICAL SITE PLAN																																																																						
SOUTHERN BLEACHER COMPANY	E-200	ELECTRICAL PLANS - BLEACHERS																																																																						
B1	E-201																																																																							
B2		GRAND TOTAL: 38																																																																						

STATEMENT OF GENERAL CONFORMANCE

FOR ARCHITECTS/ENGINEERS WHO UTILIZE PLANS, INCLUDING BUT NOT LIMITED TO SHOP DRAWINGS, PREPARED BY OTHER LICENSED DESIGN PROFESSIONALS AND/OR CONSULTANTS

The drawings or sheets listed on the sheet index under:
"SOUTHERN BLEACHER COMPANY"

have been prepared by other design professionals or consultants who are licensed and/or authorized to prepare such drawings in this state. It has been examined by me for:

1) design intent and appears to meet the appropriate requirements of Title 24, California Code of Regulations and the project specifications prepared by me, and

2) coordination with my plans and is acceptable for incorporation into the construction of this project.

The Statement of General Conformance "shall not be construed as relieving me of my rights, duties, and responsibilities under Sections 17302 and 81138 of the Education Code and Sections 4-336, 4-341 and 4-344" of Title 24, Part 1. (Title 24, Part 1, Section 4-317 (b))

I certify that all drawings listed on the sheet index under:
"SOUTHERN BLEACHER COMPANY"

are in general conformance with the project design, and have been coordinated with the project plans.

Signature

04/28/2020

Architect or Engineer designated to be in responsible charge

JAY R. TITTLE, AIA

Print Name

C 12955

11-30-21

License Number

Expiration Date

GENERAL NOTES

1. DURING THE ENTIRE CONSTRUCTION PERIOD, IT SHALL BE THE SOLE RESPONSIBILITY OF THE CONTRACTOR TO MAINTAIN CONDITIONS AT THE PROJECT SITE, TO MEET THE REQUIREMENTS OF THE FEDERAL OCCUPATIONAL SAFETY AND HEALTH ADMINISTRATION (OSHA) AND CALIFORNIA OCCUPATIONAL REGULATIONS. THIS PROVISION SHALL COVER THE CONTRACTOR'S EMPLOYEES AND ALL OTHER PERSONS WORKING UPON OR VISITING THE SITE. THE CONTRACTOR SHALL BECOME FULLY INFORMED OF ALL APPLICABLE STANDARDS AND REGULATIONS AND INFORM ALL PERSONS AND REPRESENTATIVES RESPONSIBLE FOR WORK UNDER THIS CONTRACT.

2. CONFIRM ALL NEW AND EXISTING CONDITIONS WITH THE CONTRACT DOCUMENTS. NOTIFY ARCHITECT IMMEDIATELY IN WRITING OF ALL DISCREPANCIES OR CONFLICTS. DO NOT PROCEED WITH WORK IN THE AREA OF DISCREPANCY OR CONFLICT UNTIL DIRECTION IS GIVEN BY ARCHITECT. IF CONTRACTOR PROCEEDS WITHOUT DIRECTION FROM ARCHITECT, IT SHALL BE AT CONTRACTORS RISK, AND CONTRACTOR SHALL BE RESPONSIBLE FOR ALL REQUIRED CORRECTIVE ACTION.

3. REVIEW THE ARCHITECTURAL DRAWINGS BEFORE THE INSTALLATION OF SYSTEMS SHOWN ON CONSULTING ENGINEERS DOCUMENTS. DISCREPANCIES BETWEEN THE ARCHITECTURAL AND CONSULTING ENGINEER'S DOCUMENTS SHALL BE BROUGHT TO ARCHITECT'S ATTENTION FOR DIRECTION. CONSTRUCTION INSTALLED IN CONFLICT WITH THE ARCHITECTURAL DRAWINGS SHALL BE CORRECTED BY CONTRACTOR AT NO EXPENSE TO THE OWNER.

4. DO NOT SCALE THE CONSTRUCTION DOCUMENTS. WRITTEN DIMENSIONS TAKE PRECEDENCE OVER SCALED GRAPHICS. NOTIFY ARCHITECT IMMEDIATELY IN WRITING OF ALL ADDITIONAL REQUIRED DIMENSIONS. DO NOT PROCEED WITH WORK IN THE AREA OF DISCREPANCY OR CONFLICT UNTIL DIRECTION IS GIVEN BY ARCHITECT. IF THE CONTRACTOR PROCEEDS WITHOUT DIRECTION FROM ARCHITECT, IT SHALL BE AT CONTRACTORS RISK, AND CONTRACTOR SHALL BE RESPONSIBLE FOR ALL REQUIRED CORRECTIVE ACTION.

5. CORRECT ALL WORK INSTALLED IN CONFLICT WITH THE CONSTRUCTION DOCUMENTS BY CONTRACTOR AS DIRECTED BY ARCHITECT AND AT NO ADDITIONAL EXPENSE TO THE OWNER.

6. VISIT JOB SITE PRIOR TO BEGINNING WORK AND VERIFY ALL DIMENSIONS AND CONDITIONS.

7. WHERE WORK OR EQUIPMENT IS INDICATED "IN I.C." (NOT IN CONTRACT) ON THE DRAWINGS. SUCH WORK AND/OR EQUIPMENT SHALL BE PROVIDED BY OTHERS. CONTRACTOR SHALL COORDINATE AND COOPERATE TO EFFECT SUCH INSTALLATION.

8. DIMENSIONS ARE NOT ADJUSTABLE WITHOUT THE REVIEW OF ARCHITECT UNLESS NOTED (+/-) OR "VERIFY". DIMENSIONS NOTED "HOLD" SHALL BE CONSIDERED AS ABSOLUTE AND USED FOR LAY-OUT CONTROL UNLESS OTHERWISE DIRECTED BY ARCHITECT.

9. ALL HEIGHTS ARE DIMENSIONED FROM TOP OF SLAB UNLESS NOTED "AFF" (ABOVE FINISH FLOOR).

10. "TYPICAL" MEANS COMPARABLE CHARACTERISTICS FOR THE ELEVATION OR DETAIL NOTED. WHEN A DETAIL OR NOTE IS IDENTIFIED AS "TYPICAL", CONTRACTOR SHALL APPLY THIS DETAIL OR NOTE TO EVERY LIKE CONDITION. WHETHER OR NOT THE REFERENCE IS REPEATED IN EVERY INSTANCE. VERIFY DIMENSIONS AND ORIENTATION ON PLANS.

11. "SIMILAR" MEANS COMPARABLE CHARACTERISTICS FOR THE ELEVATION OR DETAIL NOTED VERIFY DIMENSIONS AND ORIENTATION ON PLANS.

12. PROVIDE BARRICADES AND PROTECTIVE DEVICES SEPARATING CONSTRUCTION AREAS. PROVIDE TEMPORARY PASSAGES AS REQUIRED. PRIOR TO DELIVERY OF MATERIALS TO CONSTRUCTION ZONE AND REMOVAL OF WASTE FROM SITE, CHECK WITH OWNER FOR ACCEPTABLE ACCESS ROUTE AND TIME. UNDER NO CIRCUMSTANCES USE AREA OUTSIDE THE CONSTRUCTION ZONE WITHOUT PRIOR CLEARANCE FROM THE OWNER COMPLY WITH REQUIREMENTS AS SPECIFIED IN PROJECT MANUAL.

13. TAKE ALL MEASURES TO ACCOMPLISH THE WORK WITH THE MINIMUM OF INTERRUPTION TO NORMAL BUILDING PROCEDURES. NOTIFY OWNER IN ADVANCE OF HVAC, ELECTRICAL OR OTHER BUILDING SYSTEM SHUT-OFFS. MINIMIZE NOISE AND DUST GENERATION TO MAXIMUM EXTENT POSSIBLE. COMPLY WITH REQUIREMENTS AS SPECIFIED IN PROJECT MANUAL.

14. REMOVE ALL TRASH AND DEBRIS DAILY. DO NOT STORE BUILDING MATERIALS IN CORRIDORS AT ANY TIME. COMPLY WITH REQUIREMENTS AS SPECIFIED IN PROJECT MANUAL.

15. PERFORM ALL CUTTING, PATCHING, AND FINISHING NECESSARY TO RESTORE THE BUILDING AND SITE TO ORIGINAL CONDITION OF ALL EXISTING PORTIONS OF THE BUILDING AND SITE AFFECTED BY CONTRACTORS WORK, TO THE SATISFACTION OF ARCHITECT AND OWNER.

16. VERIFY POINTS OF CONNECTION, INCLUDING SIZES AND LOCATIONS, AND ALL OTHER REQUIRED OPERATING CRITERIA WITH EQUIPMENT MANUFACTURER.

17. CONTRACTOR SHALL STIPULATE THAT ALL PROPOSED SUBSTITUTIONS ARE EQUAL IN PERFORMANCE AND COMPLY WITH APPLICABLE CODES AND REGULATIONS. CONTRACTOR'S SUBSTITUTION OF ALTERNATE MATERIALS OR SYSTEMS SHALL BE AT NO ADDITIONAL COST TO OWNER.

18. CONTRACTOR SHALL INSURE ALL CONSTRUCTION SHALL REMAIN ACCESSIBLE AND EXPOSED FOR INSPECTION PURPOSES UNTIL APPROVED BY THE INSPECTOR OF RECORD. FOR CONTINUOUS INSPECTION, TESTING, AND OBSERVATION REQUIREMENTS, REFER TO THE TESTING AND OBSERVATION PROGRAM.

SCOPE OF WORK

WORK UNDER THIS CONTRACT INCLUDES THE FOLLOWING ITEMS SHOWN ON THE DRAWINGS AND AS SPECIFIED IN THE PROJECT MANUAL, INCLUDING:

1. CONSTRUCTION OF NEW VISITOR STADIUM BLEACHERS.

DSA REQUIREMENTS

CHANGES TO THE APPROVED DRAWINGS AND SPECIFICATIONS SHALL BE MADE BY AN ADDENDUM OR A CONSTRUCTION CHANGE DOCUMENT (CCD) APPROVED BY THE DIVISION OF THE STATE ARCHITECT (DSA), AS REQUIRED BY SEC. 4-338, PART 1, TITLE 24, CCR.

THE INTENT OF THESE DRAWINGS AND SPECIFICATIONS IS THAT THE WORK OF THE ALTERATION, REHABILITATION OR RECONSTRUCTION IS TO BE IN ACCORDANCE WITH TITLE 24, CCR. SHOULD ANY EXISTING CONDITIONS SUCH AS DETERIORATION OR NON-COMPLYING CONSTRUCTION BE DISCOVERED WHICH IS NOT COVERED BY THE CONTRACT DOCUMENTS WHEREIN THE FINISHED WORK WILL NOT COMPLY WITH TITLE 24, CCR, A CONSTRUCTION CHANGE DOCUMENT (CCD), OR A SEPARATE SET OF PLANS AND SPECIFICATIONS, DETAILING AND SPECIFYING THE REQUIRED WORK SHALL BE SUBMITTED TO AND APPROVED BY DSA BEFORE PROCEEDING WITH THE WORK. [SEC. 4-317(c), PART 1, TITLE 24, CCR]

PROJECT INSPECTOR

A DIVISION OF THE STATE ARCHITECT (DSA) CERTIFIED PROJECT INSPECTOR EMPLOYED BY THE DISTRICT AND APPROVED BY DSA SHALL PROVIDE CONTINUOUS INSPECTION OF THE WORK.

DUTIES AND REQUIRED IOR CLASSIFICATION PER SECTION 4-342, TITLE 24, PART 1 CCR AND IR A-7. CLASS 1 INSPECTOR CERTIFIED BY DSA.

A DSA ACCEPTED TESTING LABORATORY DIRECTLY EMPLOYED BY THE DISTRICT SHALL CONDUCT ALL THE REQUIRED TESTS AND INSPECTIONS FOR THE PROJECT.

NO PUBLIC ACCESS
NO STORAGE
PERMITTED UNDER
BLEACHERS

2' - 2"

1'-0"

5'-0" A.F.F.

1/2" RADIUS, TYP.

2" HIGH LETTERING

NOTE:
SIGN LETTERING AND ITS BACKGROUND SHALL CONTRAST IN COLOR, TYP.

SIGNAGE S1 - DETAIL

1 1/2" = 1'-0"

3

G1.1

CHAINLINK FENCE

1/4" = 1'-0"

1

G1.1

PLAN - SINGLE POST

SECTION - SINGLE POST

POST @ CHAIN LINK FENCE

3/4" = 1'-0"

2

G1.1

AGENCY REVIEW

IDENTIFICATION STAMP
DIV. OF THE STATE ARCHITECT
APP. 03-120480 INC.
REVIEWED FOR
SS ☒ FLS ☒ ACS ☒
DATE: 07/22/2020

LITTLE
DIVERSIFIED ARCHITECTURAL CONSULTING

1300 Dove Street, Suite 100
Newport Beach, CA, 92660
T: 949.698.1400

www.littleonline.com

This drawing and the design shown are the property of Little Diversified Architectural Consulting. The reproduction, copying or other use of this drawing without their written consent is prohibited and any infringement will be subject to legal action.

© Little 2019

CLIENT NAME

OXNARD UNION HIGH SCHOOL DISTRICT

PROJECT NAME

ADOLFO CAMARILLO HIGH SCHOOL VISITOR BLEACHERS

4660 MISSION OAKS BLVD,
CAMARILLO, CA. 93012

CONSULTANT

SEAL

ISSUE FOR
DSA SUBMITTAL

ISSUE DATE
07/22/2020

REVISIONS

PROJECT TEAM

PRINCIPAL IN CHARGE
JT
PROJECT MANAGER
LEB
DESIGN TEAM
FM/RG/JR/CL/ITA

PROJECT NAME

ADOLFO CAMARILLO HIGH SCHOOL VISITOR BLEACHERS

PROJECT NO.


6121235309

SHEET TITLE

TITLE SHEET/SHEET INDEX/DETAILS

SHEET NUMBER

G1.1

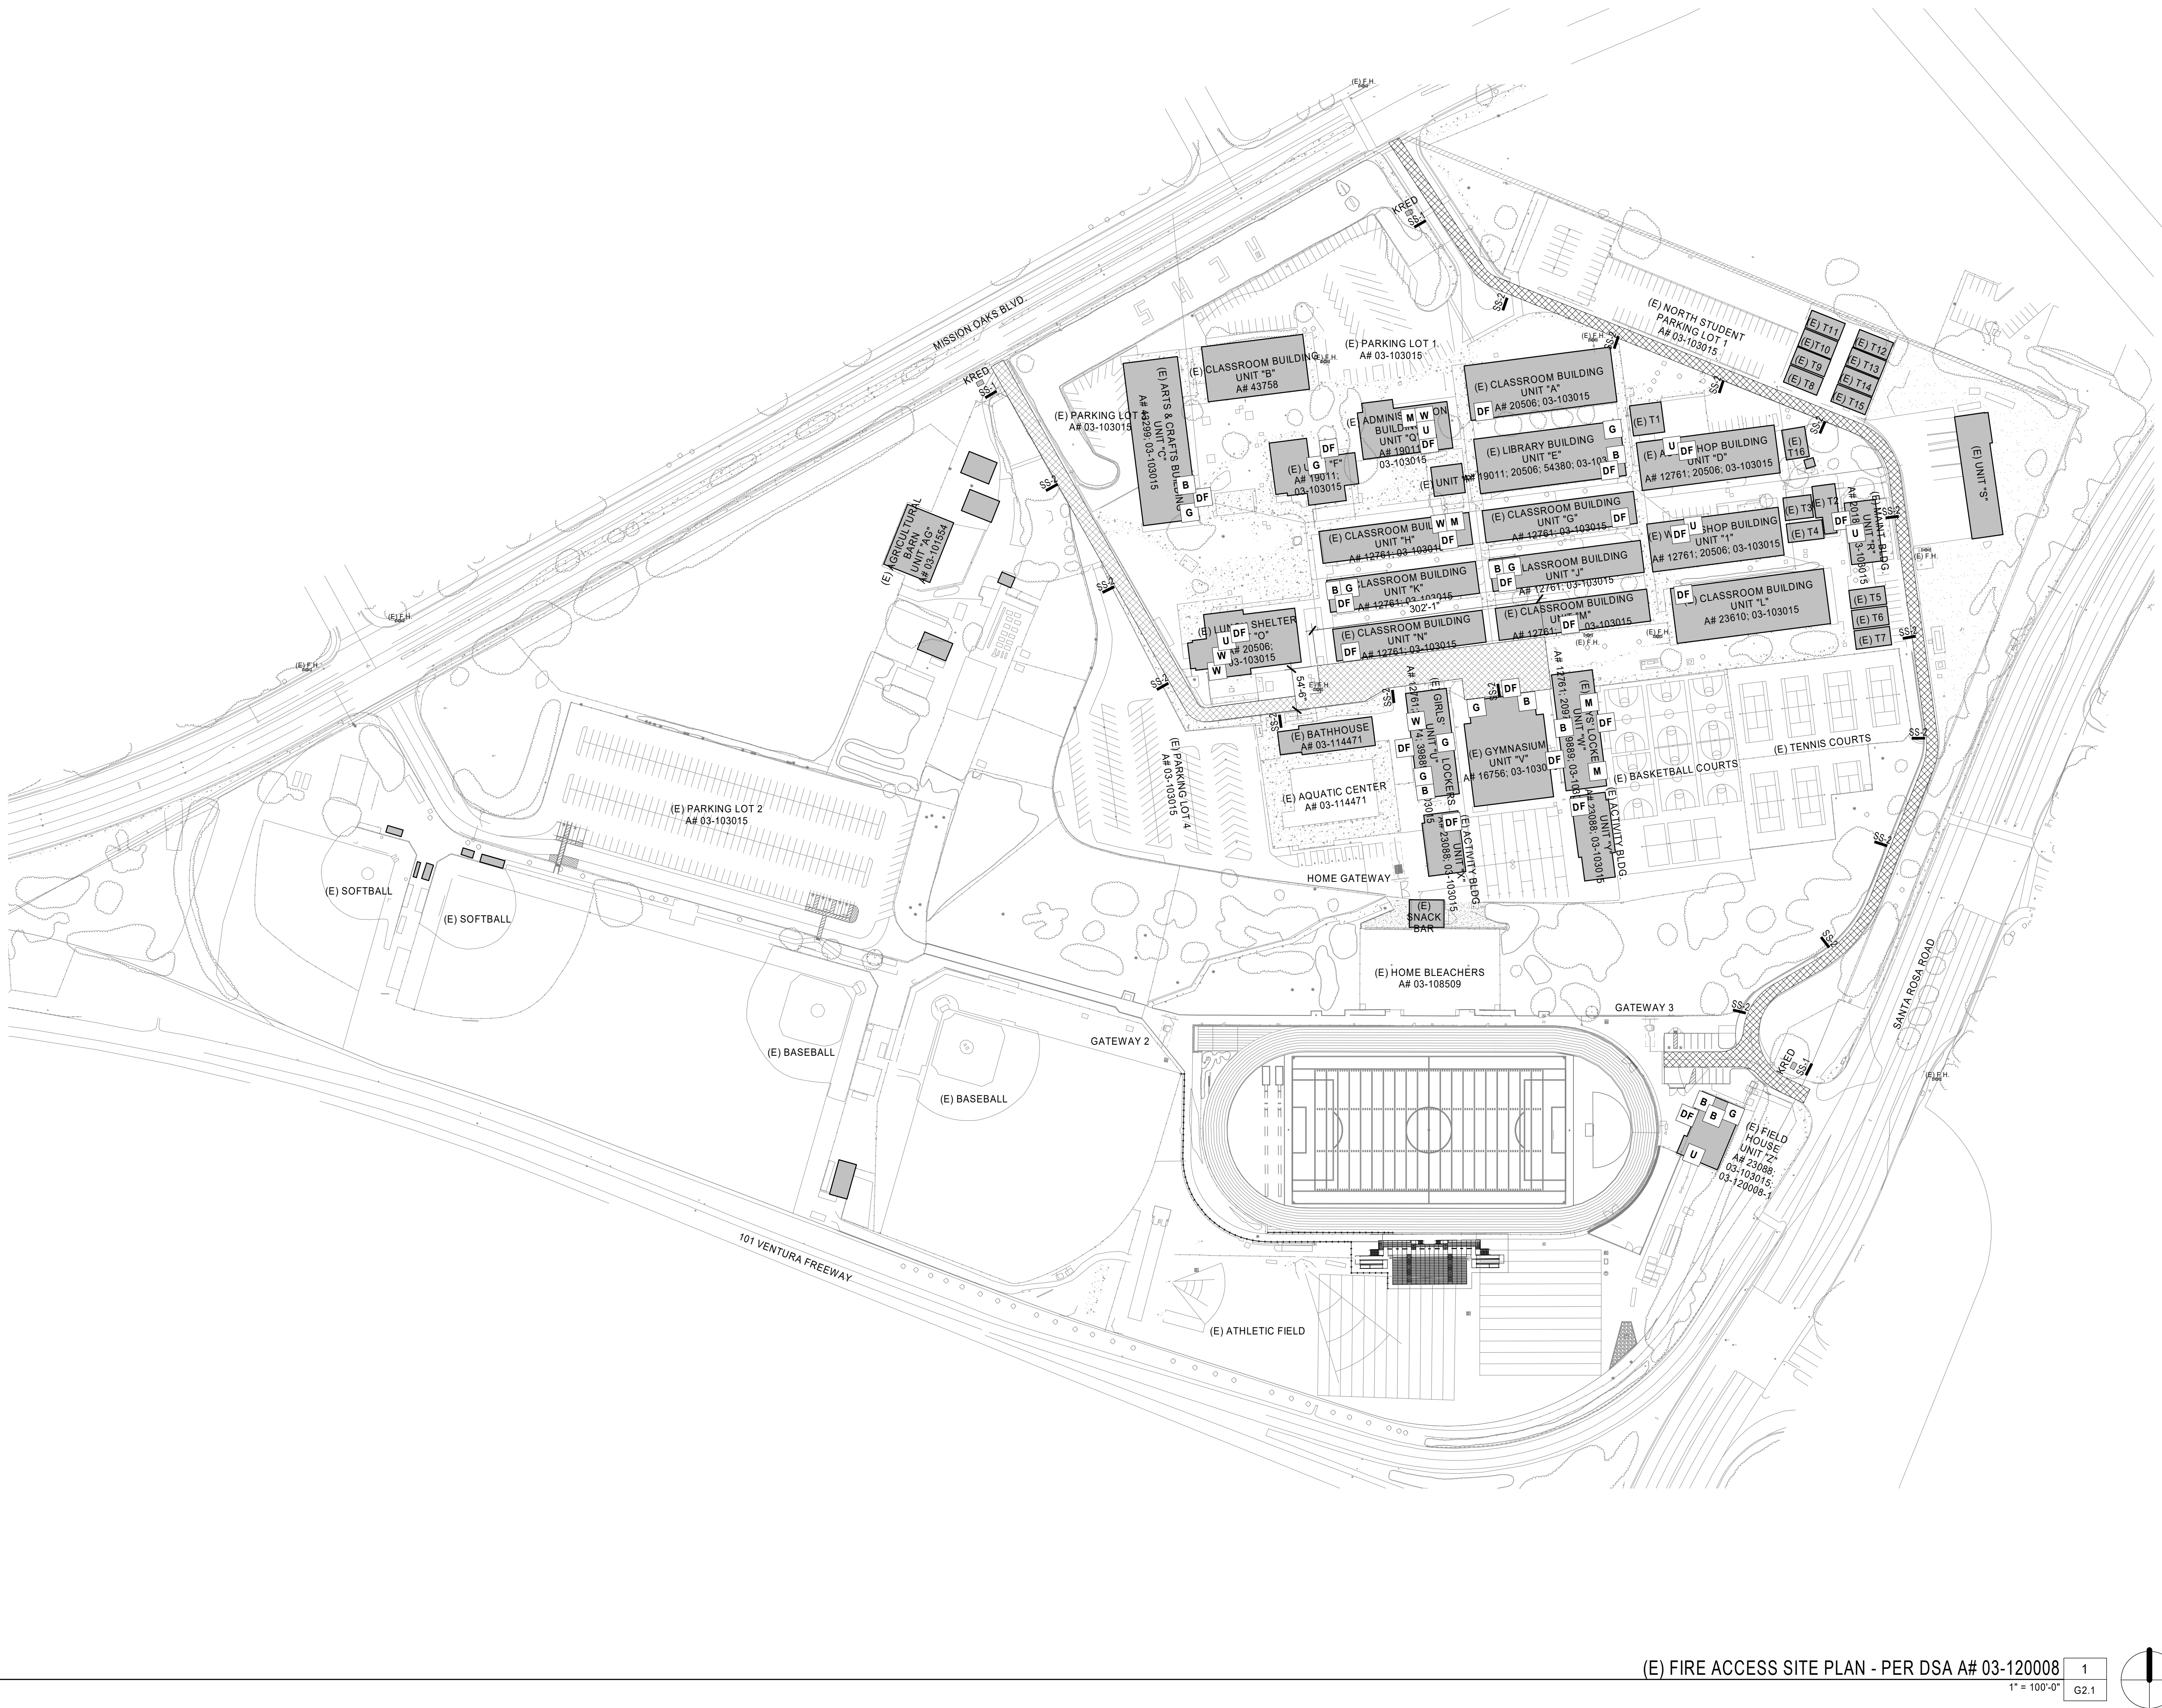

(E) FIRE ACCESS SITE PLAN - PER DSA A# 03-120008

1
G2.1

AGENCY REVIEW

IDENTIFICATION STAMP	
APP. 03-120480	INC.
REVIEWED FOR	
SS <input type="checkbox"/>	FLS <input type="checkbox"/> ACS <input type="checkbox"/>
DATE:	07/22/2020

LITTLE
DIVERSIFIED ARCHITECTURAL CONSULTING

1300 Dove Street, Suite 100
Newport Beach, CA, 92660
T: 949.698.1400

www.littleonline.com

This drawing and the design shown are the property of Little Diversified Architectural Consulting. The reproduction, copying or other use of this drawing without their written consent is prohibited and any infringement will be subject to legal action.

© Little 2019

CLIENT NAME


**OXNARD UNION
HIGH SCHOOL
DISTRICT**

PROJECT NAME

**ADOLFO CAMARILLO HIGH SCHOOL
VISITOR BLEACHERS**
**4660 MISSION OAKS BLVD,
CAMARILLO, CA. 93012**

CONSULTANT

SEAL

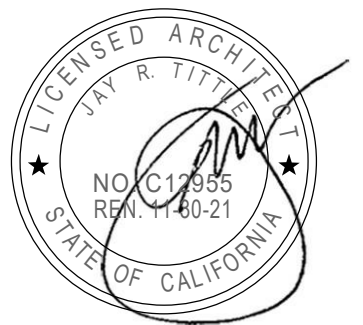

ISSUE FOR

DSA SUBMITTAL

ISSUE DATE

07/22/2020

REVISIONS

NO.	REASON	DATE

PROJECT TEAM

PRINCIPAL IN CHARGE

JT

PROJECT MANAGER

FM

DESIGN TEAM

FM

PROJECT NAME

**ADOLFO CAMARILLO HIGH
SCHOOL VISITOR
BLEACHERS**

PROJECT NO.

6121235309

SHEET TITLE

(E) FIRE ACCESS SITE PLAN

SHEET NUMBER

G2.1

1. WORK SHALL BE PERFORMED ACCORDING TO THE LATEST EDITIONS OF THE STANDARD SPECIFICATIONS AND PLANS FOR PUBLIC WORKS CONSTRUCTION (GREEN BOOK & S.P.W.C.), LATEST EDITION OF CALIFORNIA BUILDING CODE AND CITY OF CAMARILLO BUILDING CODE REQUIREMENTS.
2. NO WORK SHALL BE STARTED WITHOUT A PRE-CONSTRUCTION MEETING WITH THE OWNER, INSPECTOR AND AGR.
3. THE CONTRACTOR SHALL PROVIDE FOR CONTRIBUTORY DRAINAGE AT ALL TIMES AND TAKE ALL NECESSARY AND PROPER PRECAUTIONS TO PROTECT ADJACENT PROPERTIES AND IMPROVEMENTS FROM ANY AND ALL DAMAGE THAT MAY OCCUR FROM STORM WATER RUNOFF AND/OR DEPOSITION OF DEBRIS RESULTING FROM ANY AND ALL WORK.
4. NO REVISIONS SHALL BE MADE TO THESE PLANS WITHOUT THE APPROVAL OF THE CIVIL ENGINEER.
5. IMPORTANT NOTICE - SECTION 4216/4217 OF THE GOVERNMENT CODE REQUIRES A DIG ALERT IDENTIFICATION NUMBER BE ISSUED BEFORE ANY "PERMIT TO EXCAVATE" WILL BE VALID. FOR YOUR DIG ALERT I.D. NUMBER, CALL UNDERGROUND SERVICE ALERT TOLL FREE @ 1-800-422-4133, TWO WORKING DAYS BEFORE YOU DIG.
6. ANY IMPROVEMENT(S) TO BE CONSTRUCTED WITHIN PUBLIC RIGHT-OF-WAY WILL REQUIRE SEPARATE CONSTRUCTION PERMIT AND INSPECTION FROM THE GOVERNING AGENCY(IES). CONTRACTOR SHALL BE RESPONSIBLE FOR SECURING ALL APPLICABLE PERMITS AND PAYING ANY REQUIRED FEES.
7. FILLS SHALL BE COMPACTED THROUGHOUT TO AT LEAST 95% OF MAXIMUM DRY DENSITY AS DETERMINED BY A.S.T.M. SOIL COMPACTION TEST D 1557.
8. CONTRACTOR SHALL BE RESPONSIBLE FOR PRESERVING ALL GRADE STAKES UNTIL AUTHORIZED BY SURVEYOR TO REMOVE.
9. CONTRACTOR SHALL RESTORE LIKE FOR LIKE, TO THE SATISFACTION OF THE OWNER/ARCHITECT, ALL AREAS DAMAGED OR DISTURBED AS A RESULT OF WORK PERFORMED PURSUANT TO THESE PLANS AT HIS/HERS OWN EXPENSE.
10. FIELD DENSITY MAY BE DETERMINED BY THE NUCLEAR DENSITY METHOD (A.S.T.M. D2922 & D3017 PROVIDED NOT LESS THAN 10% OF THE REQUIRED DENSITY TESTS UNIFORMLY DISTRIBUTED ARE BY THE SAND-CONE METHOD. THE METHOD OF DETERMINING FIELD DENSITY AND LOCATION AND APPROXIMATE ELEVATION SHALL BE SHOWN IN THE CONSTRUCTION REPORT. OTHER METHODS MAY BE USED IF RECOMMENDED BY THE SOILS ENGINEER AND APPROVED IN ADVANCE BY THE CITY ENGINEER.
11. CRUSHED AGGREGATE BASE MATERIAL SHALL CONFORM TO SUBSECTION 200-2.2 OF STANDARD SPECIFICATIONS AND SHALL BE COMPACTED TO 95% RELATIVE COMPACTION USING MECHANICAL COMPACTION EQUIPMENT.
12. NEW CONCRETE PER PLANS AND PROJECT MANUAL.
13. THE CONTRACTOR IS RESPONSIBLE FOR PROTECTING ALL EXISTING UTILITIES WHETHER SHOWN OR NOT SHOWN ON THESE DRAWINGS. THE CONTRACTOR FURTHER ASSUMES ALL LIABILITY AND RESPONSIBILITY FOR THE UTILITY PIPES, CONDUITS, OR STRUCTURES SHOWN OR NOT SHOWN ON THESE DRAWINGS. THE CONTRACTOR SHALL BE RESPONSIBLE FOR PROTECTING ALL PUBLIC AND PRIVATE PROPERTY INsofar AS IT MAY BE AFFECTED BY THESE OPERATIONS. ALL COSTS FOR PROTECTING, REMOVING, AND RESTORING EXISTING IMPROVEMENTS SHALL BE BORNE BY THE CONTRACTOR.
14. CONSTRUCTION CONTRACTOR AGREES THAT IN ACCORDANCE WITH GENERALLY ACCEPTED CONSTRUCTION PRACTICES, CONSTRUCTION CONTRACTOR WILL BE REQUIRED TO ASSUME SOLE AND COMPLETE RESPONSIBILITY FOR JOB SITE CONDITIONS DURING THE COURSE OF CONSTRUCTION OF THE PROJECT, INCLUDING SAFETY OF ALL PERSONS AND PROPERTY. THIS REQUIREMENT SHALL BE IN EFFECT AT ALL TIMES.
15. THE CONTRACTOR SHALL VERIFY ALL JOINT ELEVATIONS PRIOR TO THE REMOVAL OF PAVEMENT, CURB, GUTTER, SIDEWALK AND/OR SLOPE GRADING. ANY DISCREPANCIES SHALL BE REPORTED TO THE ENGINEER OF RECORD PRIOR TO REMOVALS WITHIN THE AREA OF THE DISCREPANCIES.
16. DUST SHALL BE CONTROLLED BY WATERING TO THE SATISFACTION OF THE INSPECTOR.
17. WHERE THE IRRIGATION SYSTEM IN CONFLICT WITH NEW WORK NEEDS TO BE RELOCATED OR REPLACED, CONTRACTOR SHALL COORDINATE THE WATER SHUT OFF OR ANY ELECTRICAL RELATED WORK WITH OWNER 48 HOURS PRIOR COMMENCING THE WORK.
18. ALL EXPOSED P.C.C. CORNERS SHALL BE ROUNDED WITH A 1/2" RADIUS.
19. ALL EXPORT OF MATERIAL FROM THE SITE MUST GO TO A PERMITTED SITE APPROVED BY THE BUILDING OFFICIAL OR A LEGAL DUMP SITE. RECEIPTS FOR ACCEPTANCE OF EXCESS MATERIAL BY A DUMP SITE ARE REQUIRED AND MUST BE PROVIDED TO THE BUILDING OFFICIAL UPON REQUEST.
20. CONTRACTOR TO CALCULATE HIS/HER OWN QUANTITIES FOR BIDDING PURPOSES.
21. FOR JOINTS AT NEW CURB AND SIDEWALK REFER TO S.P.P.W.C. STD. PLAN No. 112-2. ALSO SEE DETAILS ON THIS SHEET FOR ADDITIONAL INFORMATION JOINT DETAILS.
22. IF WORK IS COMMENCED DURING RAINY SEASON, CONTRACTOR SHALL SATISFY CITY OF OXNARD AND VENTURA COUNTY'S EROSION CONTROL REQUIREMENTS AND INSTALL APPROPRIATE BMPs.

LEGEND

- FS FINISH SURFACE ELEVATION
TC TOP OF CURB ELEVATION
TS TOP OF CONCRETE SLAB ELEVATION
XX.XX PROPOSED SPOT ELEVATION
(XX.XX) EXISTING SPOT ELEVATION
--- CMU WALL
--- EXISTING FENCE
--- NEW C.L. FENCE
CONC. CONCRETE
G.B. GRADE BREAK
ESW EDGE OF SIDEWALK
DWY DRIVEWAY
C&G CURB & GUTTER
H.P. HIGH POINT
NC NATURAL GROUND
S.P.P.W.C. STANDARD PLANS FOR PUBLIC WORKS CONSTRUCTION
S.S.P.W.C. STANDARD SPECIFICATIONS FOR PUBLIC WORKS CONSTRUCTION
C.F. CURB FACE
ELEV. ELEVATION
EX. EXISTING
BCR. BEGIN CURB RETURN
ECR. END CURB RETURN
A.P. ANGLE POINT
(X) FURNISH AND INSTALL/CONSTRUCT, DEMOLISH, REMOVE AND REPLACE, OR RELOCATE, AS INDICATED.
XX.XX% NEW SLOPE
(XX.XX)% EXISTING SLOPE
FL FLOW LINE
T.B.M. TEMPORARY BENCH MARK
CONC. CONCRETE PAVEMENT
A.C. ASPHALT CONCRETE PAVING
(N) NEW
T.B.M. TEMPORARY BENCH MARK
F.F. FINISH FLOOR
A.F.F. ABOVE FINISH FLOOR
EG EDGE OF GUTTER
CLR. CLEAR
SCO SEWER CLEAN-OUT
SMH SEWER MANHOLE
P.A. PLANTER AREA
E.L. EXPANSION JOINT
C.J. CONTROL JOINT
D.I. DRAIN INLET
SCO SEWER CLEAN-OUT
EPB ELECTRICAL PULL BOX
WV WATER VALVE
SFM SEWER FORCE MAIN
N.I.C. NOT IN CONTRACT

BASIS OF BEARING

N60°57'03"E BEING THE CENTERLINE OF MISSION OAKS BOULEVARD PER MAP RECORDED IN BOOK 122, PAGES 51 THROUGH 54, OF MAPS, IN THE OFFICE OF THE COUNTY RECORDER OF VENTURA COUNTY, STATE OF CALIFORNIA.

BENCHMARK

COUNTY OF VENTURA #75-2A (1982)

ELEVATION: 157.24

DESCRIPTION: BRASS DISK STAMPED "75-2A RM1 2012"

LOCATION: BRASS DISK IN THE THE TOP OF CURB LOCATED 122.90' SOUTH OF THE S.E. COR OF THE INTERSECTION OF SANTA ROSA ROAD AND ADOLFO ROAD.









PRIVATE ENGINEER'S NOTICE TO CONTRACTOR

THE EXISTENCE AND LOCATION OF ANY AND ALL CONDUITS, UTILITY PIPES, AND STRUCTURES SHOWN ON THIS SET OF PLANS ARE OBTAINED BASED ON AVAILABLE RECORDS AT THE TIME OF DESIGN. TO THE BEST OF OUR KNOWLEDGE, THERE ARE NO EXISTING UTILITIES WITHIN THE CONSTRUCTION LIMITS OF THIS PROJECT AT THE TIME OF DESIGN EXCEPT AS SHOWN ON THIS SET OF PLANS. THE CONTRACTOR IS REQUIRED TO TAKE DUE PRECAUTIONARY MEASURES TO PROTECT ANY AND ALL UTILITY LINES SHOWN ON THIS SET OF PLANS. THE CONTRACTOR FURTHER ASSUMES ANY AND ALL LIABILITY AND RESPONSIBILITY FOR THE CONDUITS, UTILITY PIPES, AND STRUCTURES SHOWN ON THIS SET OF DRAWINGS.


CONTRACTOR AGREES THAT HE SHALL ASSUME SOLE AND COMPLETE RESPONSIBILITY FOR THE JOB SITE CONDITIONS DURING THE COURSE OF CONSTRUCTION OF THIS PROJECT. THIS STIPULATION INCLUDES THE SAFETY OF ANY AND ALL PERSONS AND PROPERTY. THE CONTRACTOR SHALL FURTHER DEFEND, INDEMNIFY, AND HOLD THE OWNER AND ENGINEER HARMLESS FROM ANY AND ALL LIABILITY, REAL OR ALLEGED, IN CONNECTION WITH THE PERFORMANCE OF WORK ON THIS PROJECT, WITH THE EXCEPTION OF LIABILITY ARISING FROM THE SOLE NEGLIGENCE OF THE OWNER OR ENGINEER.

GENERAL NOTES FOR ON-SITE UTILITIES


- CONTRACTOR SHALL VERIFY ALL SITE UTILITY ROUTES, STRUCTURE LOCATIONS AND ASSOCIATED REQUIREMENTS WITH RESPECTIVE UTILITY COMPANIES BEFORE COMMENCING WORK ON THOSE UTILITIES.
- CONTRACTOR SHALL BE RESPONSIBLE FOR PRESERVING ALL GRADE STAKES UNTIL AUTHORIZED BY SURVEYOR TO REMOVE.
- INDIVIDUAL PIPE FITTINGS ARE NOT CALLED OUT; CONTRACTOR SHALL PROVIDE AND INSTALL ALL NECESSARY FITTINGS AS REQUIRED TO COMPLETE THIS PROJECT. PIPE LENGTHS SHOWN ARE APPROXIMATE.
- RESTORATION/REPAIR: CONTRACTOR SHALL RESTORE/REPAIR ALL AREAS DAMAGED OR DISTURBED AS A RESULT OF ALL WORK PERFORMED PURSUANT TO THESE PLANS. SUCH AREAS INCLUDE, BUT ARE NOT LIMITED TO, CURB AND GUTTER, A.C. PAVEMENT, CONCRETE, STRIPING, LANDSCAPING, AND UTILITIES. RESTORATION/REPAIR SHALL INCLUDE, BUT IS NOT LIMITED TO, MATCHING A.C. AND CONCRETE SECTIONS AND TEXTURE, MATCHING FINISH AS APPLICABLE, ALL TO THE SATISFACTION OF THE DISTRICT.
- ADDITIONAL MATERIALS: CONTRACTOR SHALL PROVIDE ALL NECESSARY MATERIALS AND LABOR, SUBJECT TO THE APPROVAL OF THE DISTRICT AND ARCHITECT/ENGINEER, NOT SPECIFICALLY DESCRIBED IN THE CONSTRUCTION NOTES BUT REQUIRED FOR COMPLETE AND PROPER INSTALLATION OF THIS WORK.
- ALL MATERIALS REMOVED SHALL BE TAKEN OFF SCHOOL PROPERTY BY CONTRACTOR AND DISPOSED OF IN ACCORDANCE WITH APPLICABLE CODES UNLESS DIRECTED BY OWNER TO BE SALVAGED.
- CONTRACTOR TO POT HOLE AND VERIFY THE SIZE, MATERIAL AND INVERT ELEVATION OF EXISTING UTILITY AND VERIFY THAT THE CONNECTION CAN BE MADE AS SHOWN ON THE PLAN. IN THE EVENT OF A DISCREPANCY, NOTIFY THE OWNER/PROJECT MANAGER OF THE FIELD FINDINGS 7 DAYS PRIOR TO THE CONSTRUCTION DATE FOR ALTERNATIVE RESOLUTION.

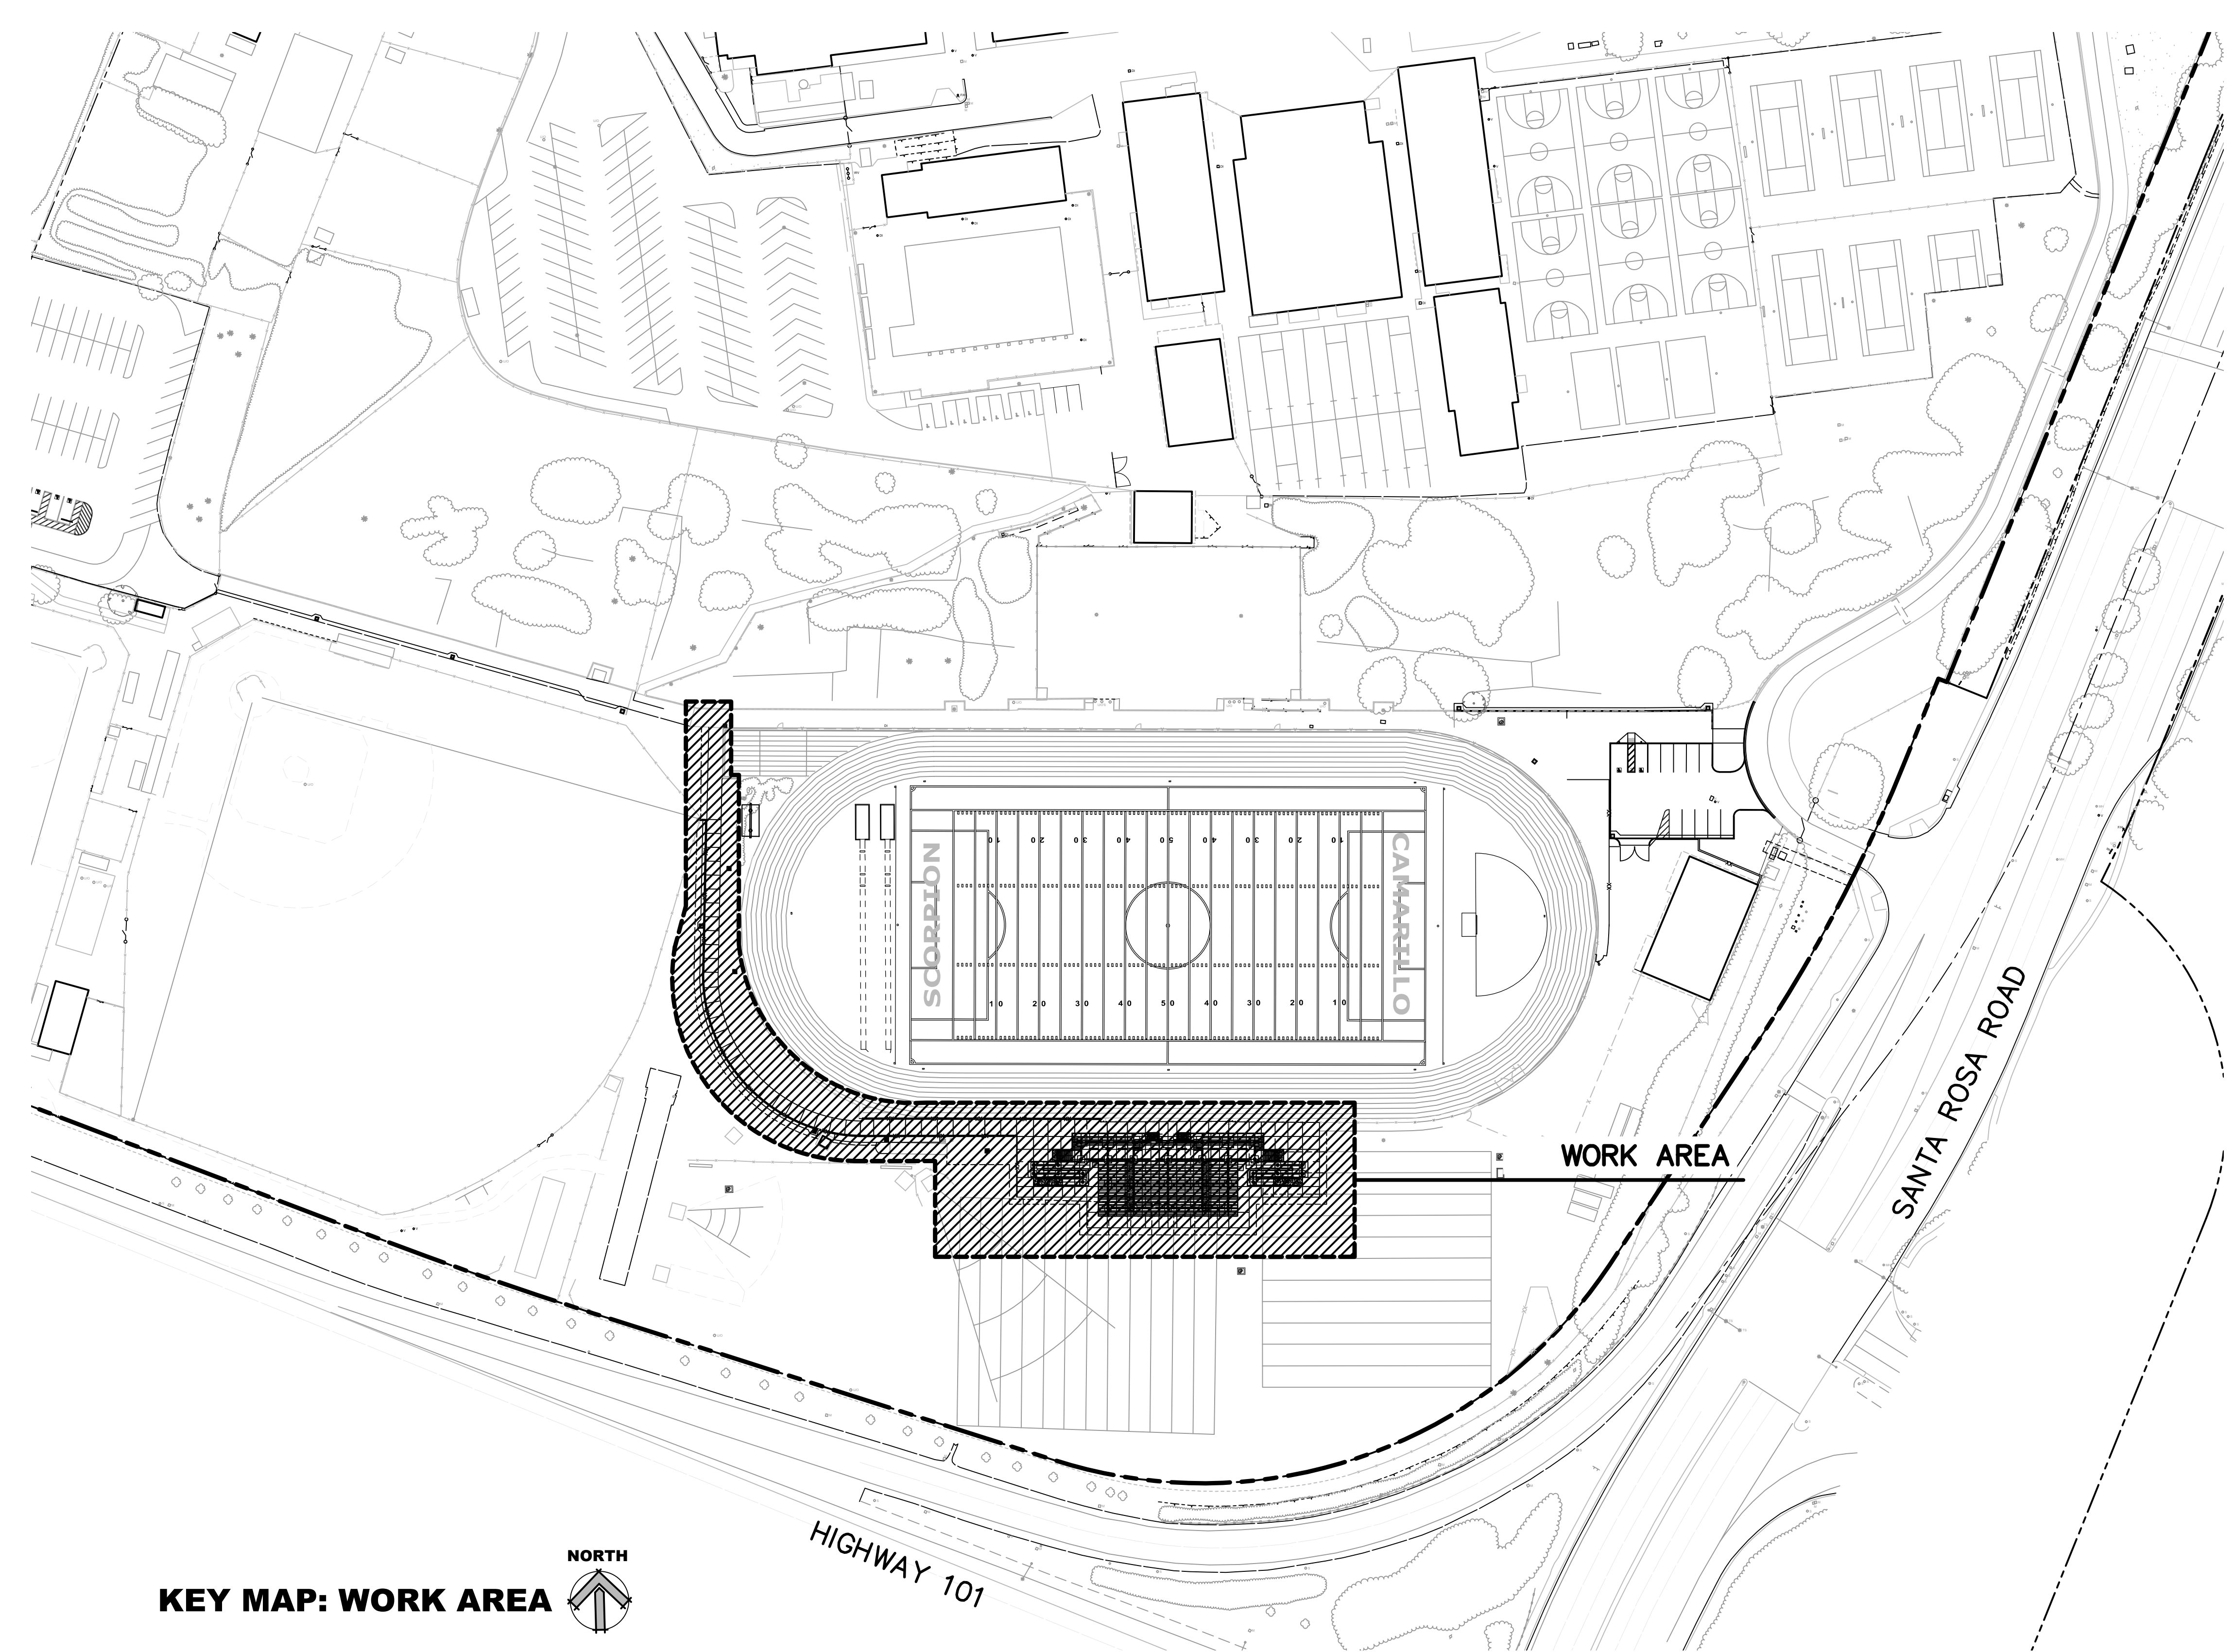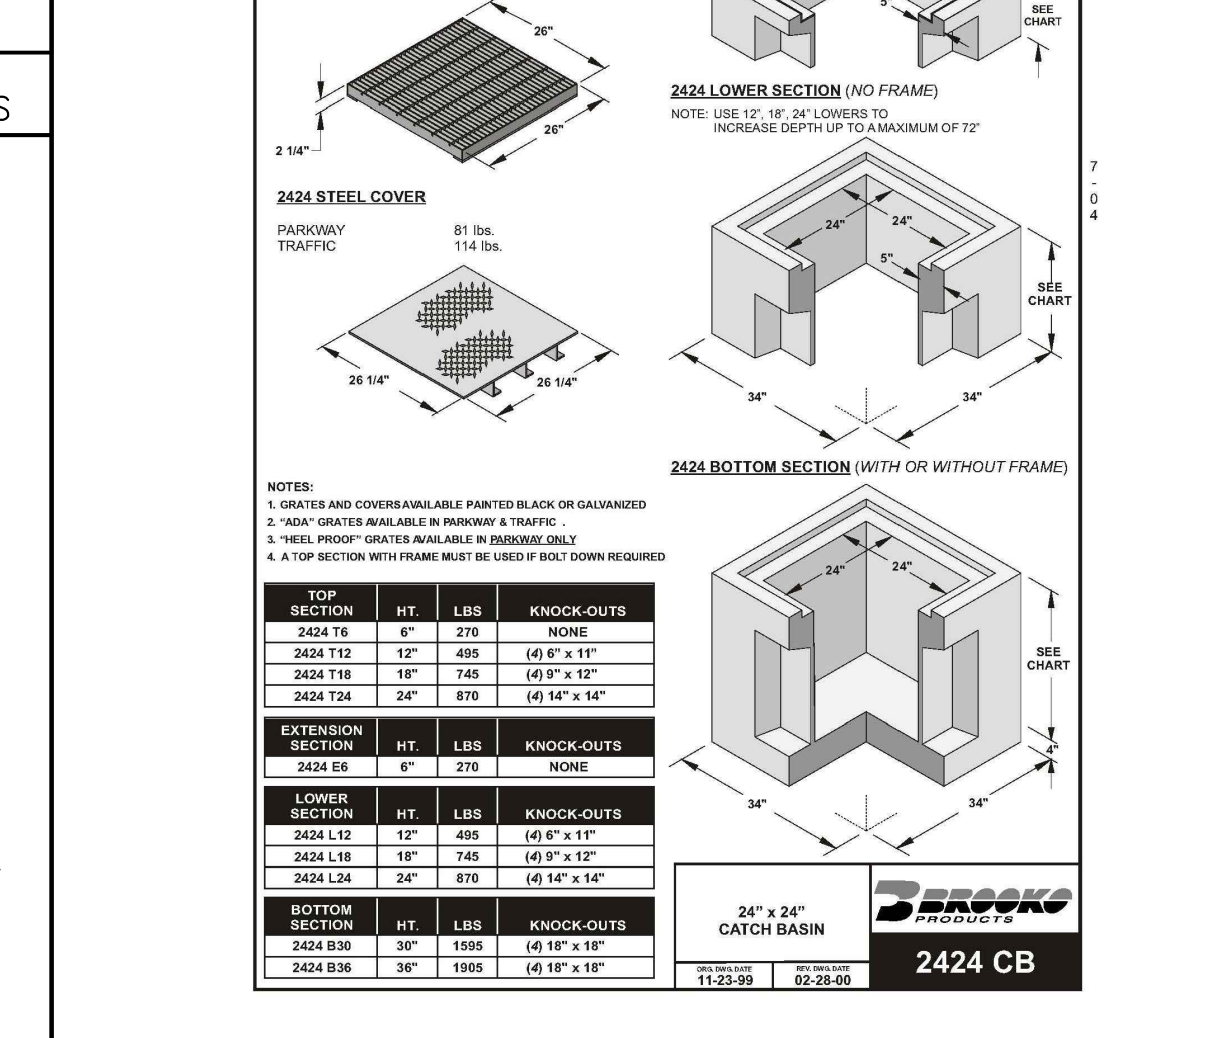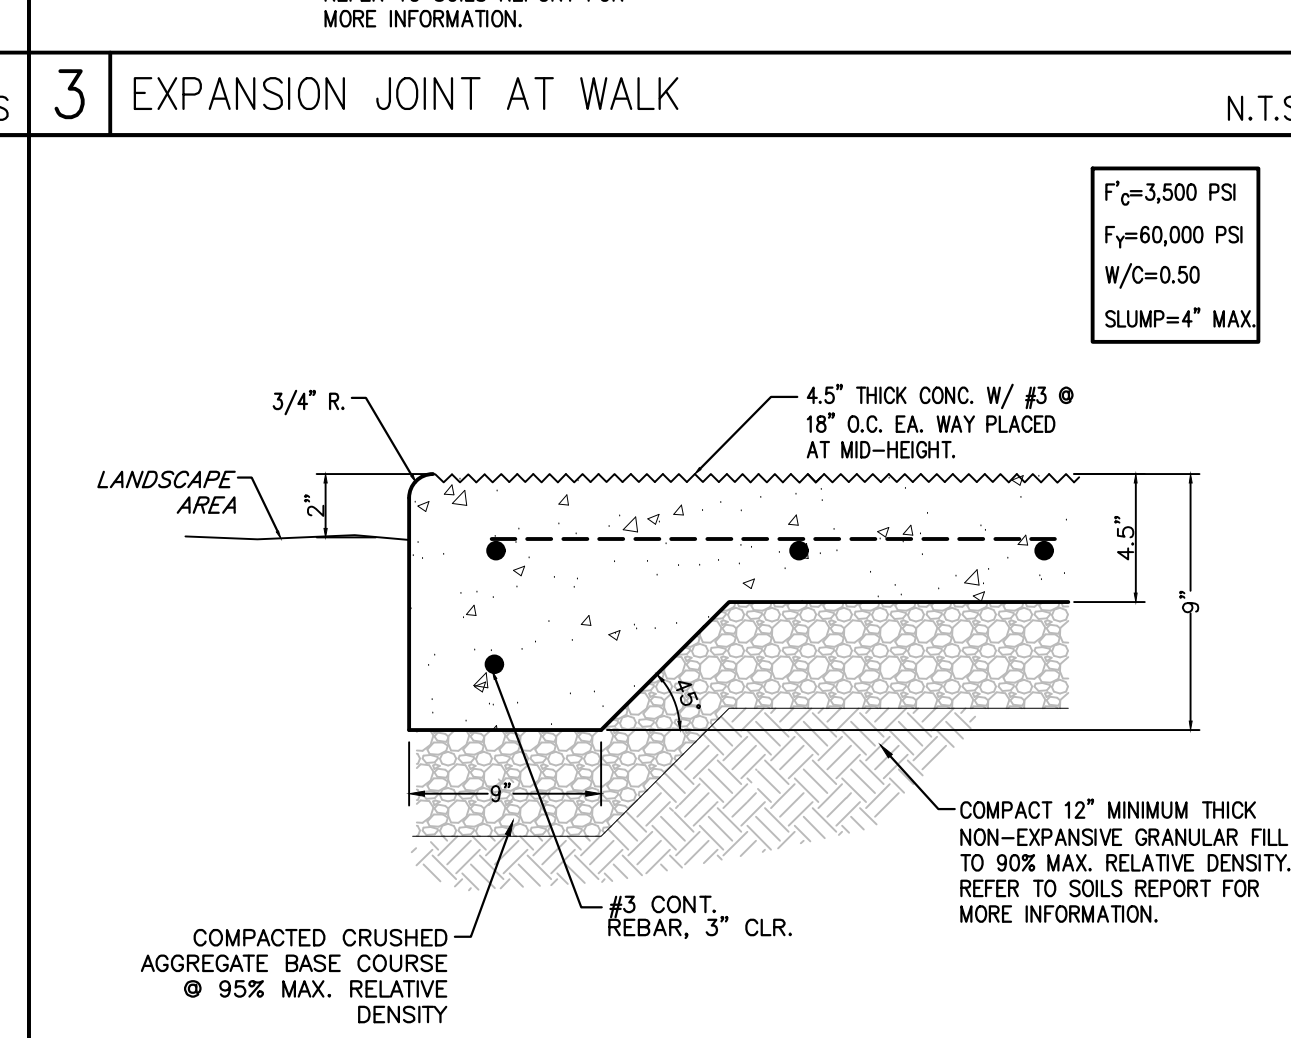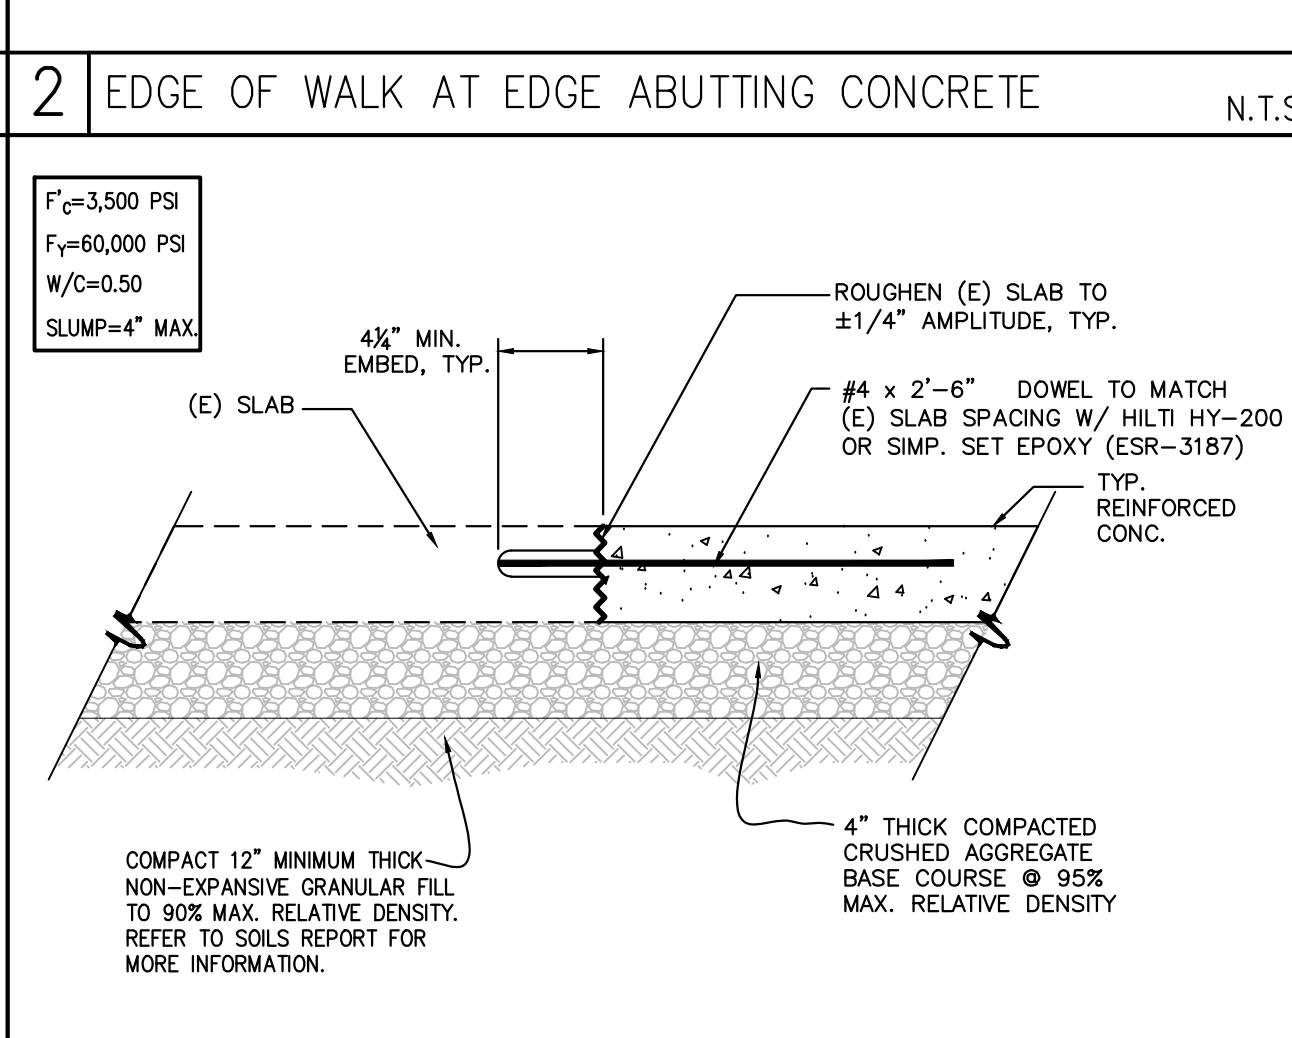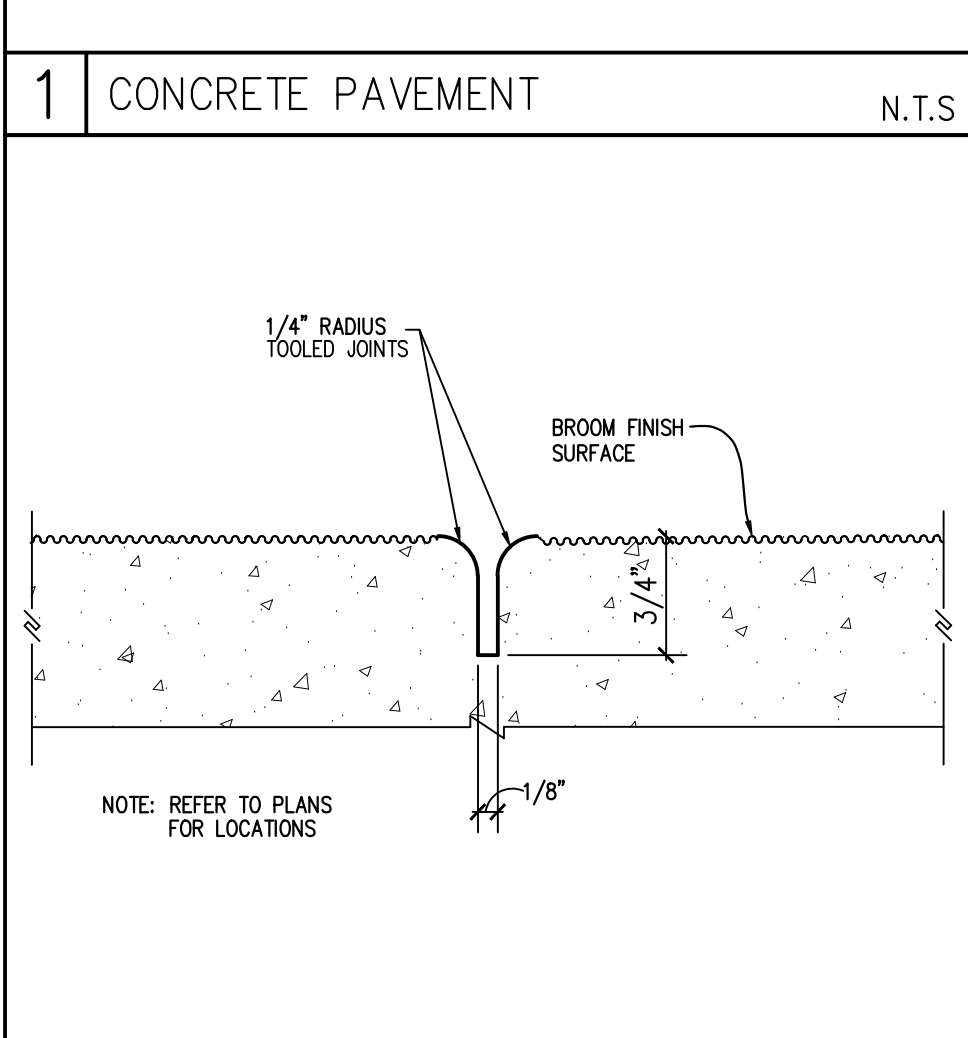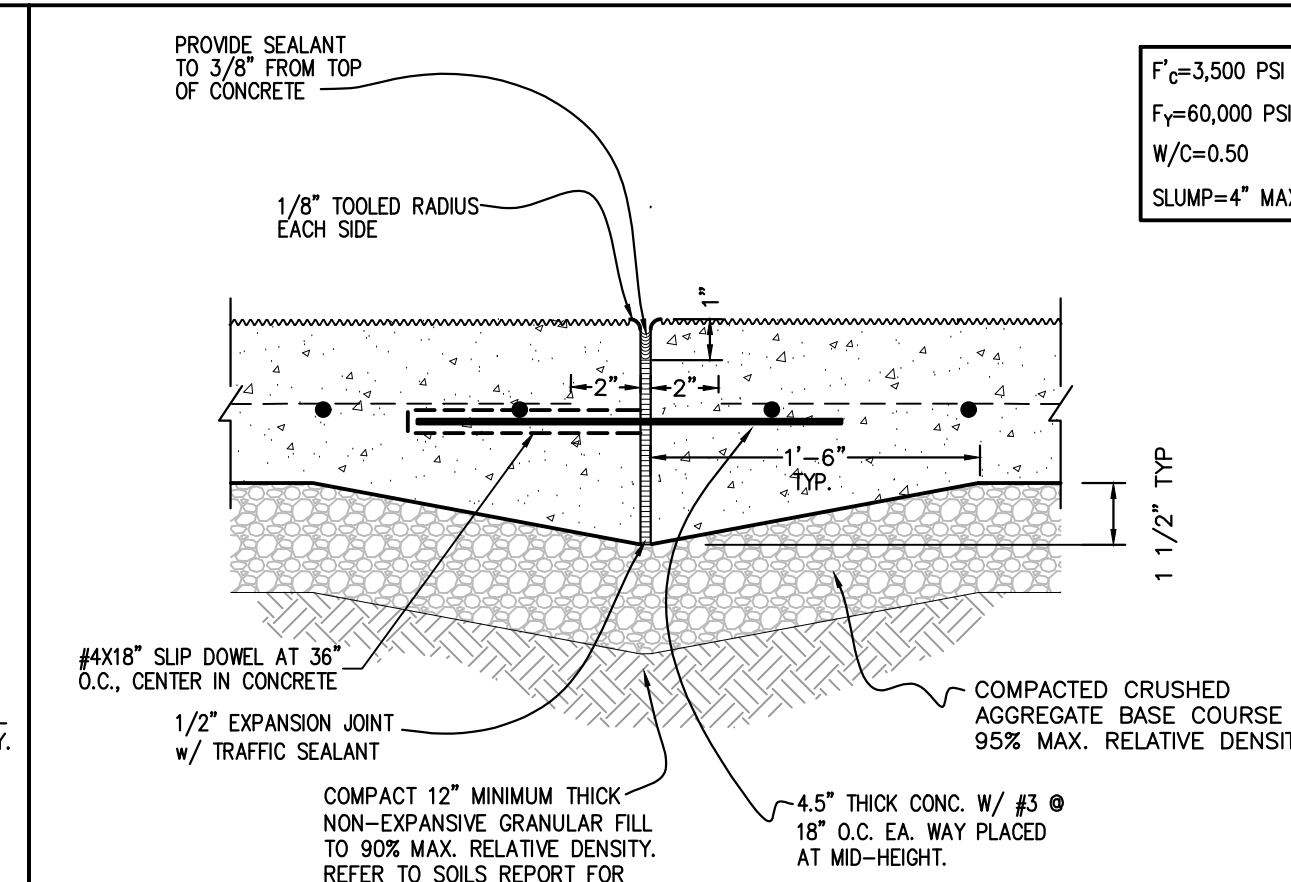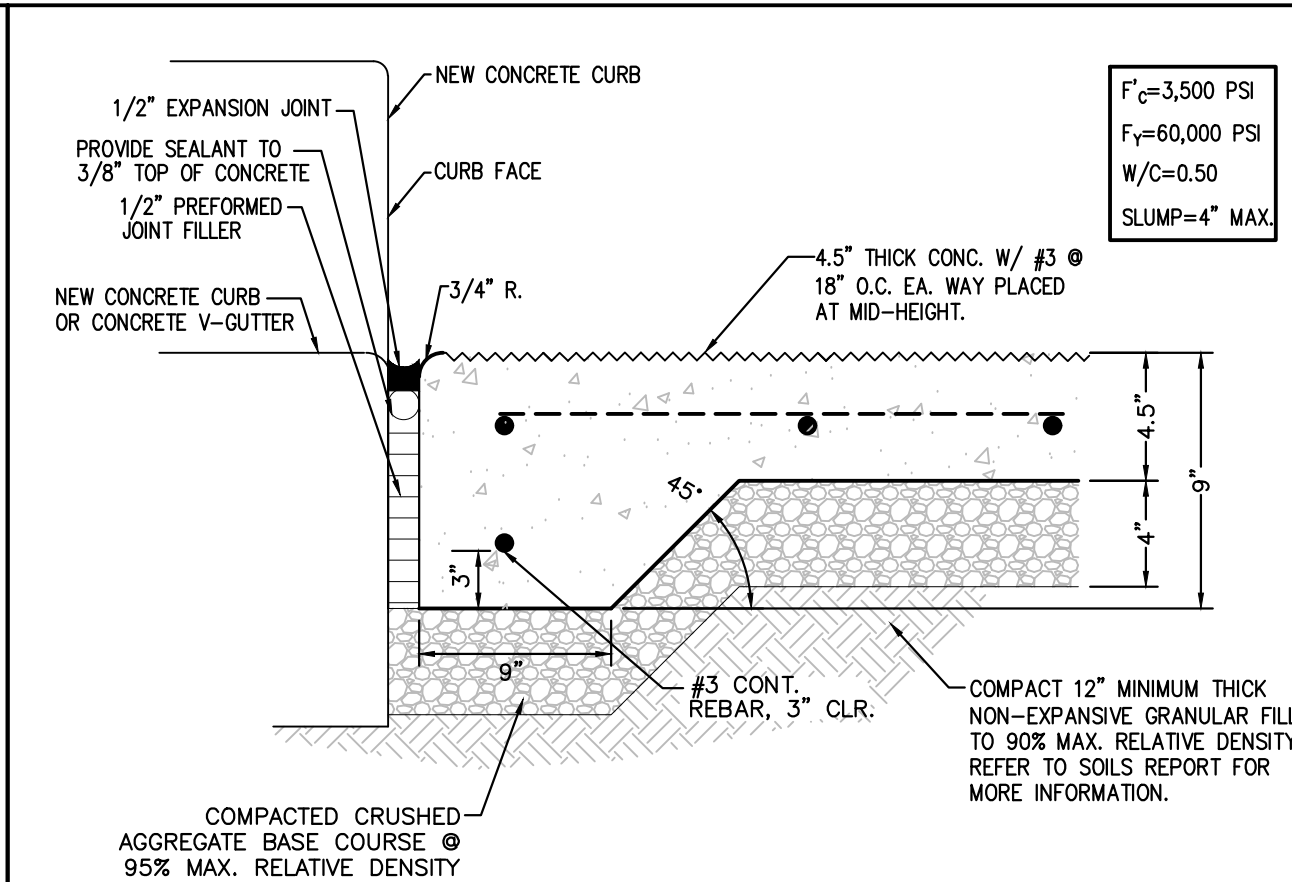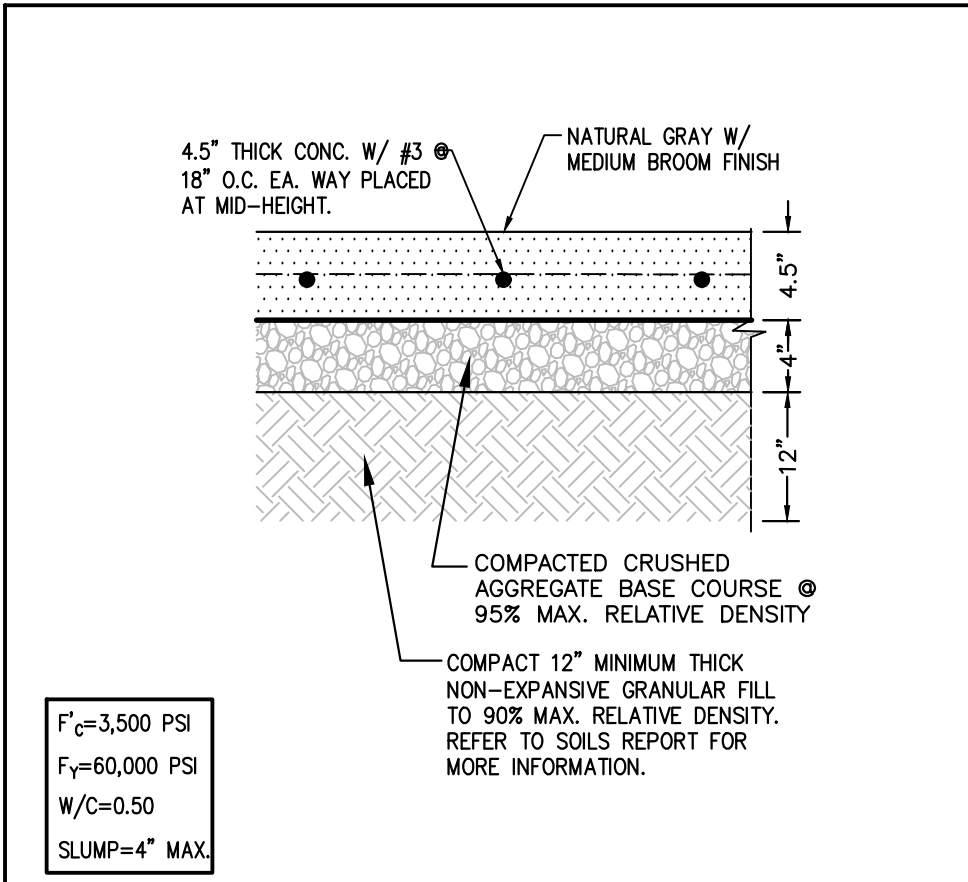

KEY MAP: WORK AREA

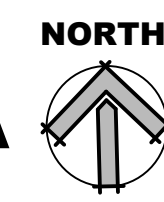

AGENCY REVIEW

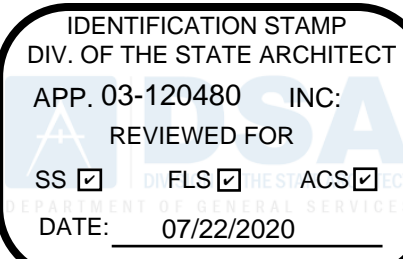

LITTLE

DIVERSIFIED ARCHITECTURAL CONSULTING

1300 Dove Street, Suite 100
Newport Beach, CA. 92660
T: 949.698.1400

www.littleonline.com

This drawing and the design shown are the property of Little Diversified Architectural Consulting. The reproduction, copying or other use of this drawing without their written consent is prohibited and any infringement will be subject to legal action.

© Little 2020

CLIENT NAME

OXNARD UNION HIGH SCHOOL DISTRICT

PROJECT NAME


ADOLFO CAMARILLO HIGH SCHOOL VISITOR BLEACHERS

4660 MISSION OAKS BLVD,
CAMARILLO, CA. 93012

CONSULTANT



SEAL

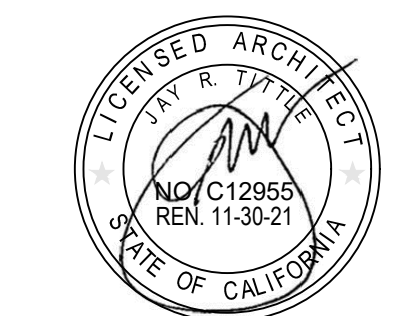

ISSUE FOR

DSA SUBMITTAL

ISSUE DATE

7/22/20

REVISIONS

NO.	REASON	DATE

PROJECT TEAM

PRINCIPAL IN CHARGE
BBO
PROJECT MANAGER
ML
DESIGN TEAM
AT
PROJECT NAME
ADOLFO CAMARILLO HIGH SCHOOL VISITOR BLEACHERS

PROJECT NO.


6121235309

SHEET TITLE

COVER SHEET -
NOTES & INDEX
MAP


SHEET NUMBER

C1.0

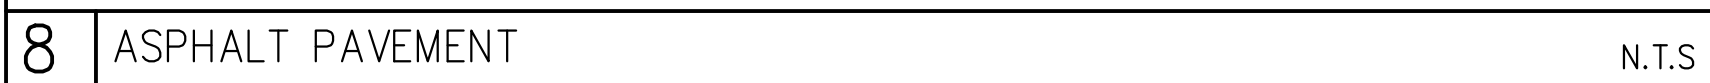

EARTH SYSTEMS



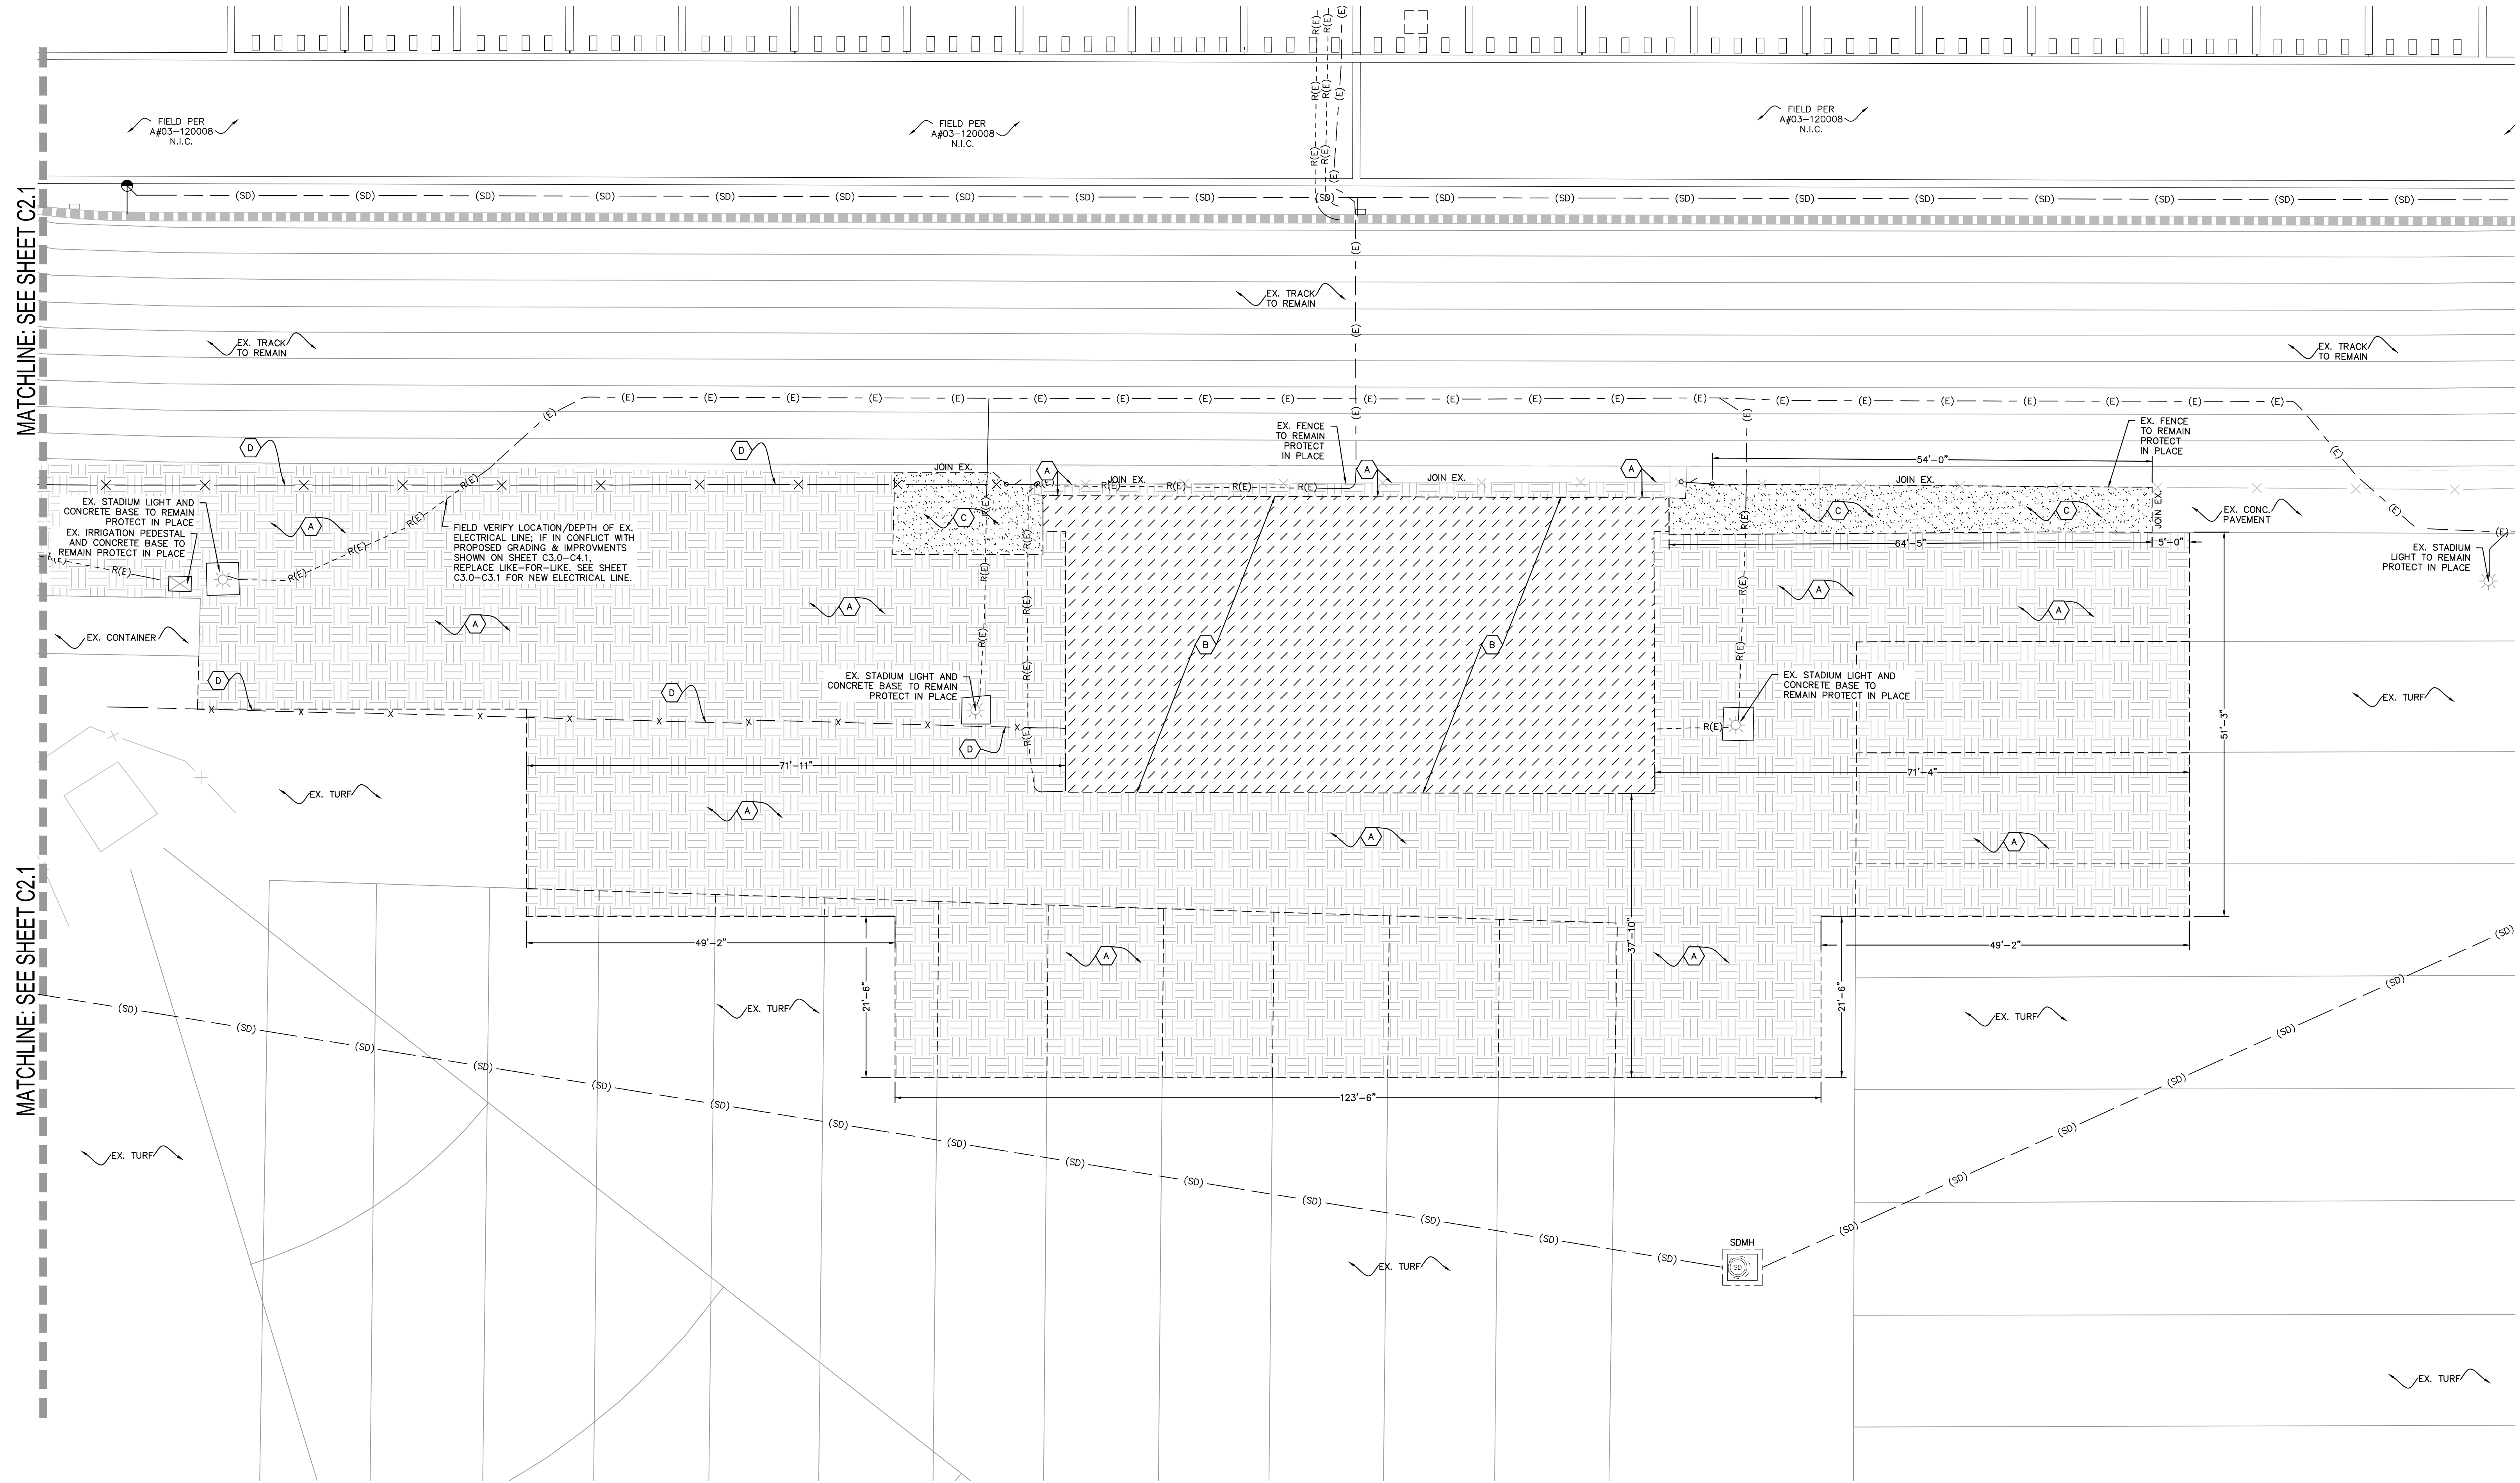


NOTES:
ALL EXISTING UTILITIES WITHIN THE WORK AREA SHALL BE LOCATED PRIOR TO COMMENCING WORK. REMOVE EXISTING UTILITIES WITHIN THE OVEREXCAVATION AREA AS NEEDED AND REPLACE LIKE FOR LIKE.

NOTES:
SEE ELECTRICAL PLANS FOR ALL ELECTRICAL CONDUITS, VAULTS, BOXES, AND ELECTRICAL LINES.

LEGEND:
REMOVE EX. ELECTRICAL ----- R(E) ----- R(E) ----- R(E) -----
EXISTING ELECTRICAL ----- (E) ----- (E) -----
EXISTING STORMDRAIN ----- (SD) -----
EXISTING COMMUNICATIONS ----- (COM) -----
NOT IN CONTRACT N.I.C.

DEMOLITION KEYNOTES:		
	REMOVE EXISTING LANDSCAPE AND IRRIGATION. CAP EXISTING MAIN LINE OUTSIDE OF THE WORK AREA.	
	REMOVE EXISTING BLEACHERS, RAMPS, STAIRS, WALKWAYS AND ALL ASSOCIATED FOOTING, FENCE, AND COLUMNS. CONTRACTOR SHALL BACKFILL VOIDS, DUE TO REMOVAL OF FOOTING, WITH SOIL.	
	SAWCUT AND REMOVE EXISTING CONCRETE PAVEMENT TO ACCOMMODATE THE IMPROVEMENTS SHOWN ON SHEET C3.0-C3.1	
	REMOVE AND DISPOSE EXISTING CHAINLINK FENCE. VERIFY EXTENTS IN THE FIELD PRIOR TO COMMENCING ANY WORK.	
	REMOVE EXISTING CATCH BASIN.	
	REMOVE EXISTING STORM DRAIN PIPE.	

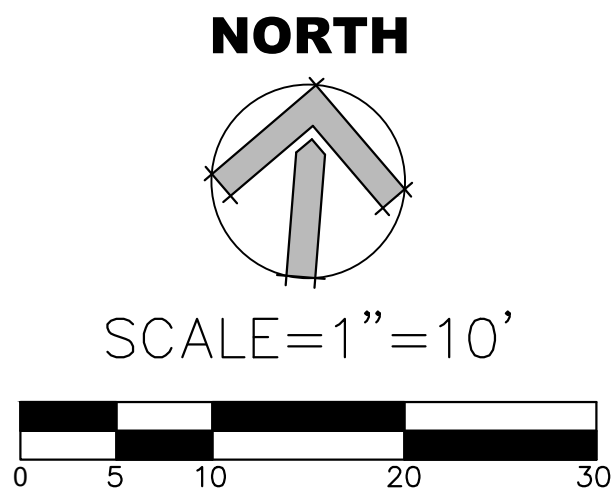

AGENCY REVIEW

IDENTIFICATION STAMP
DIV. OF THE STATE ARCHITECT
APP. 03-120480 INC.
REVIEWED FOR
SS ☒ FLS ☒ ACS ☒
DATE: 07/22/2020

LITTLE
DIVERSIFIED ARCHITECTURAL CONSULTING

1300 Dove Street, Suite 100
Newport Beach, CA, 92660
T: 949.698.1400
www.littleonline.com

This drawing and the design shown are the property of Little Diversified Architectural Consulting. The reproduction, copying or other use of this drawing without their written consent is prohibited and any infringement will be subject to legal action.
© Little 2020

CLIENT NAME

OXNARD UNION HIGH SCHOOL DISTRICT

PROJECT NAME

ADOLFO CAMARILLO HIGH SCHOOL VISITOR BLEACHERS
4660 MISSION OAKS BLVD., CAMARILLO, CA. 93012

CONSULTANT

SEAL

ISSUE FOR

DSA SUBMITTAL

ISSUE DATE

7/22/20

REVISIONS

NO.	REASON	DATE
-----	--------	------

PROJECT TEAM

PRINCIPAL IN CHARGE
BBO
PROJECT MANAGER
ML
DESIGN TEAM
AT
PROJECT NAME
ADOLFO CAMARILLO HIGH SCHOOL VISITOR BLEACHERS

PROJECT NO.



6121235309

SHEET TITLE

DEMOLITION PLAN

SHEET NUMBER

C2.0

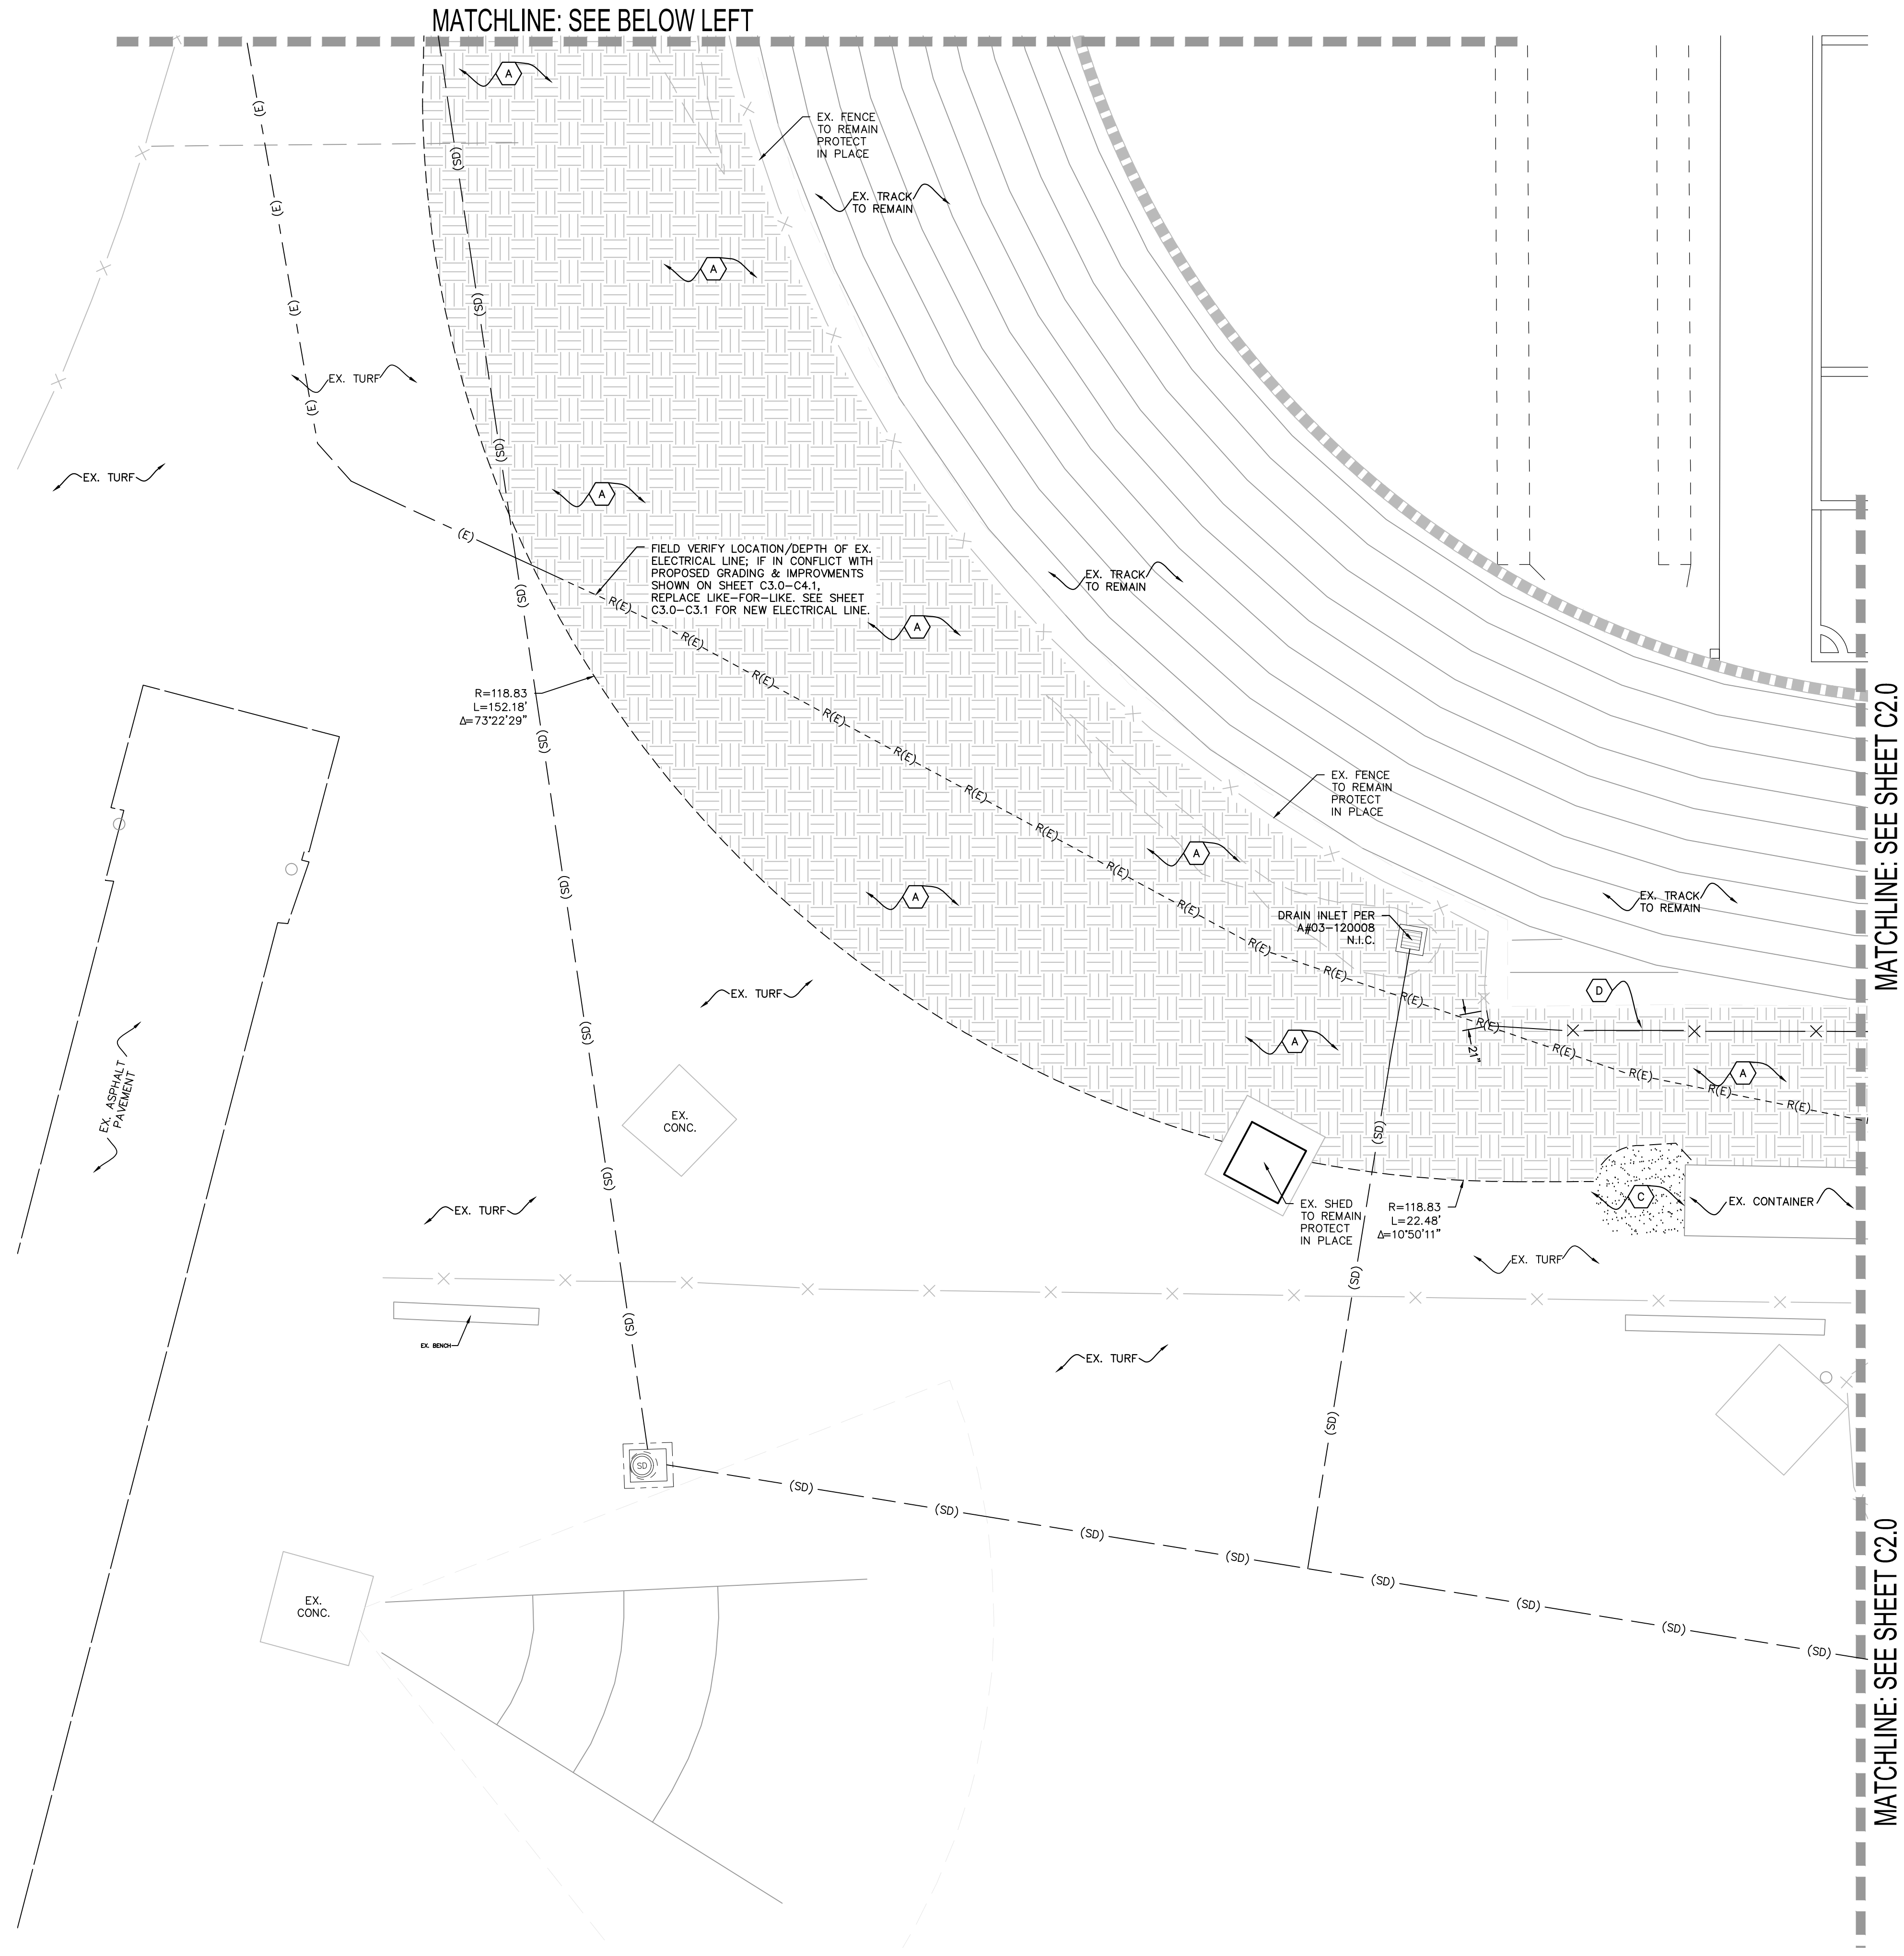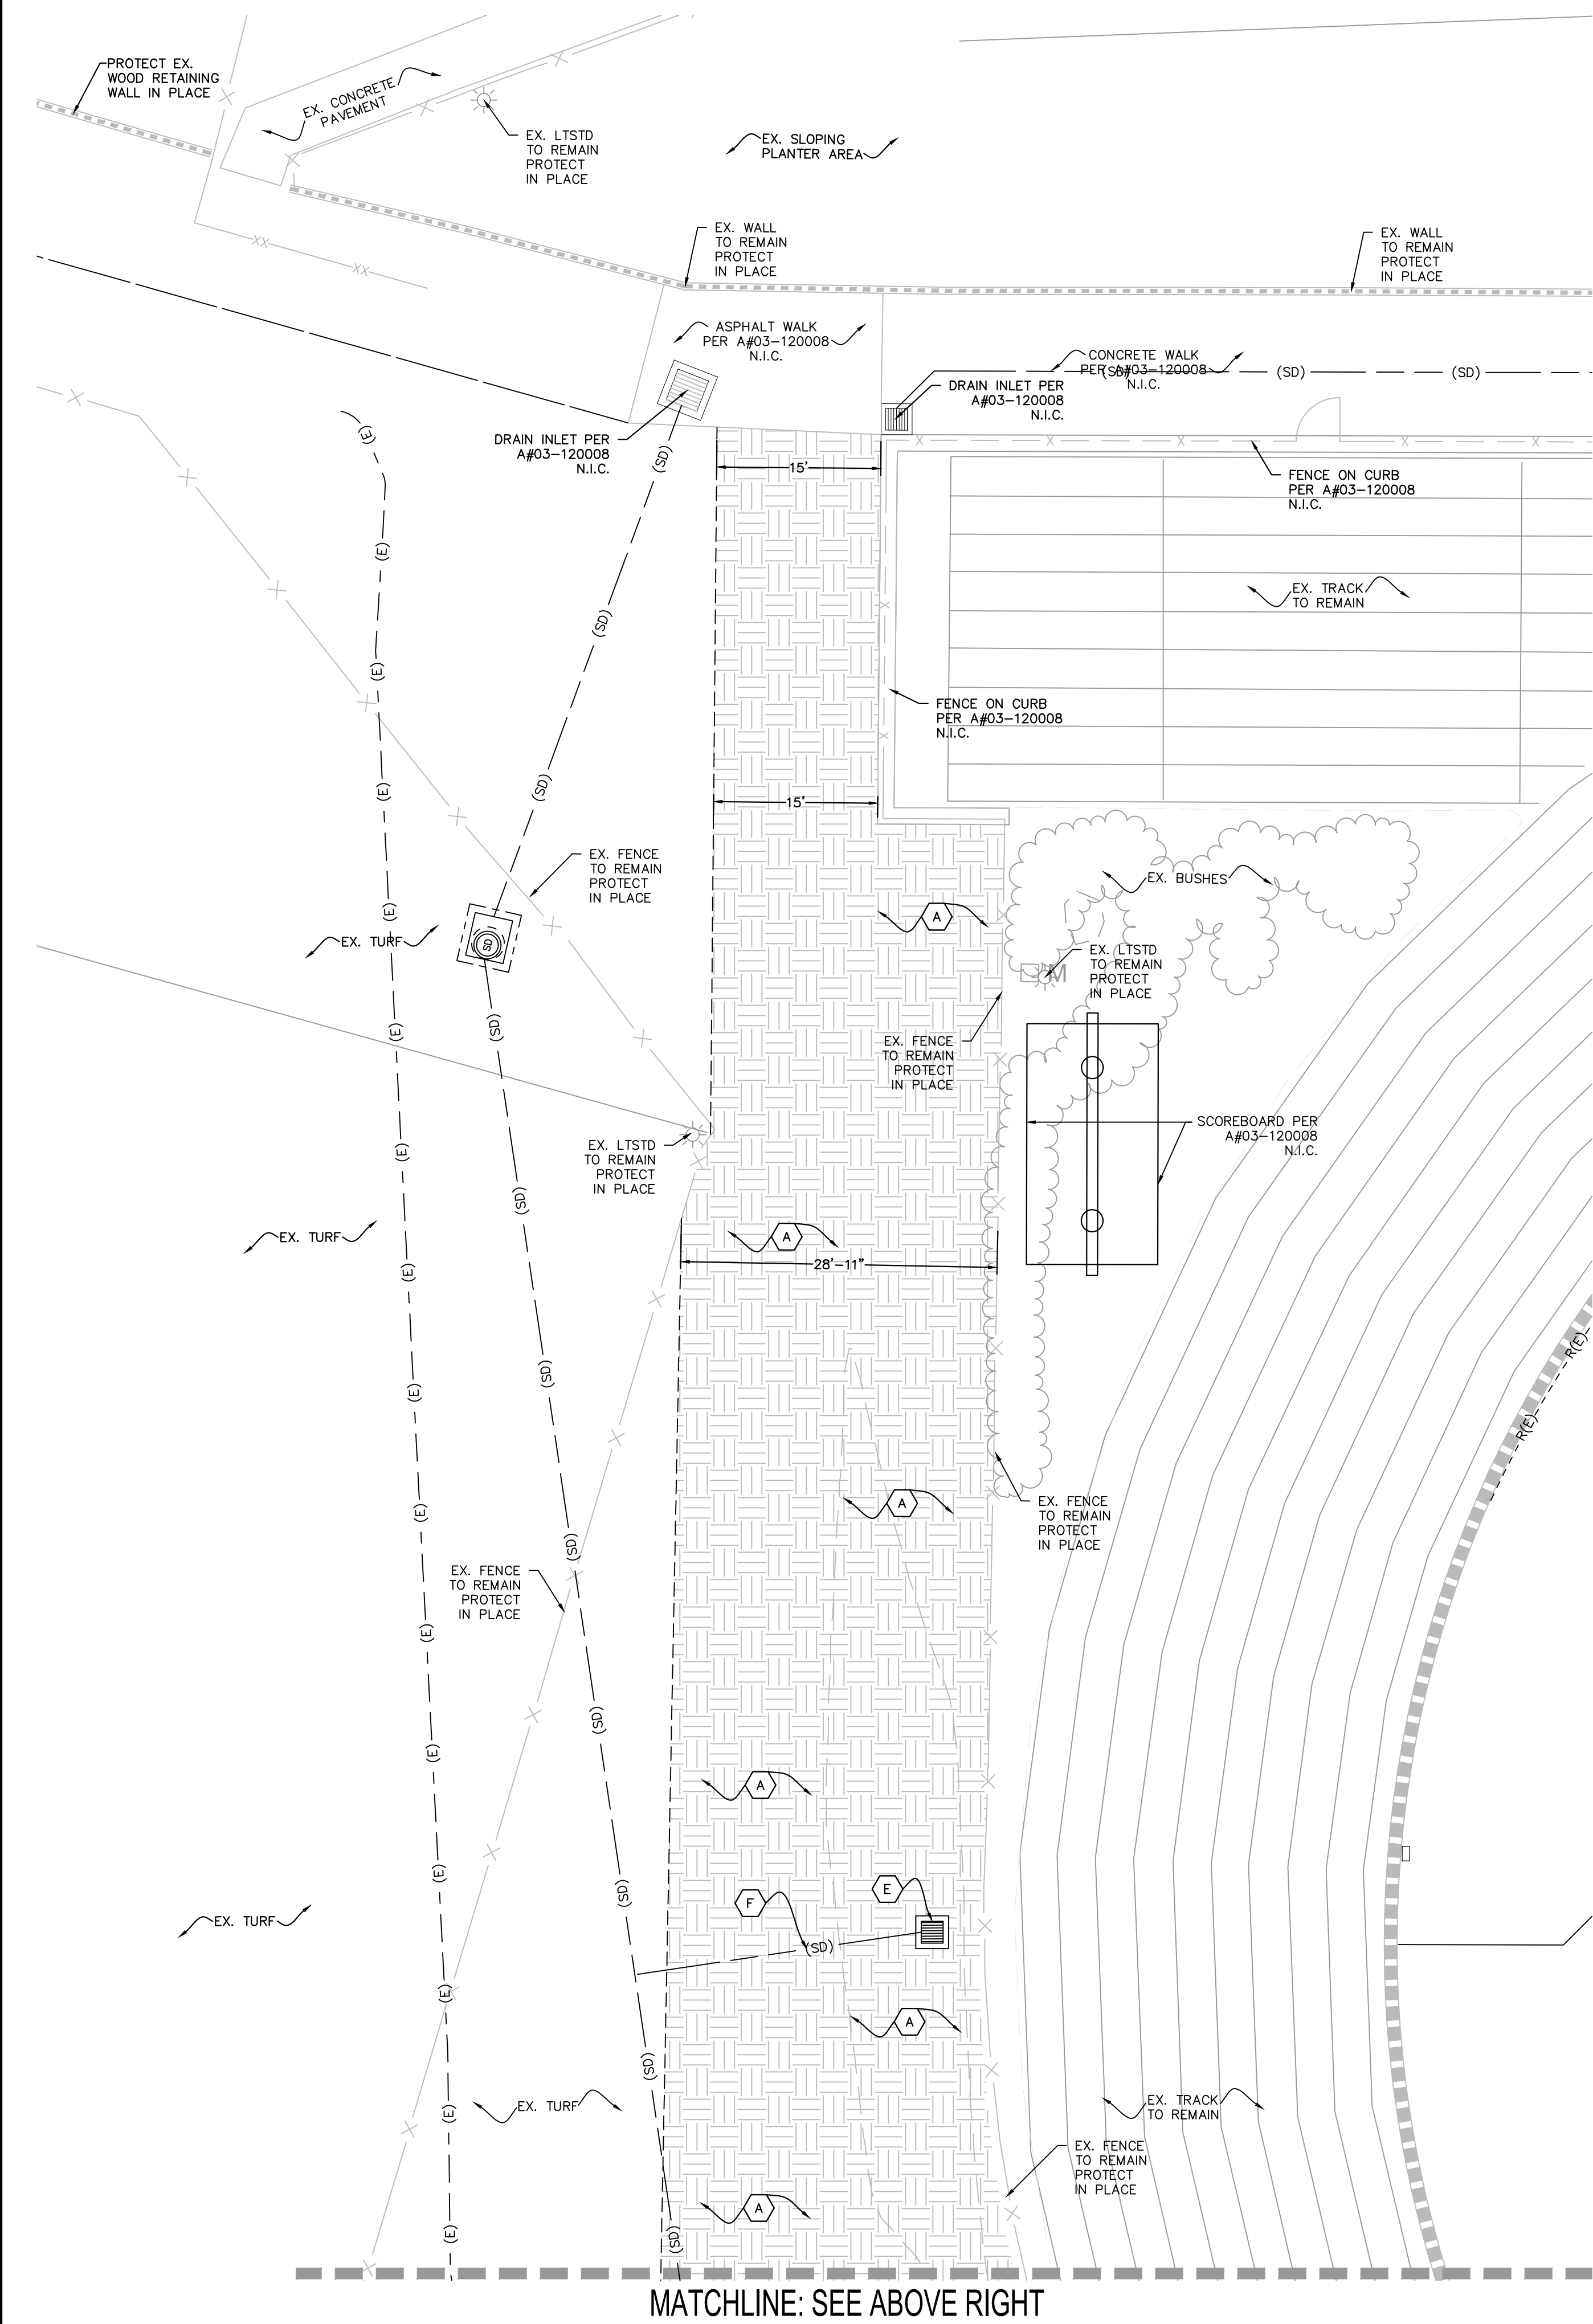

NOTES:

ALL EXISTING UTILITIES WITHIN THE WORK AREA SHALL BE LOCATED PRIOR TO COMMENCING WORK. REMOVE EXISTING UTILITIES WITHIN THE OVEREXCAVATION AREA AS NEEDED AND REPLACE LIKE FOR LIKE.


NOTES:

SEE ELECTRICAL PLANS FOR ALL ELECTRICAL CONDUITS, VAULTS, BOXES, AND ELECTRICAL LINES.

LEGEND:

REMOVE EX. ELECTRICAL: --- R(E) --- R(E) --- R(E) ---
EXISTING ELECTRICAL: --- (E) --- (E) ---
EXISTING STORMDRAIN: --- (SD) --- (SD) ---
EXISTING COMMUNICATIONS: --- (COM) --- (COM) ---
NOT IN CONTRACT: N.I.C.

DEMOLITION KEYNOTES:		
	REMOVE EXISTING LANDSCAPE AND IRRIGATION. CAP EXISTING MAIN LINE OUTSIDE OF THE WORK AREA.	
	REMOVE EXISTING BLEACHERS, RAMPS, STAIRS, WALKWAYS AND ALL ASSOCIATED FOOTING, FENCE, AND COLUMNS. CONTRACTOR SHALL BACKFILL VOIDS, DUE TO REMOVAL OF FOOTING, WITH SOIL.	
	SAWCUT AND REMOVE EXISTING CONCRETE PAVEMENT TO ACCOMMODATE THE IMPROVEMENTS SHOWN ON SHEET C3.0.	
	REMOVE AND DISPOSE EXISTING CHAINLINK FENCE. VERIFY EXTENTS IN THE FIELD PRIOR TO COMMENCING ANY WORK.	
	REMOVE EXISTING CATCH BASIN.	
	REMOVE EXISTING STORM DRAIN PIPE.	

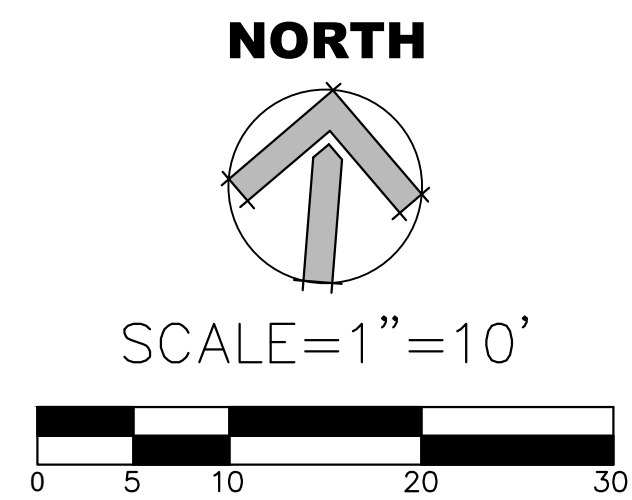

AGENCY REVIEW

IDENTIFICATION STAMP
DIV. OF THE STATE ARCHITECT
APP. 03-120480 INC.
REVIEWED FOR
SS ☒ FLS ☒ ACS ☒
DATE: 07/22/2020

LITTLE
DIVERSIFIED ARCHITECTURAL CONSULTING

1300 Dove Street, Suite 100
Newport Beach, CA, 92660
T: 949.698.1400
www.littleonline.com

This drawing and the design shown are the property of Little Diversified Architectural Consulting. The reproduction, copying or other use of this drawing without their written consent is prohibited and any infringement will be subject to legal action.
© Little 2020

CLIENT NAME

**OXNARD UNION
HIGH SCHOOL
DISTRICT**

PROJECT NAME

**ADOLFO CAMARILLO HIGH SCHOOL
VISITOR BLEACHERS**
4660 MISSION OAKS BLVD,
CAMARILLO, CA. 93012

CONSULTANT

BRIAN B. GROGAN
No. 81751
Exp. 3/31/22
CIVIL
STATE OF CALIFORNIA

SEAL

MICHAEL C. 12955
REN. 11-30-21
STATE OF CALIFORNIA

ISSUE FOR

DSA SUBMITTAL

ISSUE DATE

7/22/20

REVISIONS

NO.	REASON	DATE

PROJECT TEAM

PRINCIPAL IN CHARGE
BBC
PROJECT MANAGER
ML
DESIGN TEAM
AT
PROJECT NAME
ADOLFO CAMARILLO HIGH
SCHOOL
VISITOR BLEACHERS

PROJECT NO.


6121235309

SHEET TITLE

DEMOLITION PLAN

SHEET NUMBER

C2.1

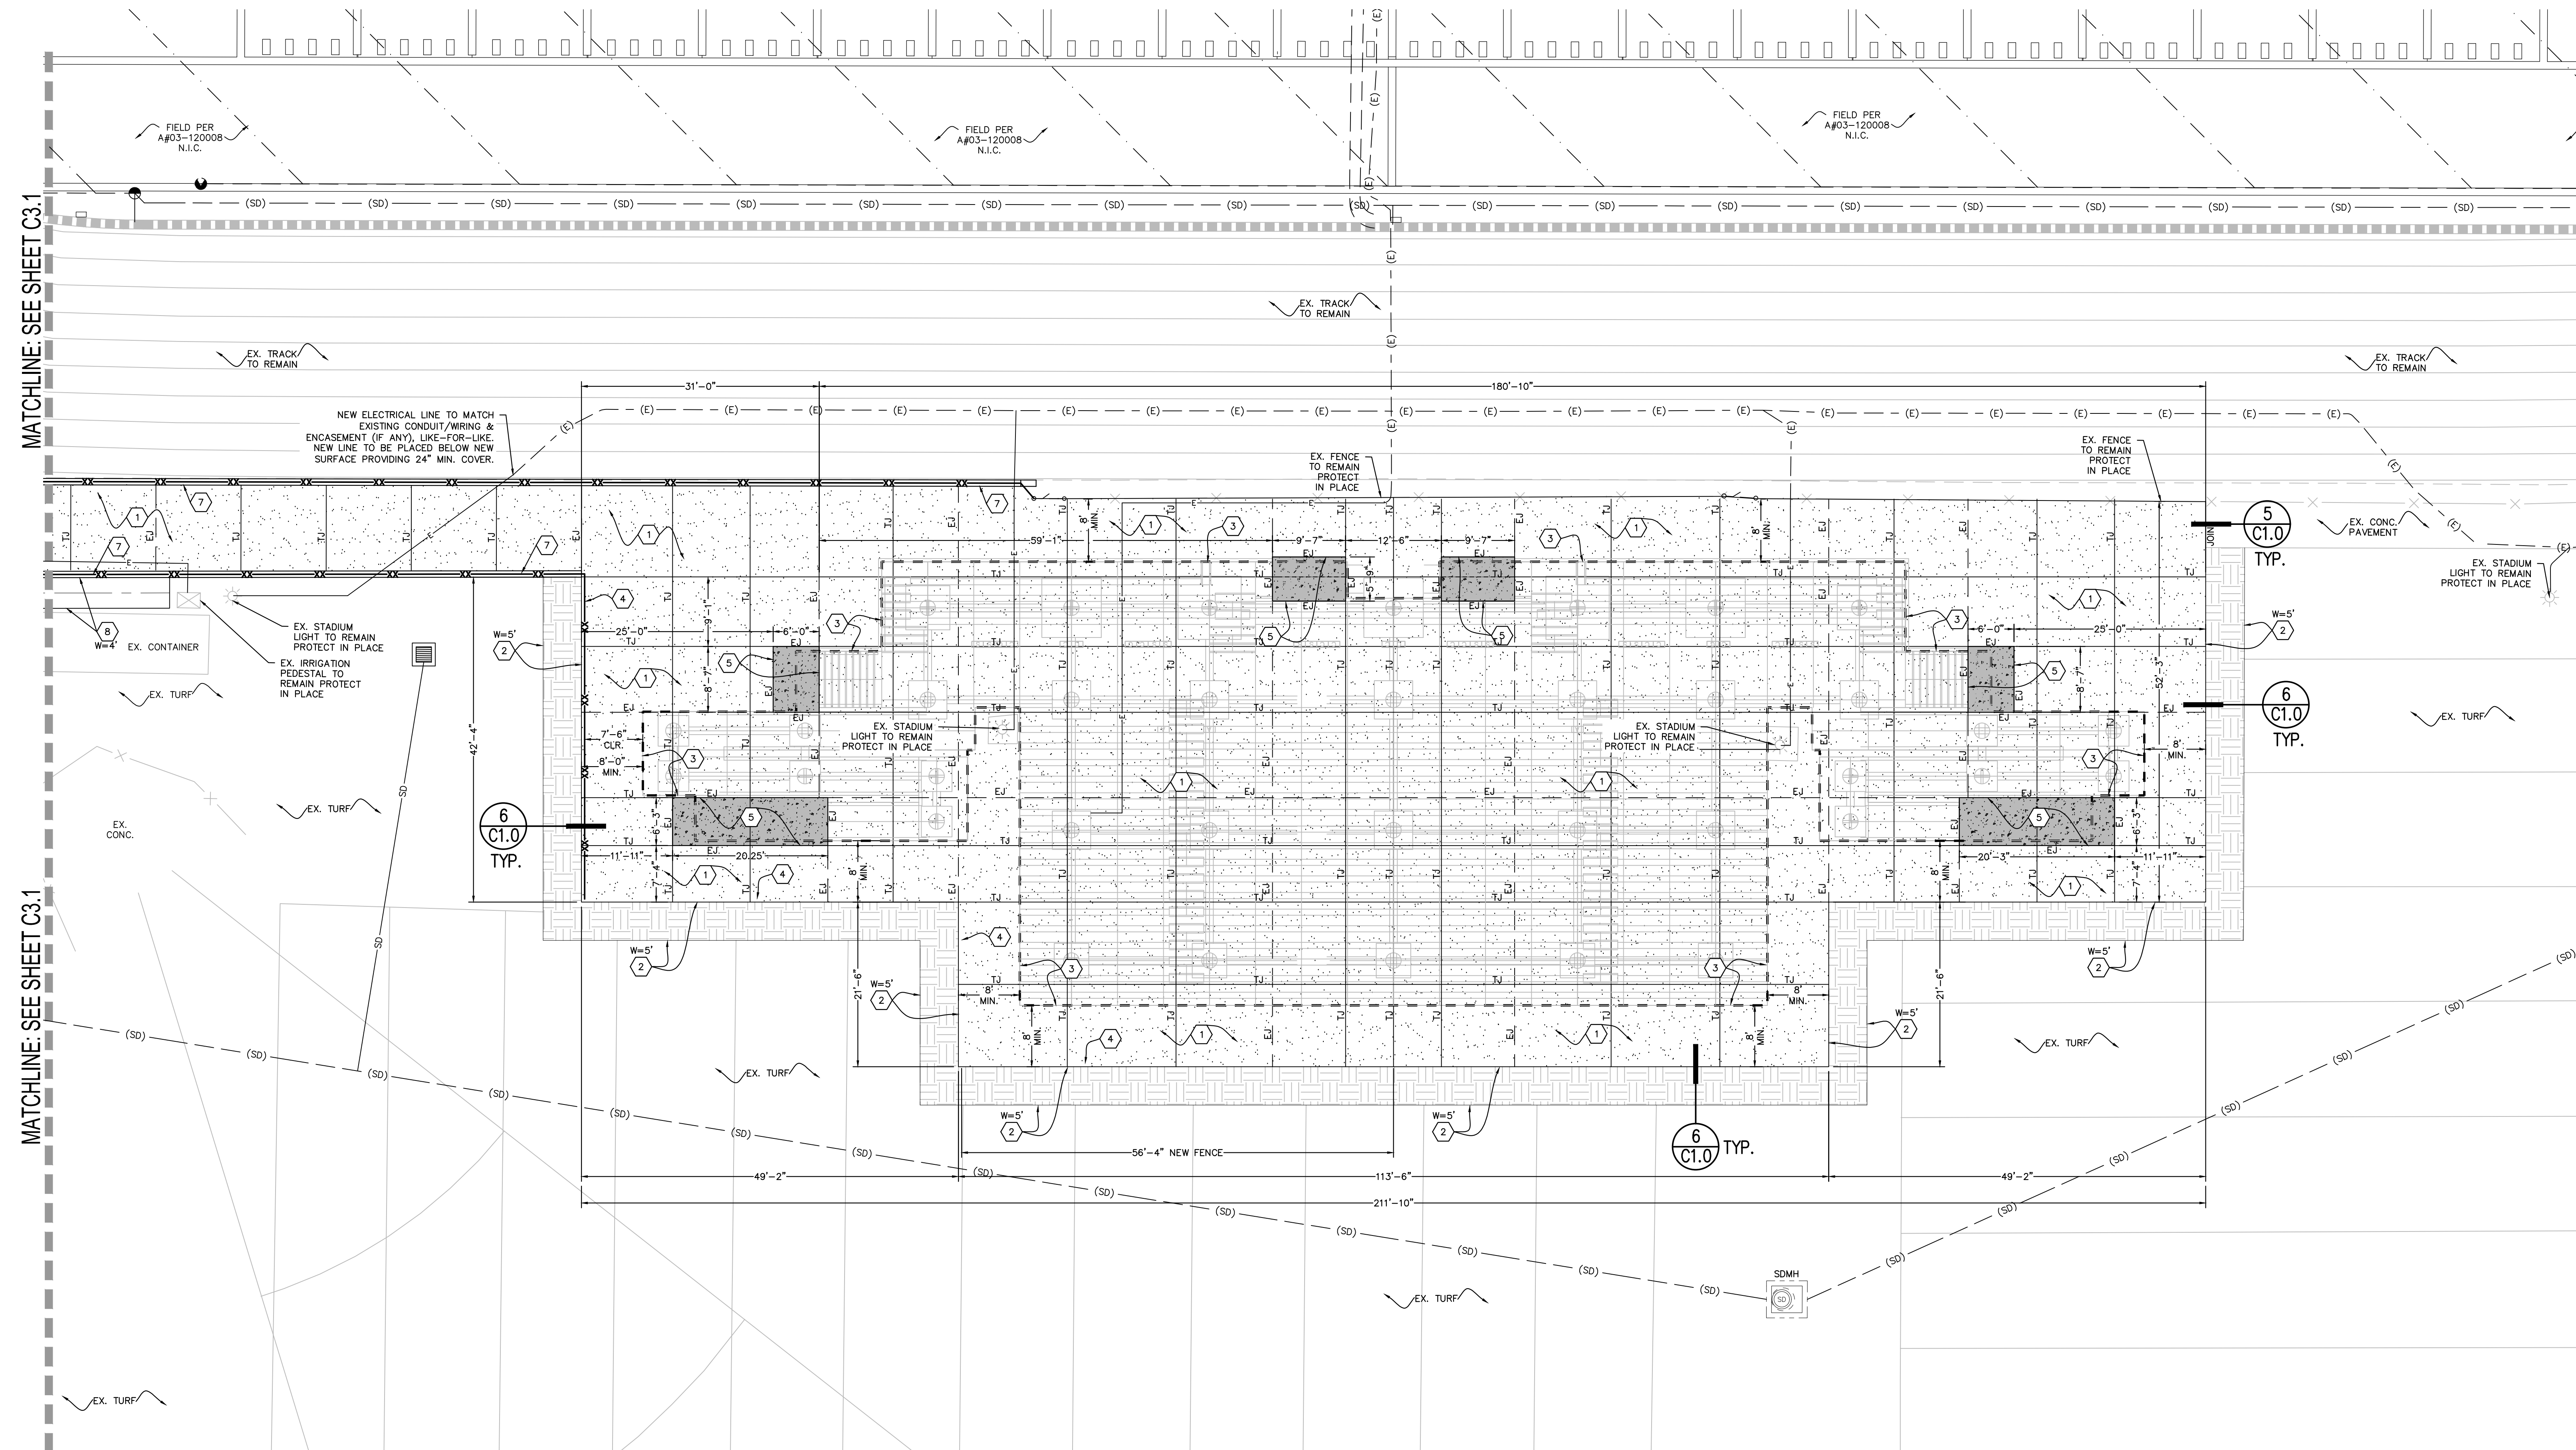

UTILITY LEGEND:


EXISTING STORM DRAIN	---	(SD)
EXISTING COMM.	---	(COM)
EXISTING ELECTRICAL	---	(E)
NEW ELECTRICAL	---	(E)
NEW COMMUNICATIONS	---	(C)
NOT IN CONTRACT	N.I.C.	

CONSTRUCTION KEYNOTES (FURNISH & INSTALL):		
1	NEW CONCRETE PAVEMENT, SHALL BE NATURAL GREY CONCRETE PAVING W/ MEDIUM BROOM FINISH, SCORING AND JOINT PATTERN AS SHOWN ON THE PLAN. SEE DETAIL.	1
2	TOOLED CONTROL JOINT - EQUALLY SPACED AS SHOWN.	2
3	EXPANSION JOINT - EQUALLY SPACED AS SHOWN.	3
4	REPAIR / REPLACE EXISTING LAWN AREA TO MATCH ADJOINING LAWN AREA. CONTRACTOR TO ADJUST EXISTING IRRIGATION AS NEEDED TO PROVIDE HEAD-TO-HEAD COVERAGE THROUGHOUT LAWN AREAS AFFECTED BY THESE IMPROVEMENTS. WORK MAY INCLUDE NEW IRRIGATION SUCH AS HEADS AND LATERALS, TO BE DETERMINED IN THE FIELD BY INSTALLING CONTRACTOR.	4
5	NEW BLEACHERS WITH RAMPS AND STAIRS. REFER TO ARCHITECTURAL PLANS AND SPECIFICATIONS.	5
6	NEW CHAINLINK FENCE - HEIGHT TO MATCH EXISTING REFER TO ARCHITECTURAL PLANS FOR DETAILS.	6
7	NEW CONCRETE EXIT PAD PER BLEACHER PLANS AND DETAILS.	7
8	NEW 24" P.C.C. CURB AND GUTTER WITH NEW FENCE ON CURB (REFER TO GRADING PLANS FOR ELEVATIONS) (REFER TO ARCHITECT'S PLANS FOR FENCE HEIGHT AND DETAILS.)	8
9	NEW 10" WIDE P.C.C. CURB WITH NEW FENCE ON TOP (REFER TO GRADING PLANS FOR ELEVATIONS) (REFER TO ARCHITECT'S PLANS FOR FENCE HEIGHT AND DETAILS.)	9
10	NEW 48" WIDE CONCRETE V-GUTTER (REFER TO GRADING PLANS FOR ELEVATIONS.)	10
11	PROVIDE NEW TURF AND IRRIGATION TO MATCH EXISTING / ADJACENT LAWN AREAS. CONTRACTOR TO EXTEND EXISTING IRRIGATION AS NEEDED INCLUDING BUT NOT LIMITED TO MAINLINE, VALVES, LATERALS, SLEEVING, ETC. THROUGHOUT THE NEW LAWN AREA. CONTRACTOR SHALL PROVIDE HEAD-TO-HEAD COVERAGE. WORK TO BE DETERMINED IN THE FIELD BY INSTALLING CONTRACTOR.	11
12	NEW FULL DEPTH A.C. PAVEMENT	12

- CONSTRUCTION NOTES:
- SEE ARCHITECTURAL AND BLEACHER DRAWINGS FOR NEW BLEACHERS.
 - SEE DETAILS '3/C1.0' AND '4/C1.0' FOR EXPANSION AND CONTROL JOINTS.
 - FOR EDGE CONDITIONS, SEE DETAILS '2/C1.0', '5/C1.0' AND '6/C1.0'.

- GENERAL NOTES:
- ALL THE MOVABLE ITEMS THAT ARE CURRENTLY LOCATED WITHIN THE WORK AREA NEED TO BE RELOCATED DURING THE DEMOLITION AND CONSTRUCTION, AND PLACED BACK AT THE SAME LOCATION AFTER THE WORK IS COMPLETED.
 - CONTRACTOR SHALL ENSURE EXISTING IRRIGATION THAT FEEDS LANDSCAPE AREAS ADJACENT TO THE PROJECT WORK AREA REMAINS FULL OPERATIONAL THROUGHOUT DURATION OF THE PROJECT WHEN REQUIRED TO INTERRUPT EXISTING IRRIGATION OPERATIONS. CONTRACTOR SHALL BE RESPONSIBLE TO PROVIDE TEMPORARY WATER TO MAINTAIN ALL EXISTING LANDSCAPE AREAS IN HEALTHY CONDITION UNTIL IRRIGATION SYSTEM IS RESTORED.

NOTES:
SEE ELECTRICAL PLANS FOR ALL ELECTRICAL CONDUITS, VAULTS, BOXES, AND ELECTRICAL LINES.

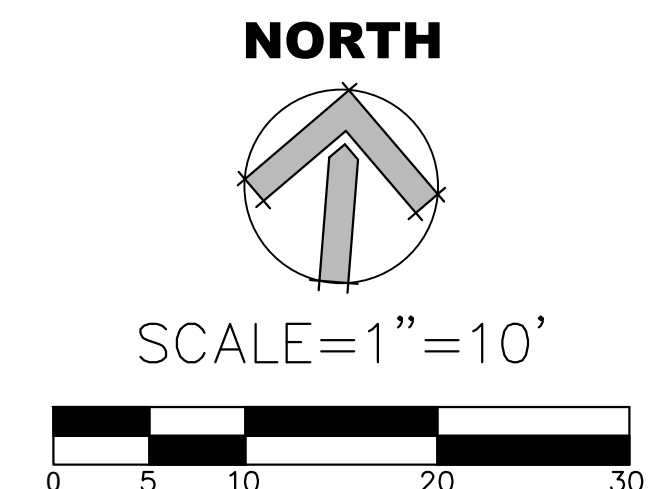

AGENCY REVIEW

IDENTIFICATION STAMP
DIV. OF THE STATE ARCHITECT
APP. 03-120480 INC.
REVIEWED FOR
SS ☒ FLS ☒ ACS ☒
DATE: 07/22/2020

LITTLE

DIVERSIFIED ARCHITECTURAL CONSULTING

1300 Dove Street, Suite 100
Newport Beach, CA, 92660
T: 949.698.1400

www.littleonline.com

This drawing and the design shown are the property of Little Diversified Architectural Consulting. The reproduction, copying or other use of this drawing without their written consent is prohibited and any infringement will be subject to legal action.

© Little 2020

CLIENT NAME


OXNARD UNION
HIGH SCHOOL
DISTRICT

PROJECT NAME


ADOLFO CAMARILLO HIGH SCHOOL
VISITOR BLEACHERS

4660 MISSION OAKS BLVD,
CAMARILLO, CA. 93012

CONSULTANT



SEAL



ISSUE FOR

DSA SUBMITTAL

ISSUE DATE

7/22/20

REVISIONS

NO.	REASON	DATE

PROJECT TEAM

PRINCIPAL IN CHARGE
BBC
PROJECT MANAGER
ML
DESIGN TEAM
AT
PROJECT NAME
ADOLFO CAMARILLO HIGH
SCHOOL
VISITOR BLEACHERS

PROJECT NO.

6121235309

SHEET TITLE

CONSTRUCTION PLAN

SHEET NUMBER

C3.0






NOTES:


SEE ELECTRICAL PLANS FOR ALL ELECTRICAL
CONDUITS, VAULTS, BOXES, AND ELECTRICAL LINES.

GENERAL NOTES:	
1.	ALL THE MOVABLE ITEMS THAT ARE CURRENTLY LOCATED WITHIN THE WORK AREA NEED TO BE RELOCATED DURING THE DEMOLITION AND CONSTRUCTION, AND PLACED BACK AT THE SAME LOCATION AFTER THE WORK IS COMPLETED.
2.	CONTRACTOR SHALL ENSURE EXISTING IRRIGATION THAT FEEDS LANDSCAPE AREAS ADJACENT TO THE PROJECT WORK AREA REMAINS FULL OPERATIONAL THROUGHOUT DURATION OF THE PROJECT. WHEN REQUIRED TO INTERRUPT EXISTING IRRIGATION OPERATIONS, CONTRACTOR SHALL BE RESPONSIBLE TO PROVIDE TEMPORARY WATER TO MAINTAIN ALL EXISTING LANDSCAPE AREAS IN HEALTHY CONDITION UNTIL IRRIGATION SYSTEM IS RESTORED.

EXISTING STORM DRAIN _____ (SD) _____
 EXISTING COMM. _____ (COM) _____
 EXISTING ELECTRICAL _____ (E) _____ (E) _____
 NEW ELECTRICAL _____ E _____
 NEW COMMUNICATIONS _____ C _____ C _____
 NOT IN CONTRACT N.I.C.

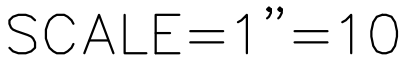
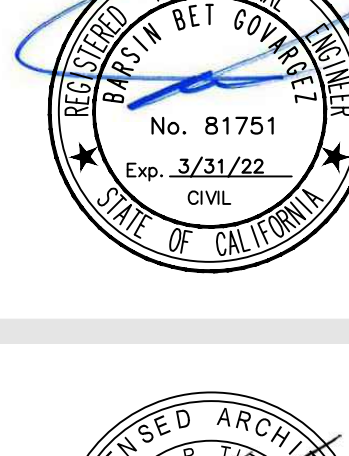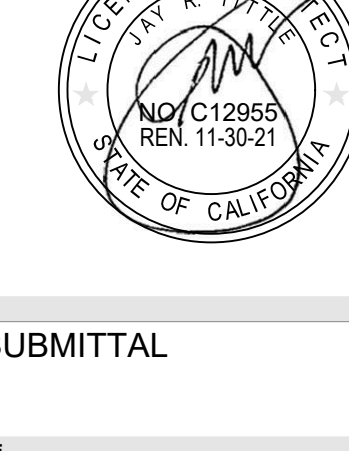
<div>IDENTIFICATION STAMP DIV. OF THE STATE ARCHITECT APP. 03-120480 INC. REVIEWED FOR SS <input checked="" type="checkbox"/> FLS <input type="checkbox"/> ACS <input type="checkbox"/> DATE: 07/22/2020</div>		
<div>LITTLE DIVERSIFIED ARCHITECTURAL CONSULTING</div>		
1300 Dove Street, Suite 100 Newport Beach, CA, 92660 T: 949.699.1400		
www.littleonline.com		
<i>This drawing and the design shown are the property of Little Diversified Architectural Consulting. The reproduction, copying or other use of this drawing without their written consent is prohibited and any infringement will be subject to legal action.</i>		
© Little 2020		
CLIENT NAME		
OXNARD UNION HIGH SCHOOL DISTRICT		
PROJECT NAME		
ADOLFO CAMARILLO HIGH SCHOOL VISITOR BLEACHERS 4660 MISSION OAKS BLVD, CAMARILLO, CA. 93012		
CONSULTANT		
		
SEAL		
		
ISSUE FOR		
DSA SUBMITTAL		
ISSUE DATE		
7/22/2020		
REVISIONS		
NO.	REASON	DATE
PROJECT TEAM		
PRINCIPAL IN CHARGE		
BBG		
PROJECT MANAGER		
ML		
DESIGN TEAM		
AT		
PROJECT NAME		
ADOLFO CAMARILLO HIGH SCHOOL VISITOR BLEACHERS		
PROJECT NO.		
6121235309		
SHEET TITLE		
CONSTRUCTION PLAN		
SHEET NUMBER		
C3.1		

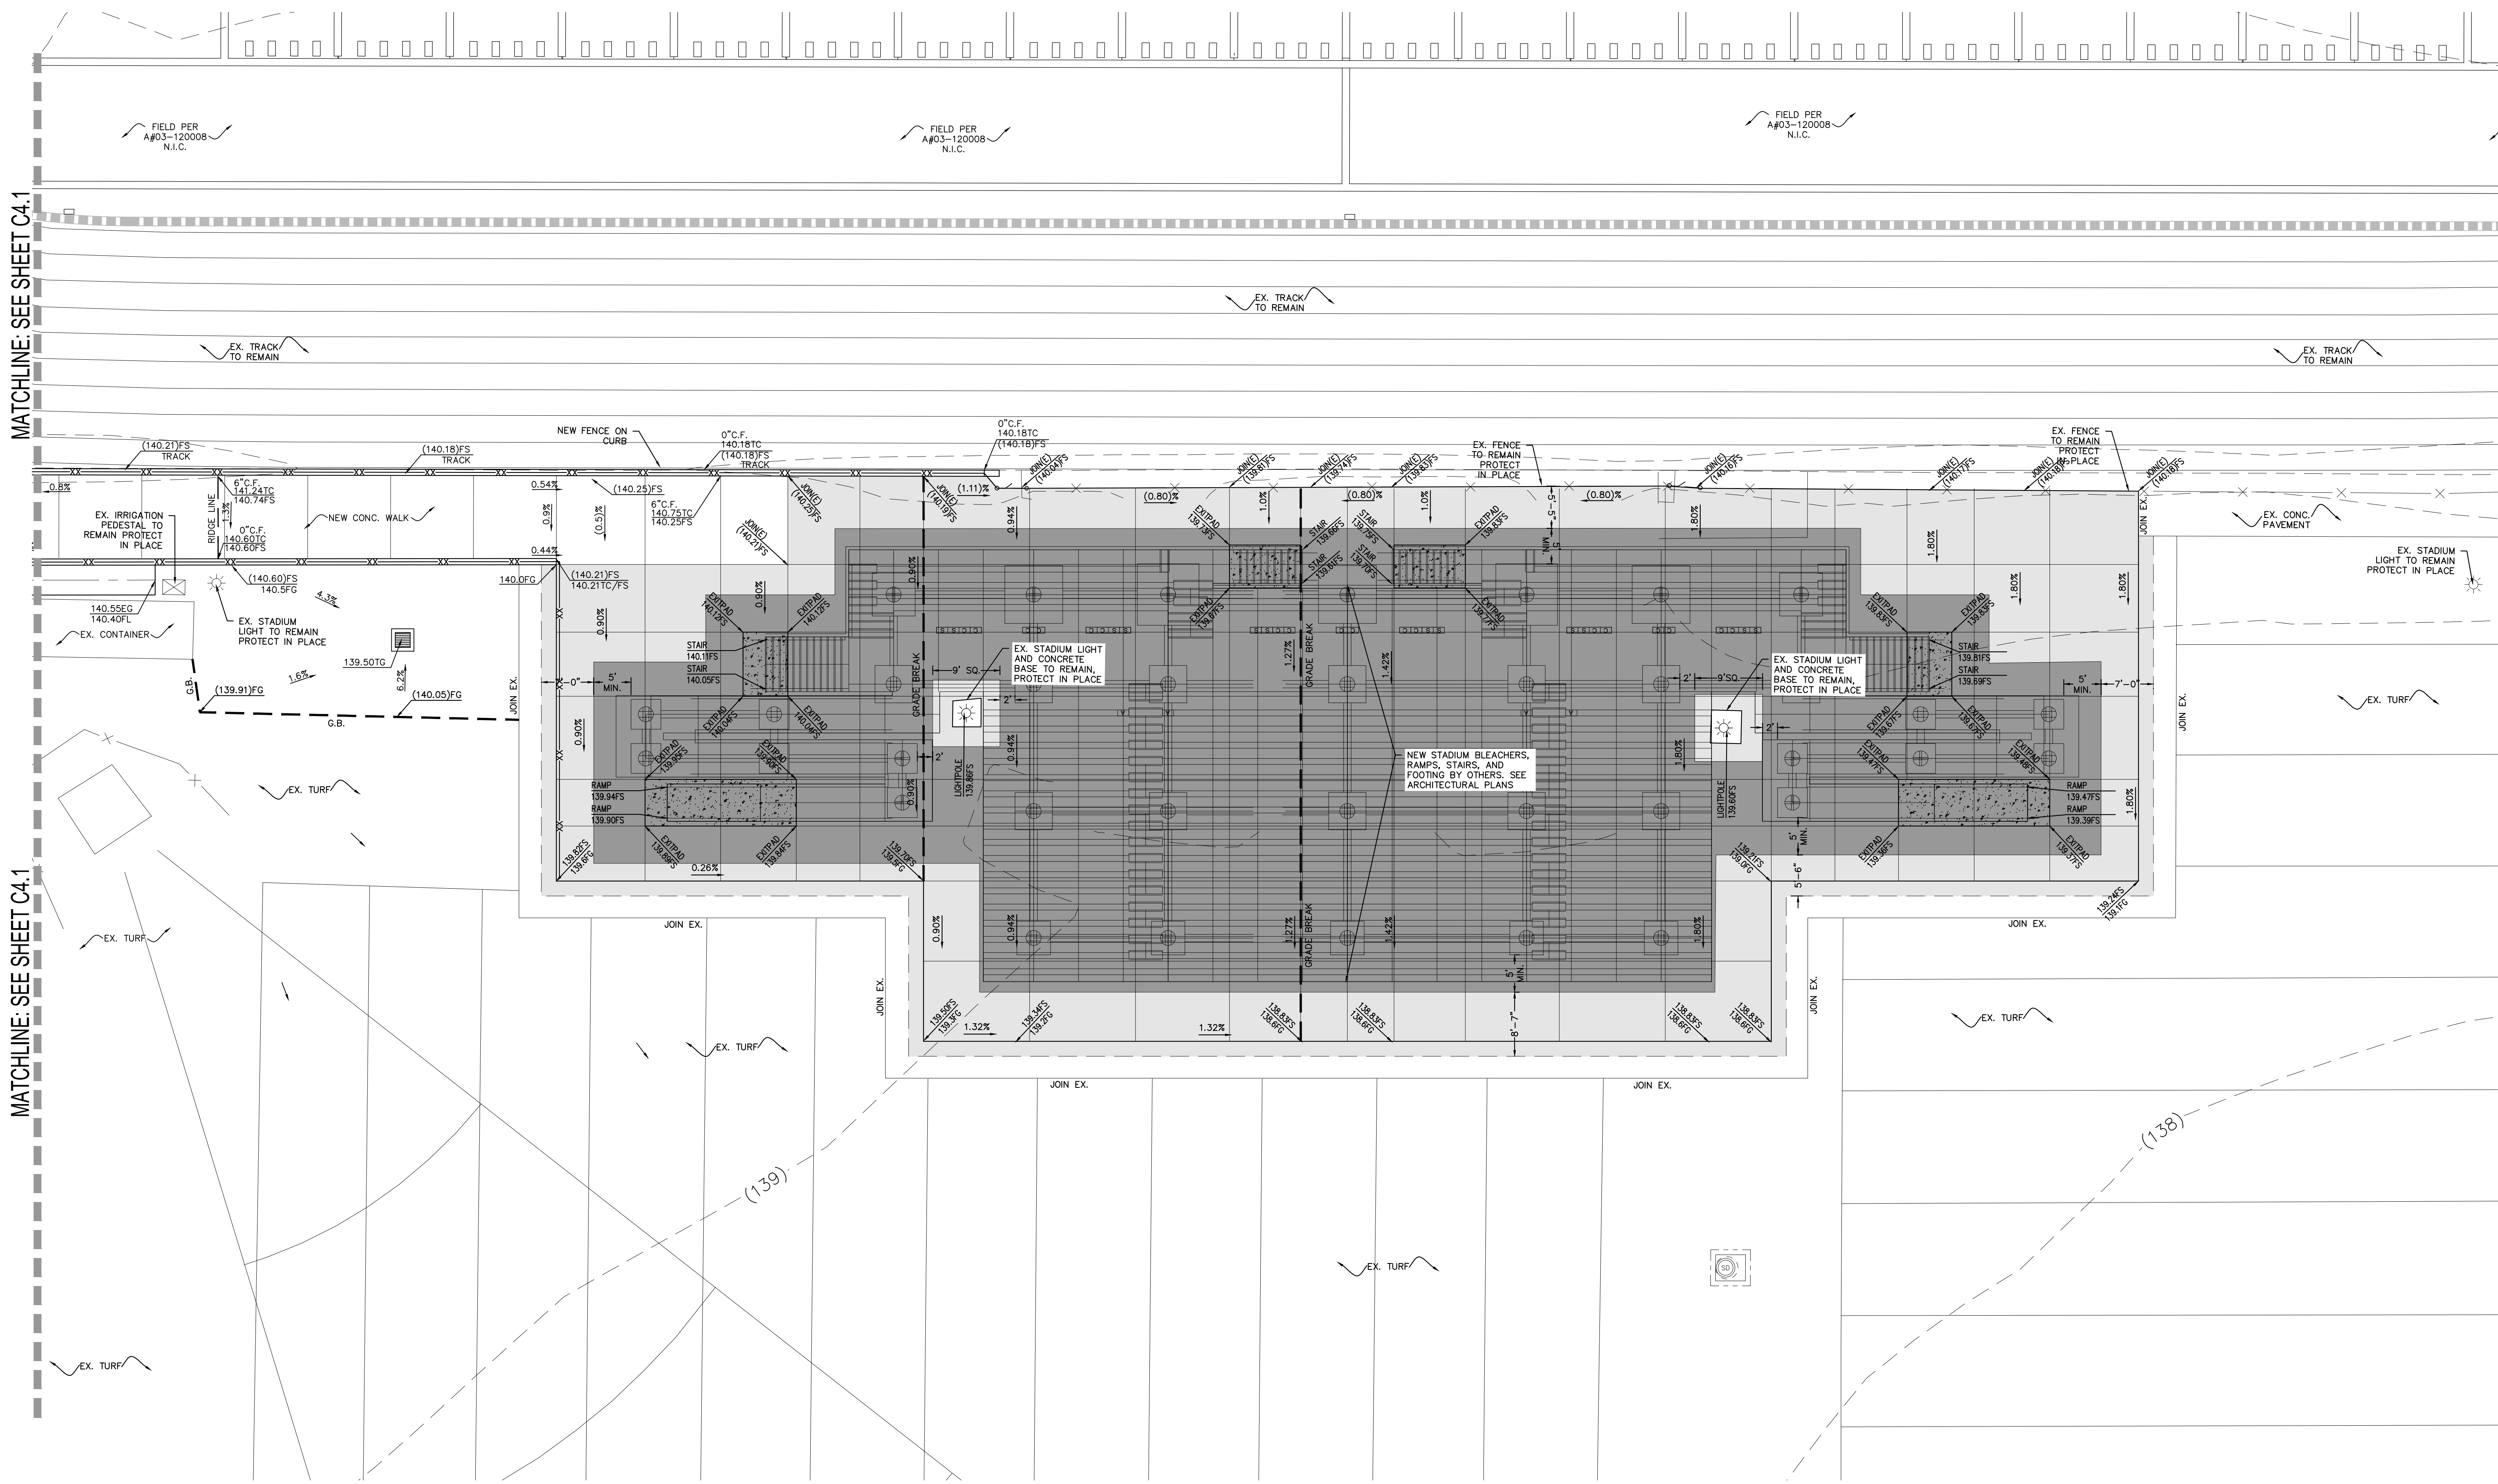

OVEREXCAVATION NOTE:

OVEREXCAVATION LIMITS - FOLLOW RECOMMENDATIONS OUTLINED IN SOILS REPORT AND LETTER FROM GEOTECHNICAL ENGINEER. PREPARED BY EARTH SYSTEMS PACIFIC. SEE EXCERPTS FROM SOILS REPORT AND LETTER FROM GEOTECHNICAL ENGINEER ON SHEET C4.1 FOR REFERENCE ONLY.

30' MINIMUM FOR PAD FOOTINGS. THE OVEREXCAVATION SHOULD EXTEND TO A MINIMUM OF (6) FEET OUTSIDE THE FOOTINGS EXCEPT WHERE NEW FOOTINGS WILL BE CLOSE TO EXISTING STADIUM LIGHTS. WHERE ADJACENT TO EXISTING STADIUM LIGHTS, OVEREXCAVATION MAY BE HALTED AT (2) FEET FROM THE EXISTING STADIUM LIGHT. THE RESULTING SURFACE SHALL THEN BE SCARIFIED AN ADDITIONAL 9" MOISTURE CONDITIONED AND RECOMPACTED.
EXTERIOR SLABS ON GRADE SHALL BE OVEREXCAVATED TO A MINIMUM DEPTH OF 18" MINIMUM. THE RESULTING SURFACE SHALL THEN BE SCARIFIED AN ADDITIONAL 9" MOISTURE CONDITIONED AND RECOMPACTED.

NORTH

SCALE=1"=10'



AGENCY REVIEW

IDENTIFICATION STAMP
DIV. OF THE STATE ARCHITECT
APP. 03-120480 INC.
REVIEWED FOR
SS ☒ FLS ☒ ACS ☒
DATE: 07/22/2020

LITTLE
DIVERSIFIED ARCHITECTURAL CONSULTING

1300 Dove Street, Suite 100
Newport Beach, CA, 92660
T: 949.698.1400

www.littleonline.com

This drawing and the design shown are the property of Little Diversified Architectural Consulting. The reproduction, copying or other use of this drawing without their written consent is prohibited and any infringement will be subject to legal action.

© Little 2020

CLIENT NAME

**OXNARD UNION
HIGH SCHOOL
DISTRICT**

PROJECT NAME

**ADOLFO CAMARILLO HIGH SCHOOL
VISITOR BLEACHERS**

**4660 MISSION OAKS BLVD,
CAMARILLO, CA. 93012**

CONSULTANT



SEAL



ISSUE FOR

DSA SUBMITTAL

ISSUE DATE

7/22/20

REVISIONS

NO.	REASON	DATE

PROJECT TEAM

PRINCIPAL IN CHARGE

BBG

PROJECT MANAGER

ML

DESIGN TEAM

AT

PROJECT NAME

**ADOLFO CAMARILLO HIGH
SCHOOL
VISITOR BLEACHERS**

PROJECT NO.



6121235309

SHEET TITLE

GRADING PLAN

SHEET NUMBER


C4.0

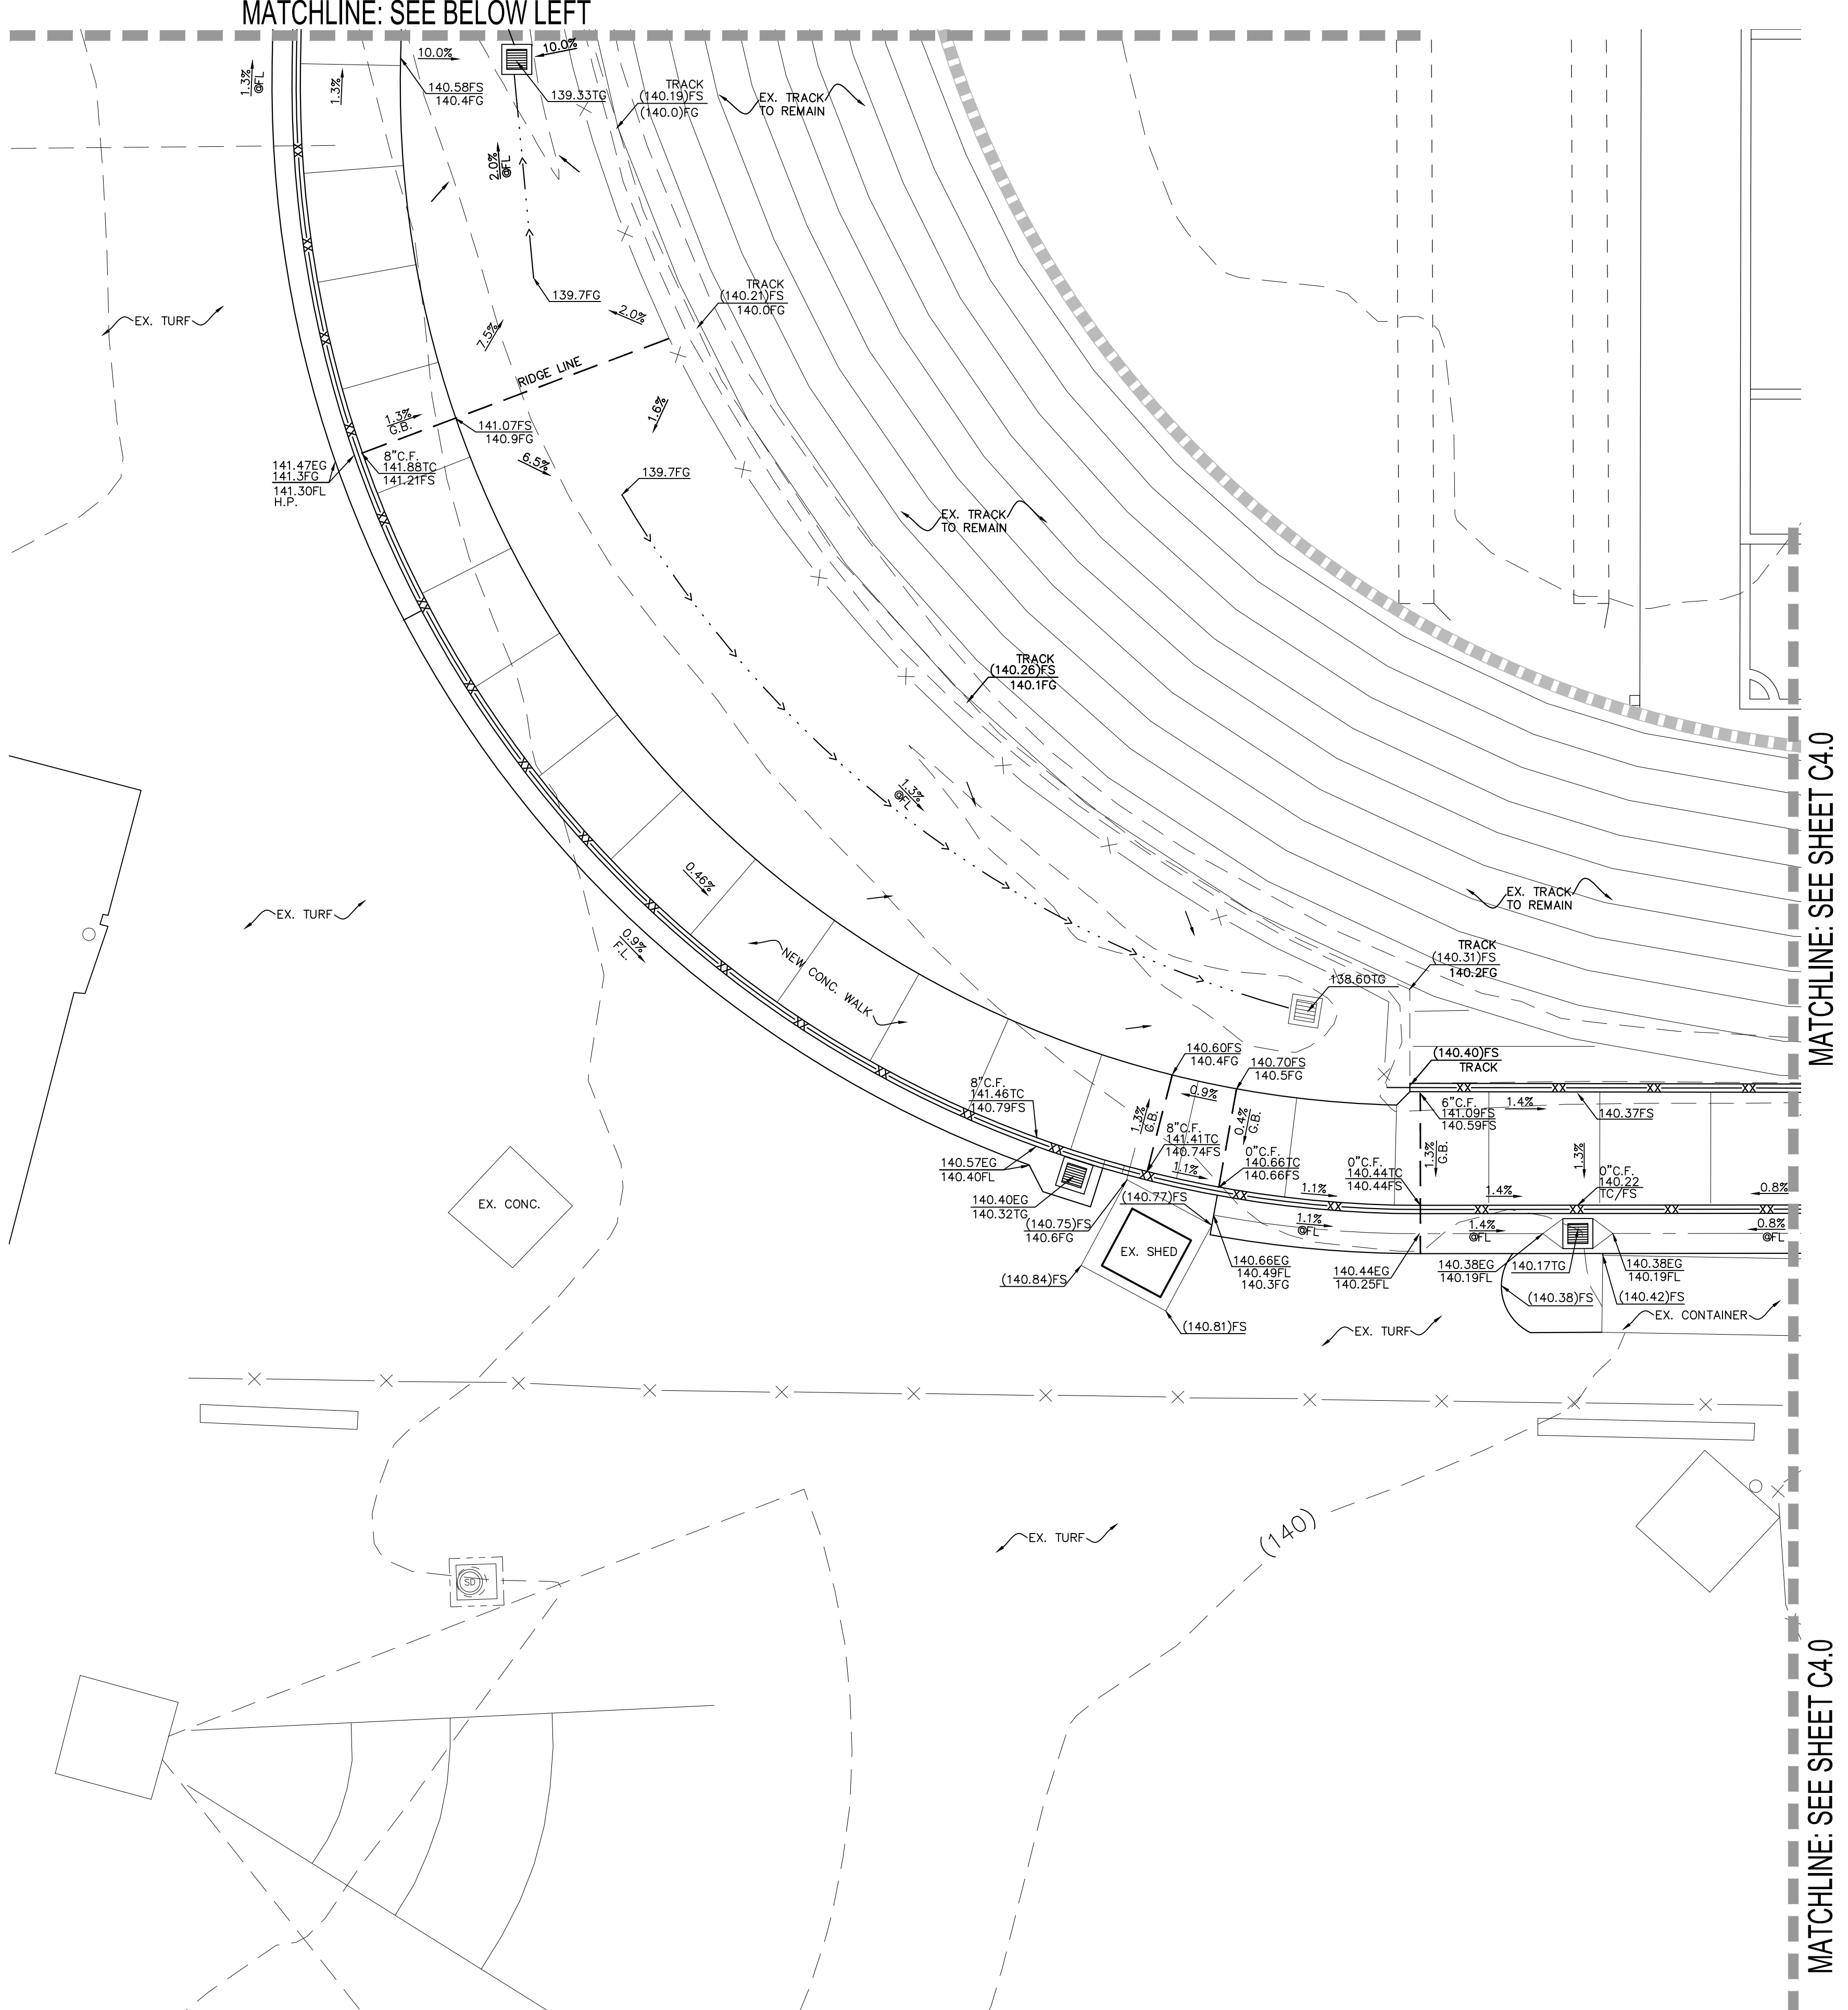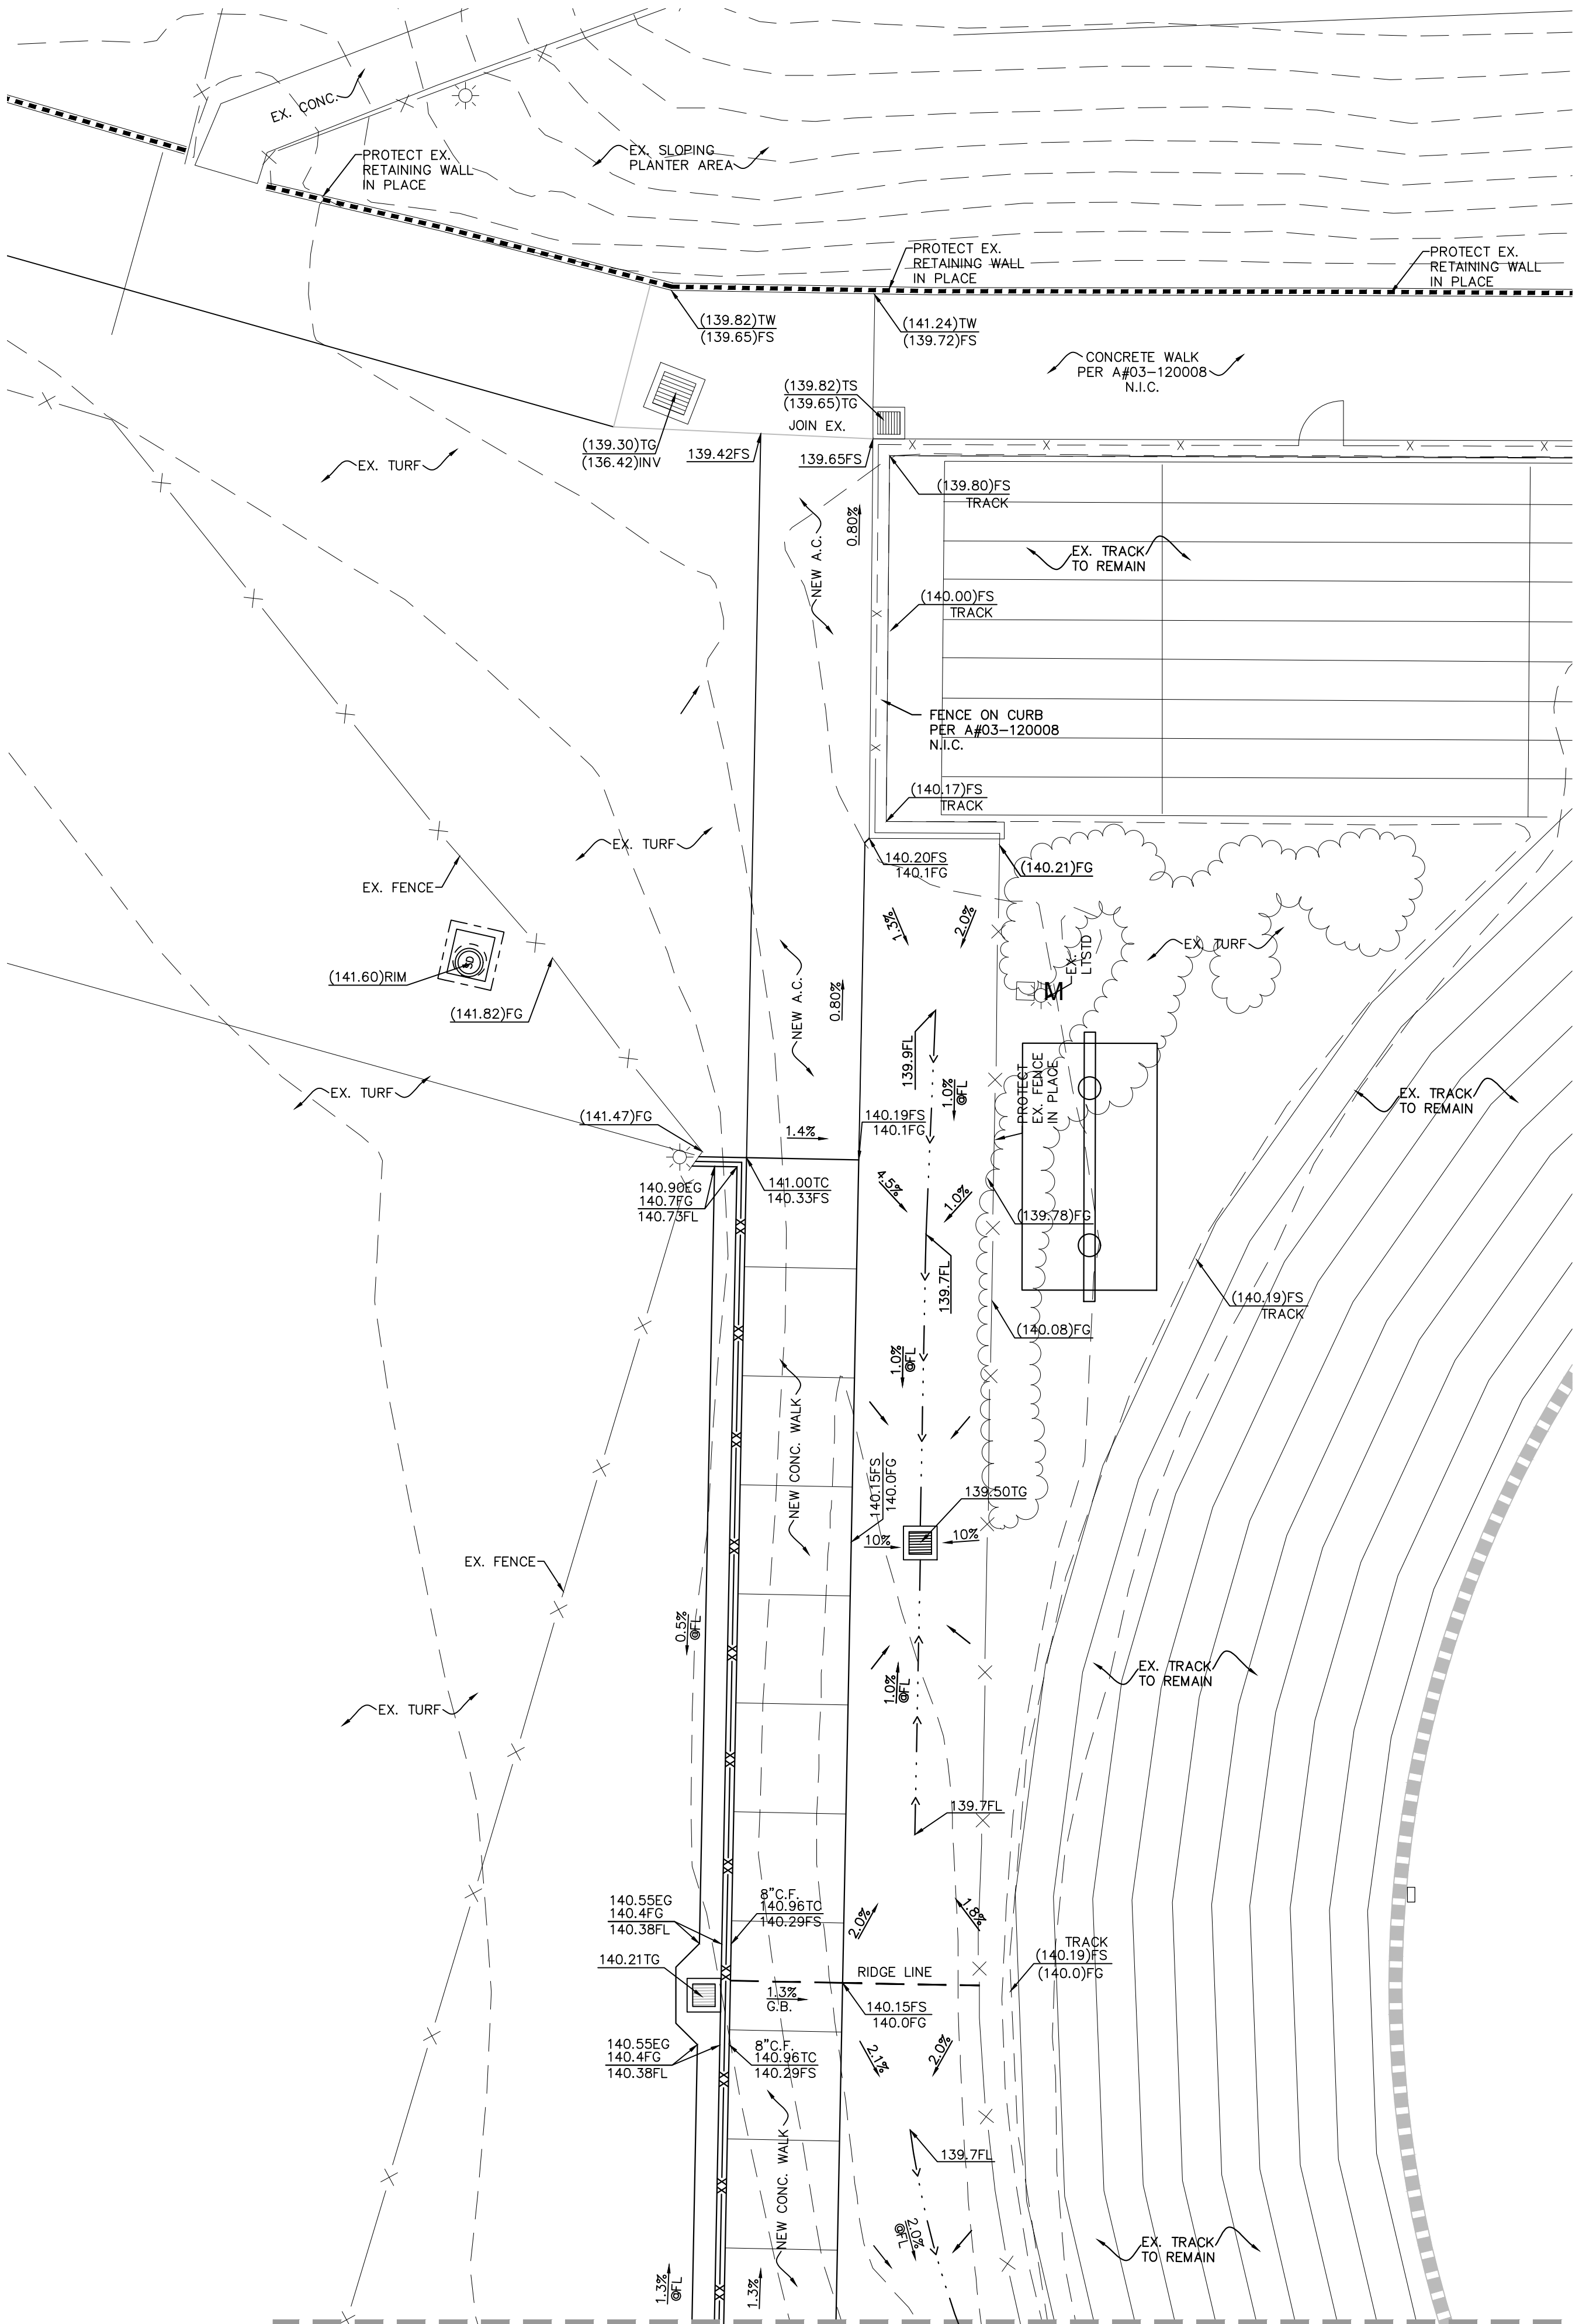

OVEREXCAVATION NOTE:

OVEREXCAVATION LIMITS - FOLLOW RECOMMENDATIONS OUTLINED IN SOILS REPORT AND LETTER FROM GEOTECHNICAL ENGINEER, PREPARED BY EARTH SYSTEMS PACIFIC. SEE EXCERPTS FROM SOILS REPORT AND LETTER FROM GEOTECHNICAL ENGINEER ON SHEET C1.1 FOR REFERENCE ONLY.

30" MINIMUM FOR PAD FOOTINGS - THE OVEREXCAVATION SHOULD EXTEND TO A MINIMUM OF 10' BEYOND THE FOOTINGS EXCEPT WHERE NEW FOOTINGS WILL BE CLOSE TO EXISTING STADIUM LIGHTS. WHERE ADJACENT TO EXISTING STADIUM LIGHTS, OVEREXCAVATION MAY BE HALTED AT 6' FEET FROM THE EXISTING STADIUM LIGHT. THE RESULTING SURFACE SHALL THEN BE SCARIFIED AN ADDITIONAL 6" MOISTURE CONDITIONED AND RECOMPACTED.
EXTERIOR SLABS ON GRADE SHALL BE OVEREXCAVATED TO A MINIMUM DEPTH OF 18" MINIMUM. THE RESULTING SURFACE SHALL THEN BE SCARIFIED AN ADDITIONAL 6", MOISTURE CONDITIONED AND RECOMPACTED.

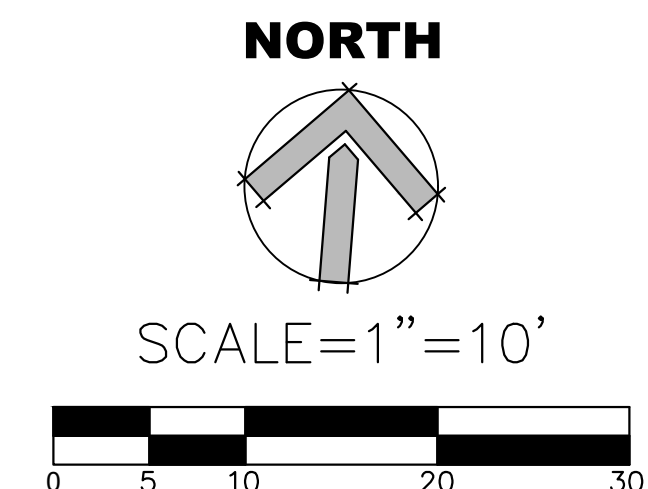

AGENCY REVIEW

IDENTIFICATION STAMP

DIV. OF THE STATE ARCHITECT

APP. 03-120480 INC.

REVIEWED FOR

SS ☐ FLS ☐ ACS ☐

DATE: 07/22/2020

LITTLE

DIVERSIFIED ARCHITECTURAL CONSULTING

1300 Dove Street, Suite 100
Newport Beach, CA, 92660
T: 949.698.1400

www.littleonline.com

This drawing and the design shown are the property of Little Diversified Architectural Consulting. The reproduction, copying or other use of this drawing without their written consent is prohibited and any infringement will be subject to legal action.

© Little 2020

CLIENT NAME

OXNARD UNION HIGH SCHOOL DISTRICT

PROJECT NAME

ADOLFO CAMARILLO HIGH SCHOOL VISITOR BLEACHERS

4660 MISSION OAKS BLVD,
CAMARILLO, CA. 93012

CONSULTANT

REGISTERED PROFESSIONAL ENGINEER

NO. 81751

EXP. 3/31/22

CIVIL

STATE OF CALIFORNIA

SEAL

LICENSED ARCHITECT

NO. C12955

REN. 11-30-21

STATE OF CALIFORNIA

ISSUE FOR

DSA SUBMITTAL

ISSUE DATE

7/22/20

REVISIONS

NO.	REASON	DATE

PROJECT TEAM

PRINCIPAL IN CHARGE
BBO

PROJECT MANAGER
ML

DESIGN TEAM
AT

PROJECT NAME
ADOLFO CAMARILLO HIGH SCHOOL VISITOR BLEACHERS

PROJECT NO.


6121235309

SHEET TITLE


GRADING PLAN

SHEET NUMBER

C4.1


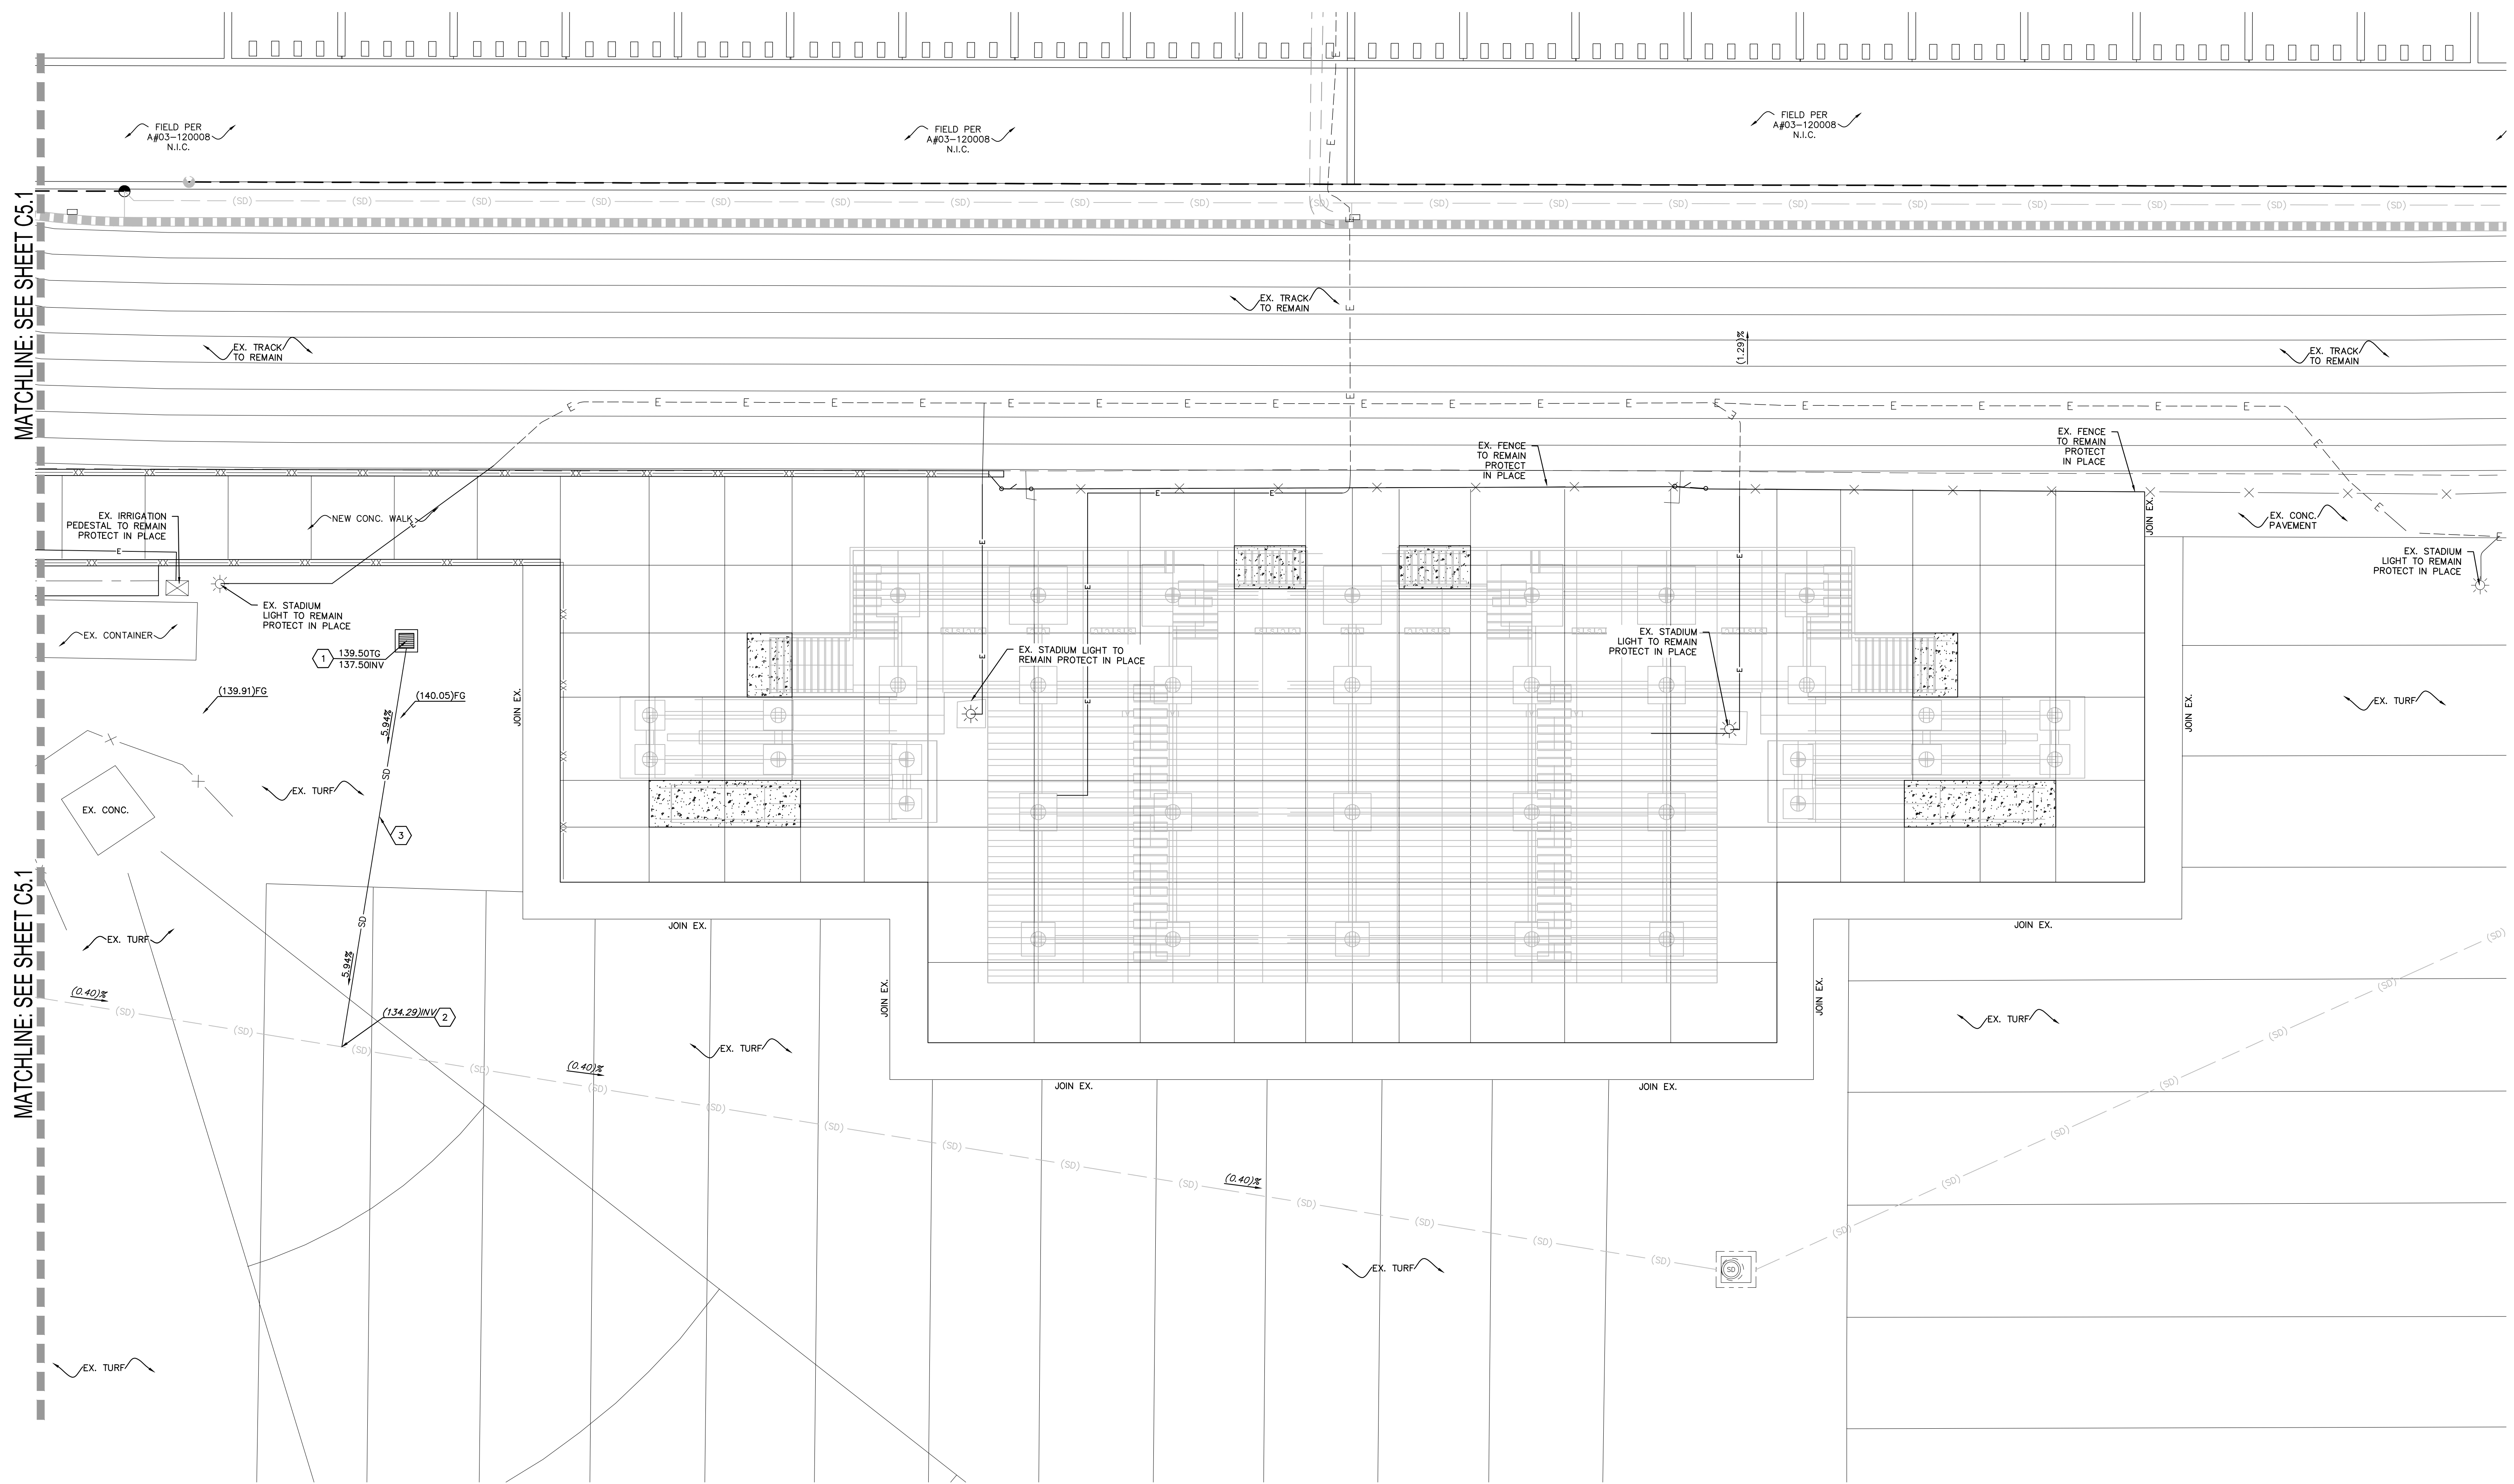


1	NEW 24" SO. CO. DRAIN INLET, BROOKS SAGA HTG GLASS, STEEL, SLOPED-DOWN, VANDUPL-PROOF, 14" INLET, 14" INLET OR APPROVED EQUAL, WITH INLET OR OUTLET AS REQUIRED, INSTALLED FORWARD GRATED INLET STYLE CATCH BASIN INLET FILTER, MODULE NUMBER RFG-24P.	7 1/2"
2	JOIN TO EXISTING STORM DRAIN PIPE, CONTRACTOR TO FURNISH AND INSTALL ALL NECESSARY FITTINGS TO MAKE THE CONNECTION.	
3	NEW 18" HOPE STORM DRAIN PIPE, ADS 4-11 WITH WATER TIGHT JOINTS OR APPROVED EQUAL.	
4	NEW 18" HOPE STORM DRAIN PIPE, ADS 4-12 WITH WATER TIGHT JOINTS OR APPROVED EQUAL.	
5	ADJUST EXISTING DRAIN INLET / CATCH BASIN TO GRADE AS NEEDED, PROTECT-IN-PLACE EXISTING INVERT AND ASSOCIATED PIPING.	

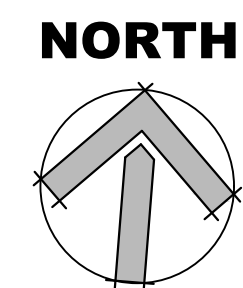


SCALE=1"=10'



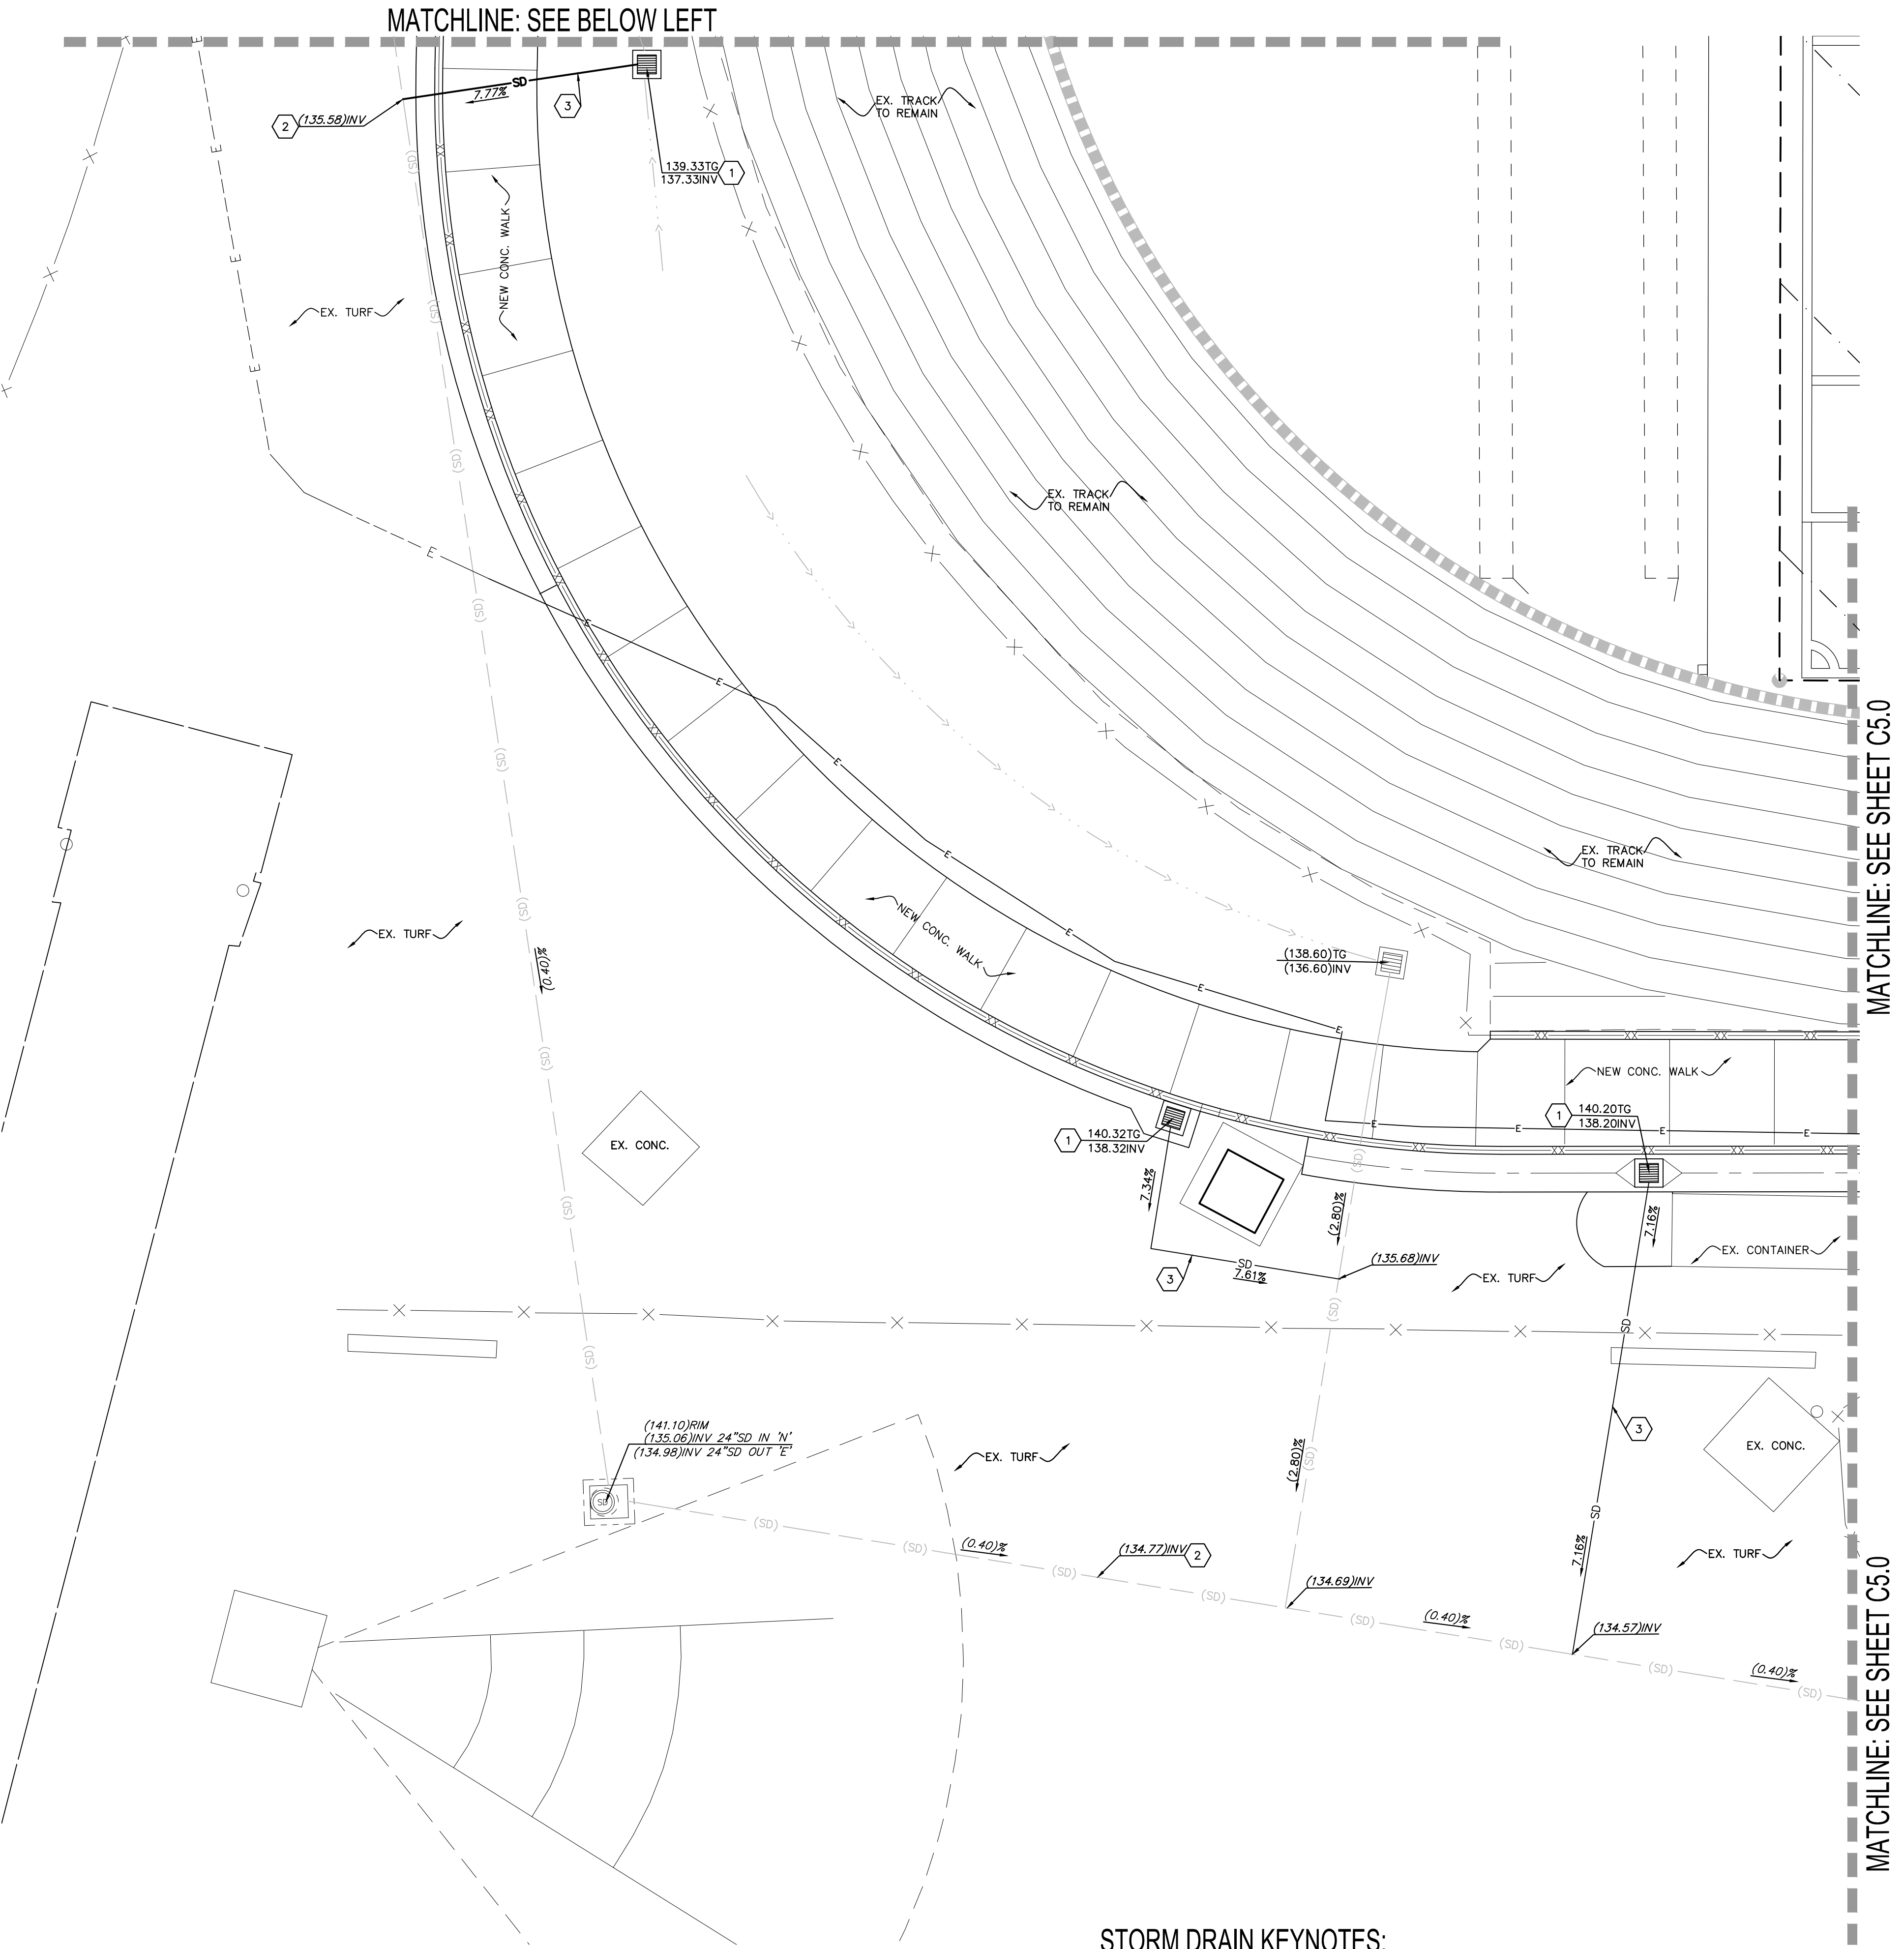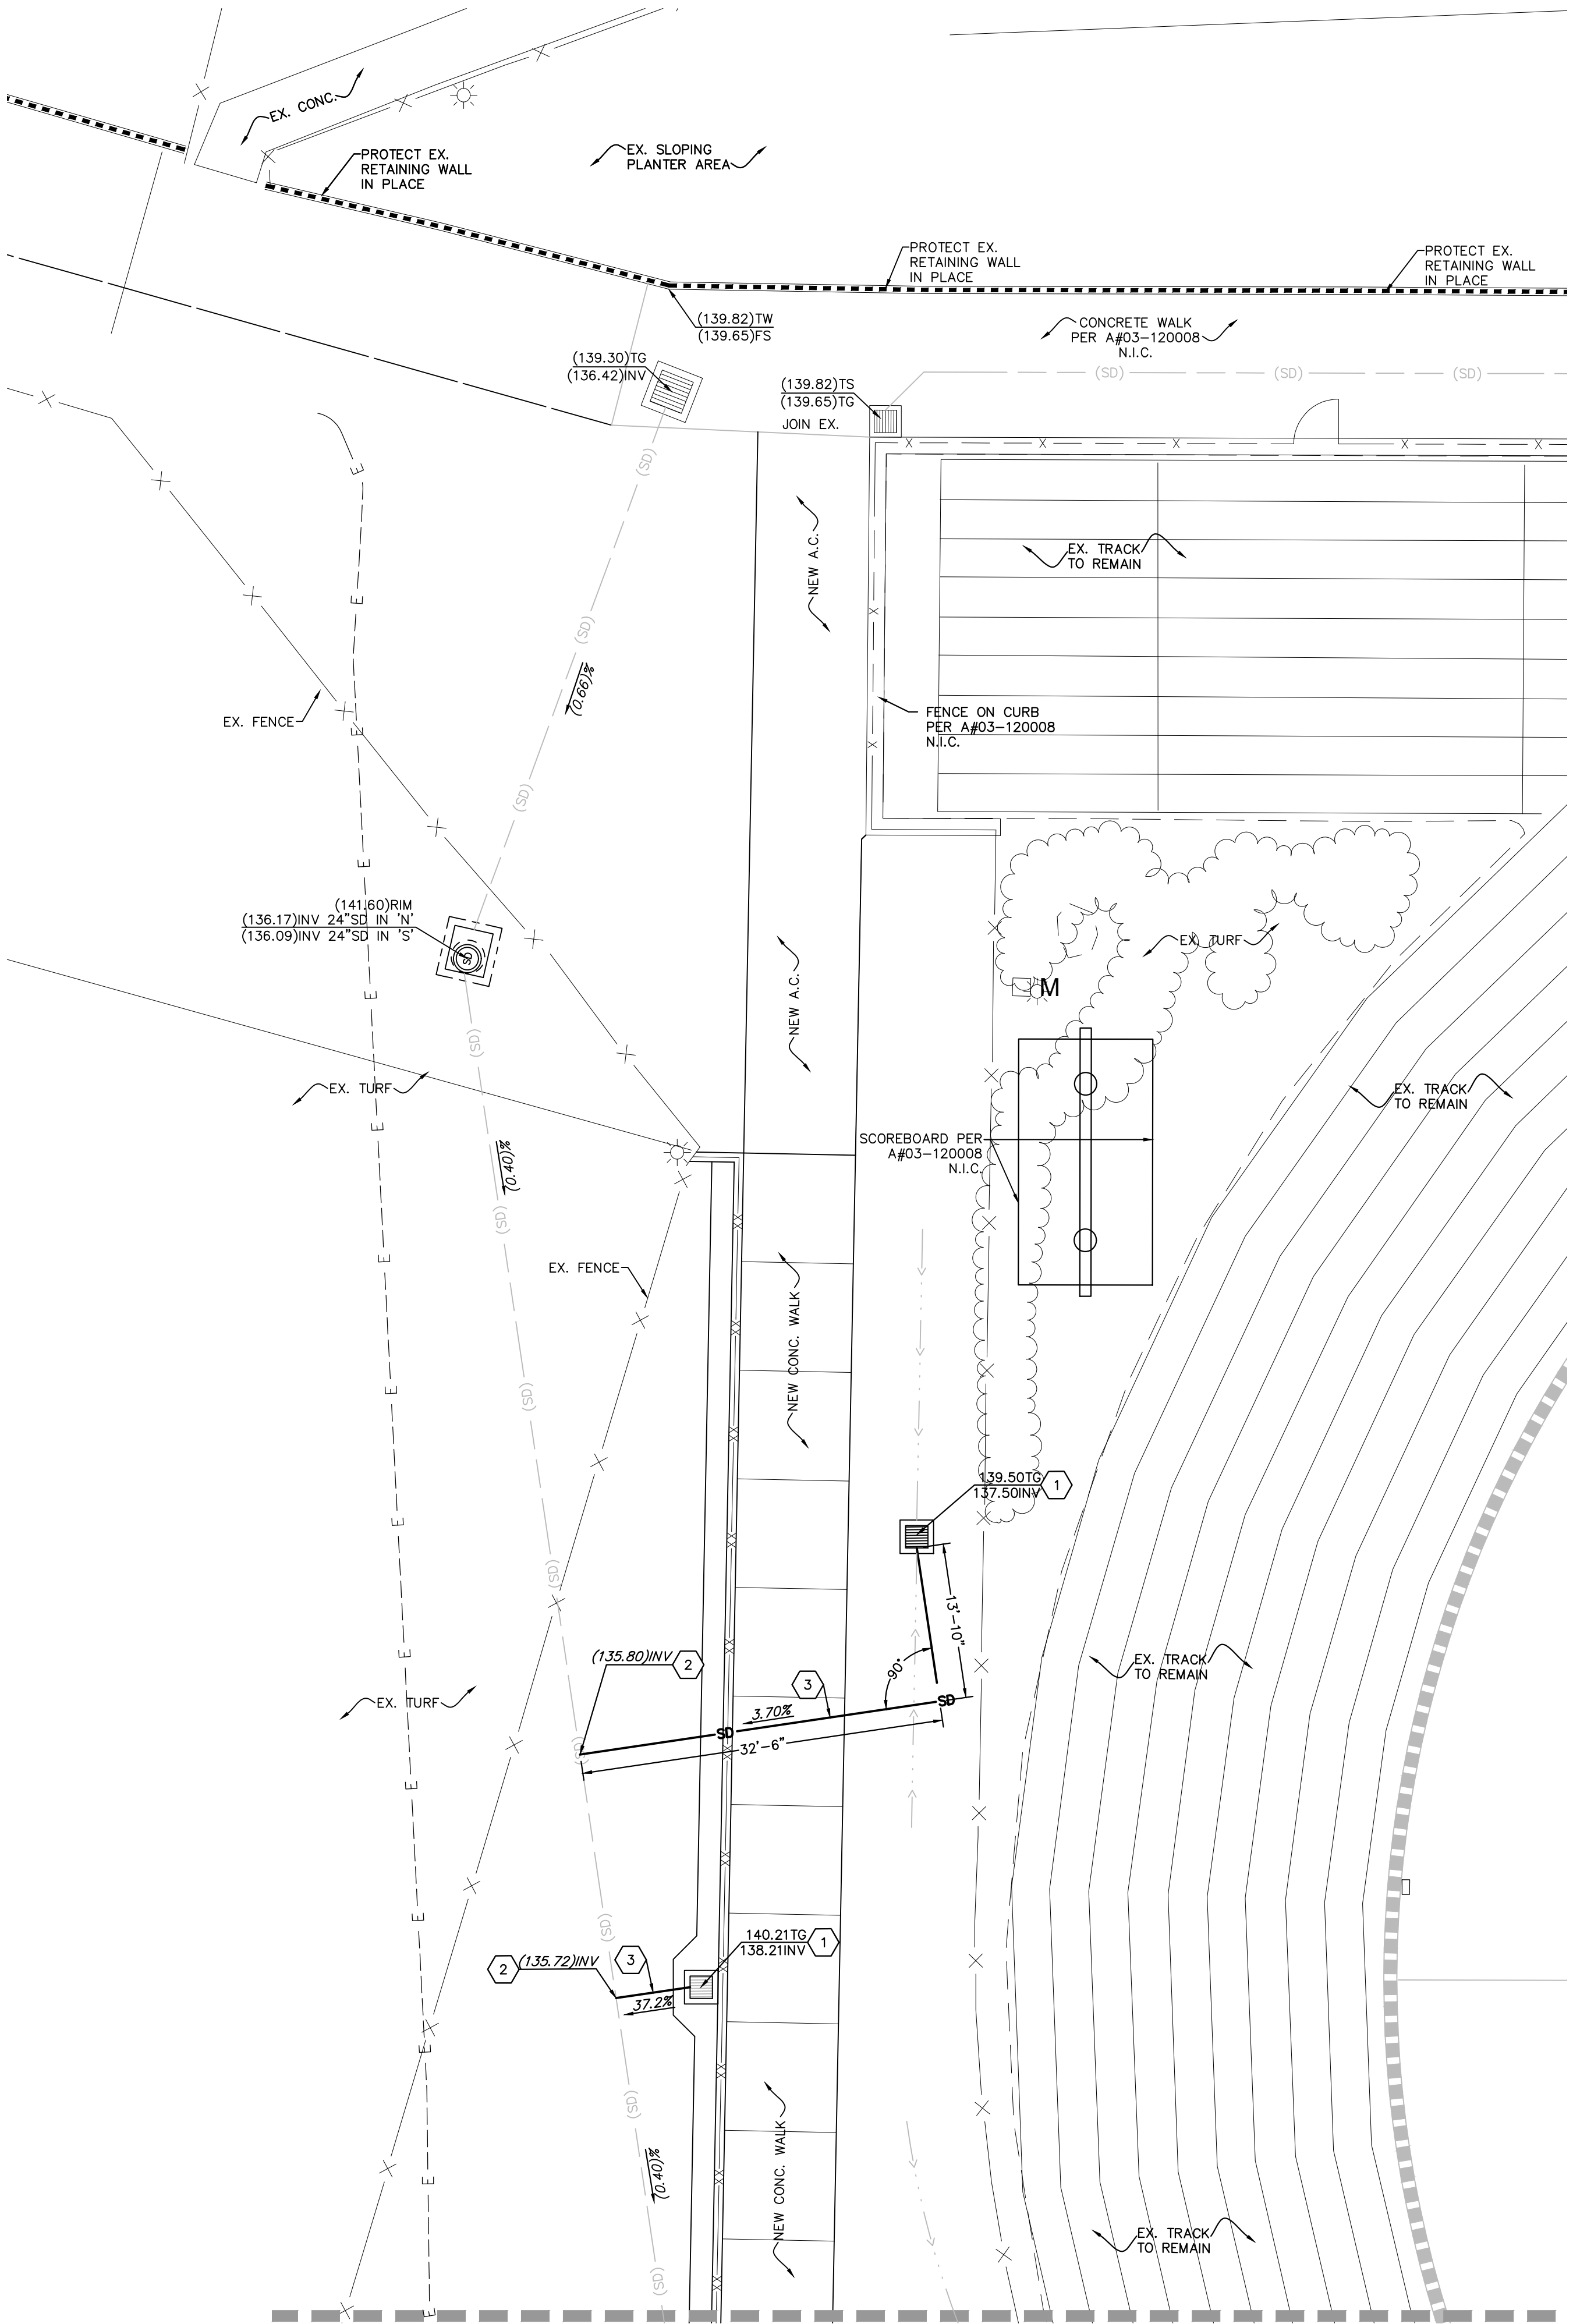

STORM DRAIN KEYNOTES:

1	NEW 24" SQ. CONC. DRAIN INLET, BROOKS 2424 WITH GLASS STEEL, SCREWED-DOWN, VANDAL-PROOF, H-10 RATED, ADA GRATE OR APPROVED EQUAL, WITH INLET OR OUTLET AS REQUIRED, INSTALL FLOW-AND-GRADED INLET STYLE CATCH BASIN INSERT FILTER, MODULE NUMBER FGP-24F.	1
2	JOIN TO EXISTING STORM DRAIN PIPE, CONTRACTOR TO FURNISH AND INSTALL ALL NECESSARY FITTINGS TO MAKE THE CONNECTION.	
3	NEW 8" HDPE STORM DRAIN PIPE, ADS N-12 WITH WATER-TIGHT JOINTS OR APPROVED EQUAL.	
4	NEW 10" HDPE STORM DRAIN PIPE, ADS N-12 WITH WATER-TIGHT JOINTS OR APPROVED EQUAL.	
5	ADJUST EXISTING DRAIN INLET / CATCH BASIN TO GRADE AS NEEDED, PROTECT-IN-PLACE EXISTING INVERT AND ASSOCIATED PIPING.	

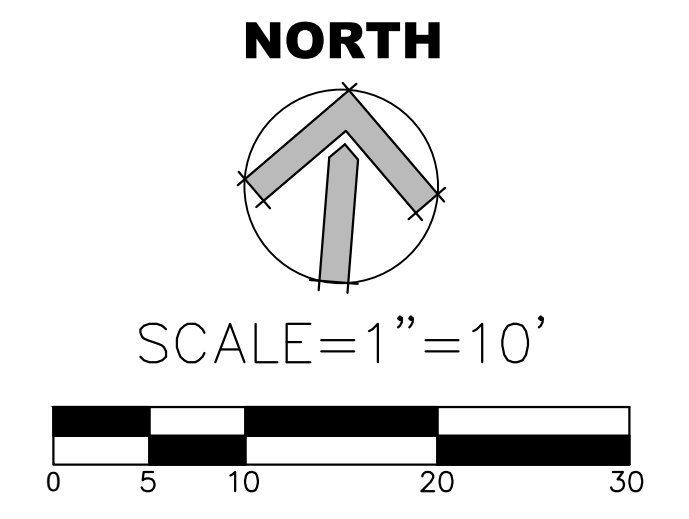

AGENCY REVIEW

IDENTIFICATION STAMP

DIV. OF THE STATE ARCHITECT

APP. 03-120480 INC.

REVIEWED FOR

SS ☒ FLS ☒ ACS ☒

DATE: 07/22/2020

LITTLE

DIVERSIFIED ARCHITECTURAL CONSULTING

1300 Dove Street, Suite 100

Newport Beach, CA, 92660

T: 949.698.1400

www.littleonline.com

This drawing and the design shown are the property of Little Diversified Architectural Consulting. The reproduction, copying or other use of this drawing without their written consent is prohibited and any infringement will be subject to legal action.

© Little 2020

CLIENT NAME

OXNARD UNION HIGH SCHOOL DISTRICT

PROJECT NAME

ADOLFO CAMARILLO HIGH SCHOOL VISITOR BLEACHERS

4660 MISSION OAKS BLVD., CAMARILLO, CA. 93012

CONSULTANT

REGISTERED PROFESSIONAL ENGINEER

NO. 81751

EXP. 3/31/22

CIVIL

STATE OF CALIFORNIA

SEAL

REGISTERED ARCHITECT

NO. C12955

REN. 11-30-21

STATE OF CALIFORNIA

ISSUE FOR

DSA SUBMITTAL

ISSUE DATE

7/22/20

NO.	REASON	DATE

PROJECT TEAM

PRINCIPAL IN CHARGE

BBC

PROJECT MANAGER

ML

DESIGN TEAM

AT

PROJECT NAME

ADOLFO CAMARILLO HIGH SCHOOL VISITOR BLEACHERS

PROJECT NO.


6121235309

SHEET TITLE

STORM DRAIN PLAN

SHEET NUMBER

C5.1

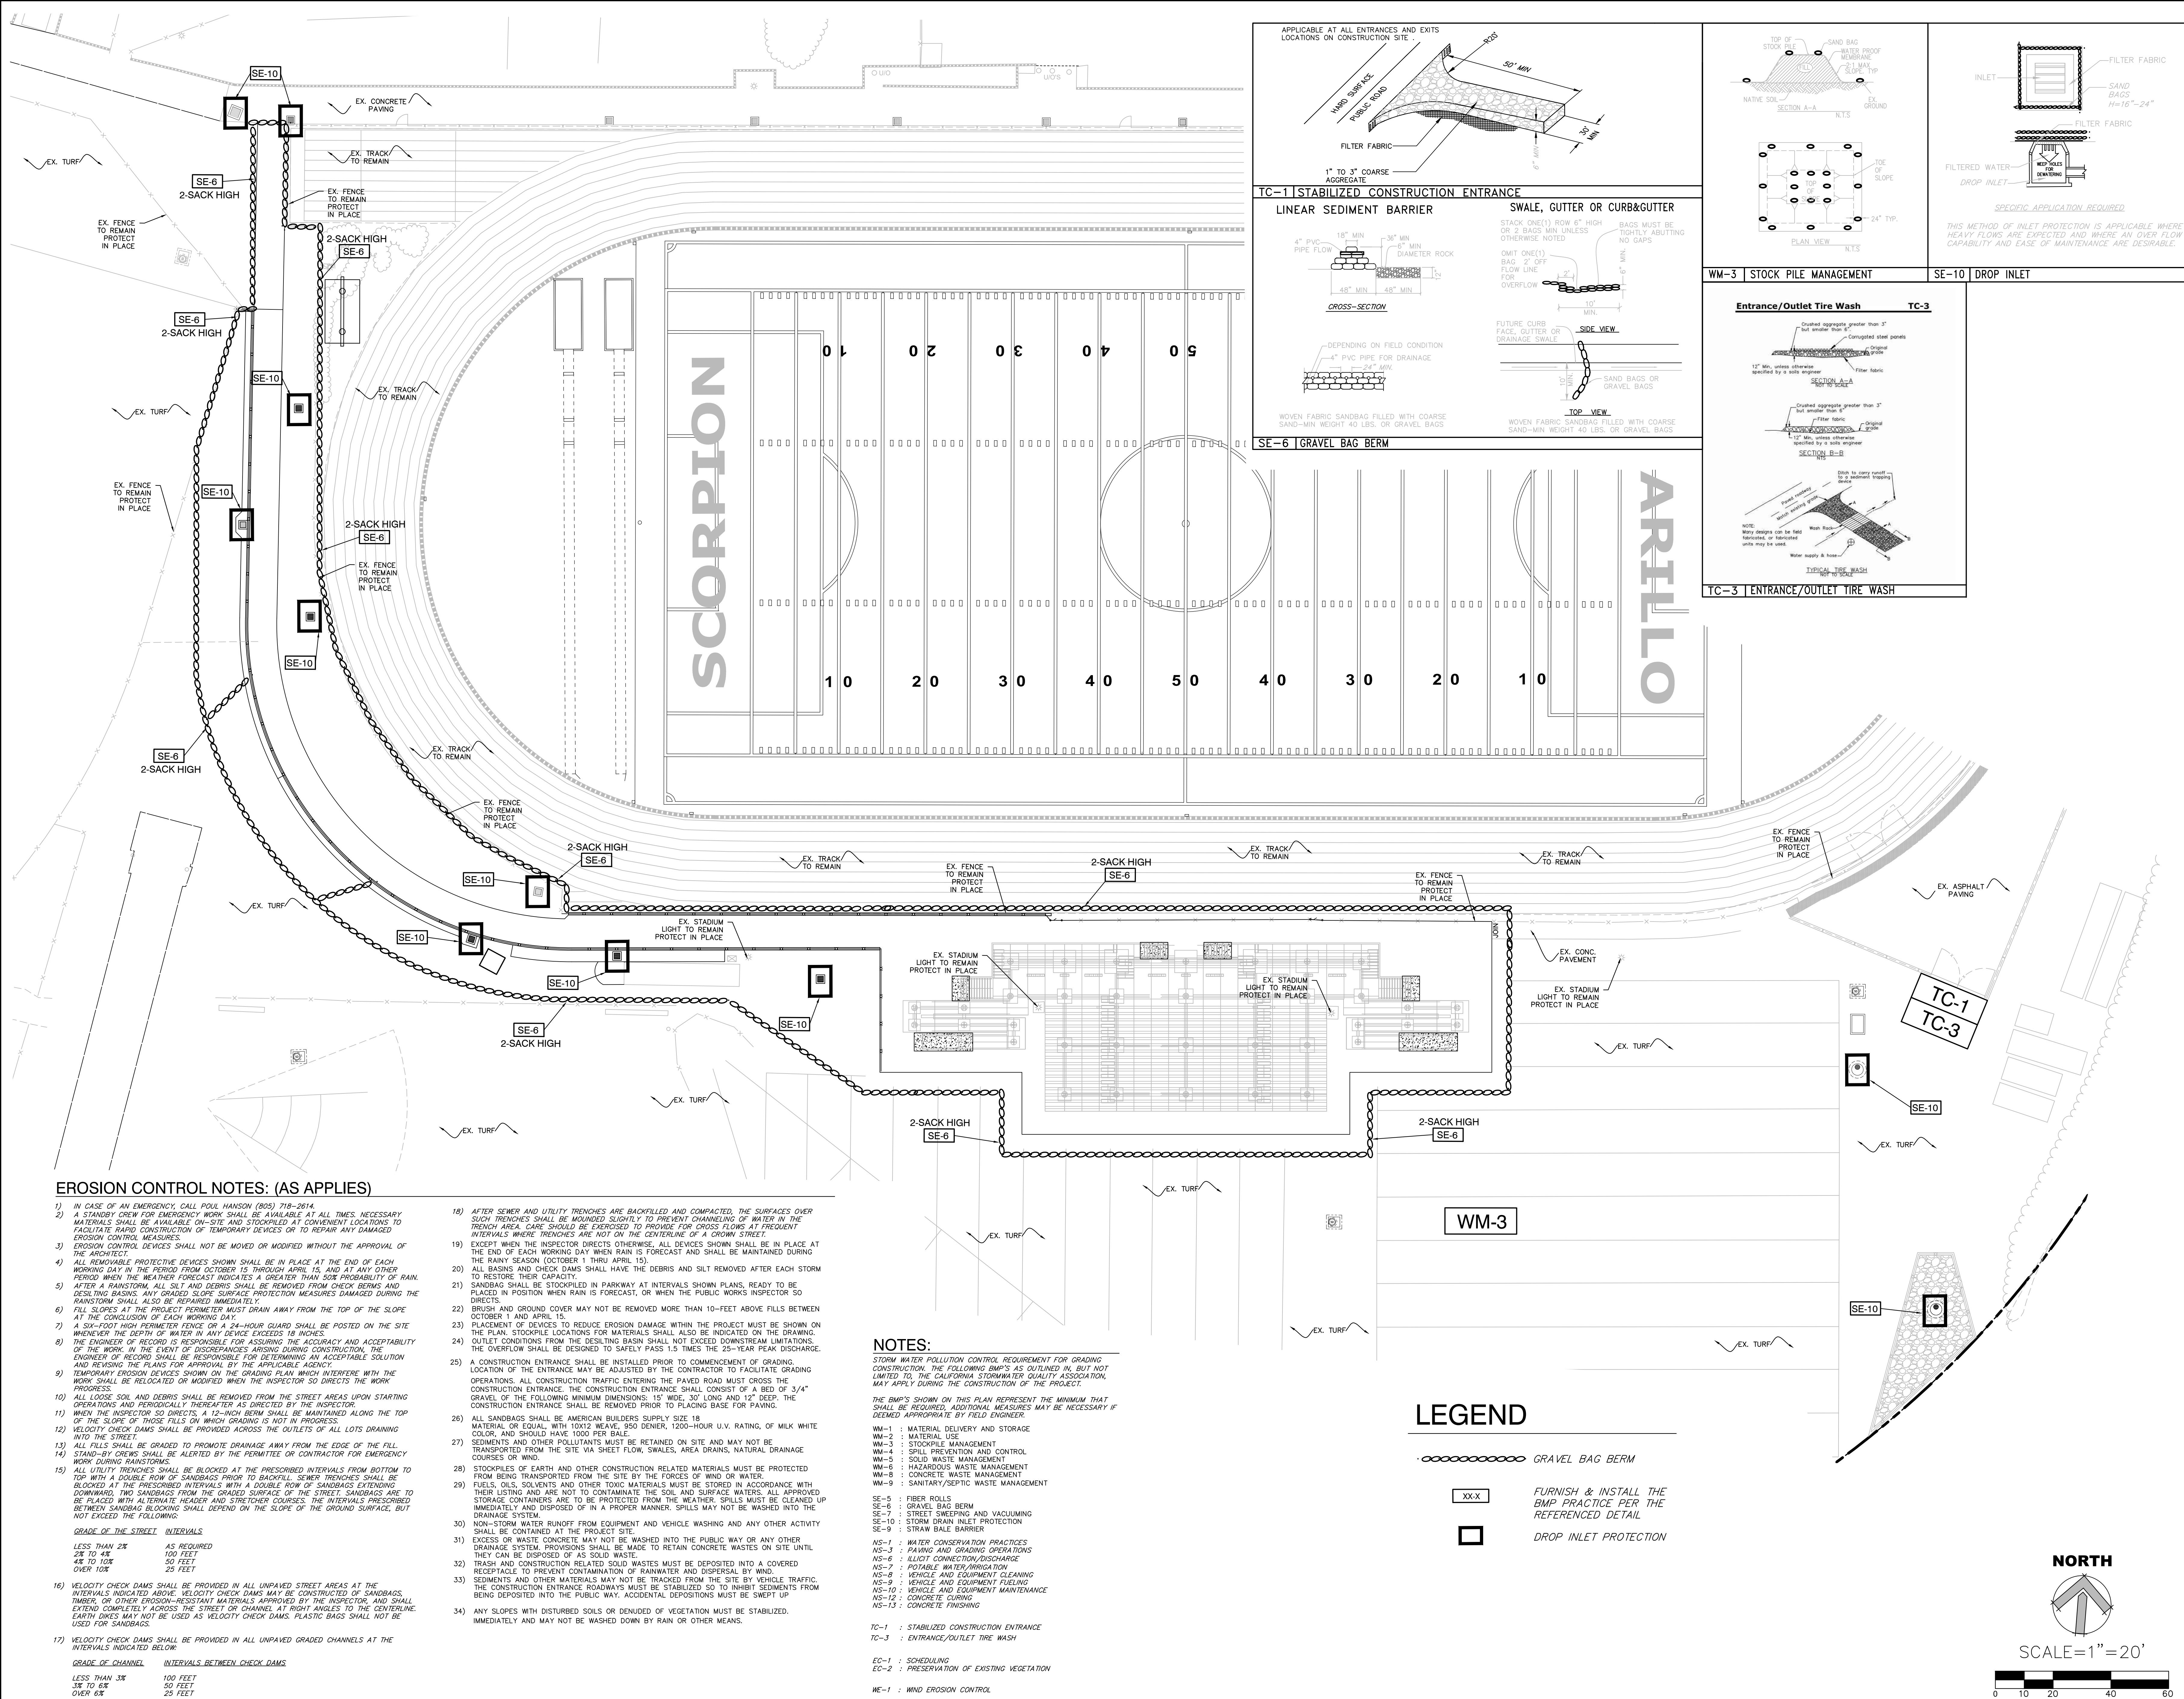

EROSION CONTROL NOTES: (AS APPLIES)

- 1) IN CASE OF AN EMERGENCY, CALL POUL HANSON (805) 718-2614.
- 2) A STANDBY CREW FOR EMERGENCY WORK SHALL BE AVAILABLE AT ALL TIMES. NECESSARY MATERIALS SHALL BE AVAILABLE ON-SITE AND STOCKPILED AT CONVENIENT LOCATIONS TO FACILITATE RAPID CONSTRUCTION OF TEMPORARY DEVICES OR TO REPAIR ANY DAMAGED EROSION CONTROL MEASURES.
- 3) EROSION CONTROL DEVICES SHALL NOT BE MOVED OR MODIFIED WITHOUT THE APPROVAL OF THE ARCHITECT.
- 4) ALL REMOVABLE PROTECTIVE DEVICES SHOWN SHALL BE IN PLACE AT THE END OF EACH WORKING DAY IN THE PERIOD FROM OCTOBER 15 THROUGH APRIL 15, AND AT ANY OTHER PERIOD WHEN THE WEATHER FORECAST INDICATES A GREATER THAN 50% PROBABILITY OF RAIN.
- 5) AFTER A RAINSTORM, ALL SILT AND DEBRIS SHALL BE REMOVED FROM CHECK DAMS AND DESILTING BASINS. ANY GRADED SLOPE SURFACE PROTECTION MEASURES DAMAGED DURING THE RAINSTORM SHALL ALSO BE REPAIRED IMMEDIATELY.
- 6) FILL SLOPES AT THE PROJECT PERIMETER MUST DRAIN AWAY FROM THE TOP OF THE SLOPE AT THE CONCLUSION OF EACH WORKING DAY.
- 7) A SIX-FOOT HIGH PERIMETER FENCE OR A 24-HOUR GUARD SHALL BE POSTED ON THE SITE WHENEVER THE DEPTH OF WATER IN ANY DEVICE EXCEEDS 18 INCHES.
- 8) THE ENGINEER OF RECORD IS RESPONSIBLE FOR ASSURING THE ACCURACY AND ACCEPTABILITY OF THE WORK. IN THE EVENT OF DISCREPANCIES ARISING DURING CONSTRUCTION, THE ENGINEER OF RECORD SHALL BE RESPONSIBLE FOR DETERMINING AN ACCEPTABLE SOLUTION AND REVISING THE PLANS FOR APPROVAL BY THE APPLICABLE AGENCY.
- 9) TEMPORARY EROSION DEVICES SHOWN ON THE GRADING PLAN WHICH INTERFERE WITH THE WORK SHALL BE RELOCATED OR MODIFIED WHEN THE INSPECTOR SO DIRECTS THE WORK PROGRESS.
- 10) ALL LOOSE SOIL AND DEBRIS SHALL BE REMOVED FROM THE STREET AREAS UPON STARTING OPERATIONS AND PERIODICALLY THEREAFTER AS DIRECTED BY THE INSPECTOR.
- 11) WHEN THE INSPECTOR SO DIRECTS, A 12-INCH BERM SHALL BE MAINTAINED ALONG THE TOP OF THE SLOPE OF THOSE FILLS ON WHICH GRADING IS NOT IN PROGRESS.
- 12) VELOCITY CHECK DAMS SHALL BE PROVIDED ACROSS THE OUTLETS OF ALL LOTS DRAINING INTO THE STREET.
- 13) ALL FILLS SHALL BE GRADED TO PROMOTE DRAINAGE AWAY FROM THE EDGE OF THE FILL.
- 14) STAND-BY CREWS SHALL BE ALERTED BY THE PERMITTEE OR CONTRACTOR FOR EMERGENCY WORK DURING RAINSTORMS.
- 15) ALL UTILITY TRENCHES SHALL BE BLOCKED AT THE PRESCRIBED INTERVALS FROM BOTTOM TO TOP WITH A DOUBLE ROW OF SANDBAGS PRIOR TO BACKFILL. SEWER TRENCHES SHALL BE BLOCKED AT THE PRESCRIBED INTERVALS WITH A DOUBLE ROW OF SANDBAGS EXTENDING DOWNWARD. TWO SANDBAGS FROM THE GRADED SURFACE OF THE STREET. SANDBAGS ARE TO BE PLACED WITH ALTERNATE HEADER AND STRETCHER COURSES. THE INTERVALS PRESCRIBED BETWEEN SANDBAG BLOCKING SHALL DEPEND ON THE SLOPE OF THE GROUND SURFACE, BUT NOT EXCEED THE FOLLOWING:

GRADE OF THE STREET	INTERVALS
LESS THAN 2%	AS REQUIRED
2% TO 4%	100 FEET
4% TO 10%	50 FEET
OVER 10%	25 FEET
- 16) VELOCITY CHECK DAMS SHALL BE PROVIDED IN ALL UNPAVED STREET AREAS AT THE INTERVALS INDICATED ABOVE. VELOCITY CHECK DAMS MAY BE CONSTRUCTED OF SANDBAGS, TIMBER, OR OTHER EROSION-RESISTANT MATERIALS APPROVED BY THE INSPECTOR, AND SHALL EXTEND COMPLETELY ACROSS THE STREET OR CHANNEL AT RIGHT ANGLES TO THE CENTERLINE. EARTH DAMS MAY NOT BE USED AS VELOCITY CHECK DAMS. PLASTIC BAGS SHALL NOT BE USED FOR SANDBAGS.
- 17) VELOCITY CHECK DAMS SHALL BE PROVIDED IN ALL UNPAVED GRADED CHANNELS AT THE INTERVALS INDICATED BELOW:

GRADE OF CHANNEL	INTERVALS BETWEEN CHECK DAMS
LESS THAN 3%	100 FEET
3% TO 6%	50 FEET
OVER 6%	25 FEET
- 18) AFTER SEWER AND UTILITY TRENCHES ARE BACKFILLED AND COMPACTED, THE SURFACES OVER SUCH TRENCHES SHALL BE MOUNDING SUFFICIENT TO PREVENT CHANNELING OF WATER IN THE TRENCH AREA. CARE SHOULD BE EXERCISED TO PROVIDE FOR CROSS FLOWS AT FREQUENT INTERVALS WHERE TRENCHES ARE NOT ON THE CENTERLINE OF A CROWN STREET.
- 19) EXCEPT WHEN THE INSPECTOR DIRECTS OTHERWISE, ALL DEVICES SHOWN SHALL BE IN PLACE AT THE END OF EACH WORKING DAY WHEN RAIN IS FORECAST AND SHALL BE MAINTAINED DURING THE RAINY SEASON (OCTOBER 1 THRU APRIL 15).
- 20) ALL BASINS AND CHECK DAMS SHALL HAVE THE DEBRIS AND SILT REMOVED AFTER EACH STORM TO RESTORE THEIR CAPACITY.
- 21) SANDBAGS SHALL BE STOCKPILED IN PARKWAY AT INTERVALS SHOWN PLANS, READY TO BE PLACED IN POSITION WHEN RAIN IS FORECAST, OR WHEN THE PUBLIC WORKS INSPECTOR SO DIRECTS.
- 22) BRUSH AND GROUND COVER MAY NOT BE REMOVED MORE THAN 10-FEET ABOVE FILLS BETWEEN OCTOBER 1 AND APRIL 15.
- 23) PLACEMENT OF DEVICES TO REDUCE EROSION DAMAGE WITHIN THE PROJECT MUST BE SHOWN ON THE PLAN. STOCKPILE LOCATIONS FOR MATERIALS SHALL ALSO BE INDICATED ON THE DRAWING.
- 24) OUTLET CONDITIONS FROM THE DESILTING BASIN SHALL NOT EXCEED DOWNSTREAM LIMITATIONS. THE OVERFLOW SHALL BE DESIGNED TO SAFELY PASS 1.5 TIMES THE 25-YEAR PEAK DISCHARGE.
- 25) A CONSTRUCTION ENTRANCE SHALL BE INSTALLED PRIOR TO COMMENCEMENT OF GRADING. LOCATION OF THE ENTRANCE MAY BE ADJUSTED BY THE CONTRACTOR TO FACILITATE GRADING OPERATIONS. ALL CONSTRUCTION TRAFFIC ENTERING THE PAVED ROAD MUST CROSS THE CONSTRUCTION ENTRANCE. THE CONSTRUCTION ENTRANCE SHALL CONSIST OF A BED OF 3/4" GRAVEL OF THE FOLLOWING MINIMUM DIMENSIONS: 15' WIDE, 30' LONG AND 12" DEEP. THE CONSTRUCTION ENTRANCE SHALL BE REMOVED PRIOR TO PLACING BASE FOR PAVING.
- 26) ALL SANDBAGS SHALL BE AMERICAN BUILDERS SUPPLY SIZE 18 MATERIAL OR EQUAL, WITH 10X12 WEAVE, 950 DENIER, 1200-HOUR U.V. RATING, OF MILK WHITE COLOR, AND SHOULD HAVE 1000 PER BALE.
- 27) SEDIMENTS AND OTHER POLLUTANTS MUST BE RETAINED ON SITE AND MAY NOT BE TRANSPORTED FROM THE SITE VIA SHEET FLOW, SWALES, AREA DRAINS, NATURAL DRAINAGE COURSES OR WIND.
- 28) STOCKPILES OF EARTH AND OTHER CONSTRUCTION RELATED MATERIALS MUST BE PROTECTED FROM BEING TRANSPORTED FROM THE SITE BY THE FORCES OF WIND OR WATER.
- 29) FUELS, OILS, SOLVENTS AND OTHER TOXIC MATERIALS MUST BE STORED IN ACCORDANCE WITH THEIR LISTING AND ARE NOT TO CONTAMINATE THE SOIL AND SURFACE WATERS. ALL APPROVED STORAGE CONTAINERS ARE TO BE PROTECTED FROM THE WEATHER. SPILLS MUST BE CLEANED UP IMMEDIATELY AND DISPOSED OF IN A PROPER MANNER. SPILLS MAY NOT BE WASHED INTO THE DRAINAGE SYSTEM.
- 30) NON-STORM WATER RUNOFF FROM EQUIPMENT AND VEHICLE WASHING AND ANY OTHER ACTIVITY SHALL BE CONTAINED AT THE PROJECT SITE.
- 31) EXCESS OR WASTE CONCRETE MAY NOT BE WASHED INTO THE PUBLIC WAY OR ANY OTHER DRAINAGE SYSTEM. PROVISIONS SHALL BE MADE TO RETAIN CONCRETE WASTES ON SITE UNTIL THEY CAN BE DISPOSED OF AS SOLID WASTE.
- 32) TRASH AND CONSTRUCTION RELATED SOLID WASTES MUST BE DEPOSITED INTO A COVERED RECEPTACLE TO PREVENT CONTAMINATION OF RAINWATER AND DISPERSAL BY WIND.
- 33) SEDIMENTS AND OTHER MATERIALS MAY NOT BE TRACKED FROM THE SITE BY VEHICLE TRAFFIC. THE CONSTRUCTION ENTRANCE ROADWAYS MUST BE STABILIZED SO TO INHIBIT SEDIMENTS FROM BEING DEPOSITED INTO THE PUBLIC WAY. ACCIDENTAL DEPOSITIONS MUST BE SWEEP UP.
- 34) ANY SLOPES WITH DISTURBED SOILS OR DENuded OF VEGETATION MUST BE STABILIZED. IMMEDIATELY AND MAY NOT BE WASHED DOWN BY RAIN OR OTHER MEANS.

NOTES:

STORM WATER POLLUTION CONTROL REQUIREMENT FOR GRADING CONSTRUCTION. THE FOLLOWING BMP'S AS OUTLINED IN, BUT NOT LIMITED TO, THE CALIFORNIA STORMWATER QUALITY ASSOCIATION, MAY APPLY DURING THE CONSTRUCTION OF THE PROJECT.

THE BMP'S SHOWN ON THIS PLAN REPRESENT THE MINIMUM THAT SHALL BE REQUIRED. ADDITIONAL MEASURES MAY BE NECESSARY IF DEEMED APPROPRIATE BY FIELD ENGINEER.

- WM-1 : MATERIAL DELIVERY AND STORAGE
- WM-2 : MATERIAL USE
- WM-3 : STOCKPILE MANAGEMENT
- WM-4 : SPILL PREVENTION AND CONTROL
- WM-5 : SOLID WASTE MANAGEMENT
- WM-6 : HAZARDOUS WASTE MANAGEMENT
- WM-8 : CONCRETE WASTE MANAGEMENT
- WM-9 : SANITARY/SEPTIC WASTE MANAGEMENT

- SE-5 : FIBER ROLLS
- SE-6 : GRAVEL BAG BERM
- SE-7 : STREET SWEEPING AND VACUUMING
- SE-10 : STORM DRAIN INLET PROTECTION
- SE-9 : STRAW BALE BARRIER

- NS-1 : WATER CONSERVATION PRACTICES
- NS-3 : PAVING AND GRADING OPERATIONS
- NS-6 : ILLICIT CONNECTION/DISCHARGE
- NS-7 : POTABLE WATER/IRRIGATION
- NS-8 : VEHICLE AND EQUIPMENT CLEANING
- NS-9 : VEHICLE AND EQUIPMENT FUELING
- NS-10 : VEHICLE AND EQUIPMENT MAINTENANCE
- NS-12 : CONCRETE CURING
- NS-13 : CONCRETE FINISHING

- TC-1 : STABILIZED CONSTRUCTION ENTRANCE
- TC-3 : ENTRANCE/OUTLET TIRE WASH

- EC-1 : SCHEDULING
- EC-2 : PRESERVATION OF EXISTING VEGETATION

- WE-1 : WIND EROSION CONTROL

LEGEND

○○○○○○○○○○ GRAVEL BAG BERM

XXXX


FURNISH & INSTALL THE BMP PRACTICE PER THE REFERENCED DETAIL

□

DROP INLET PROTECTION


NORTH

SCALE=1"=20'

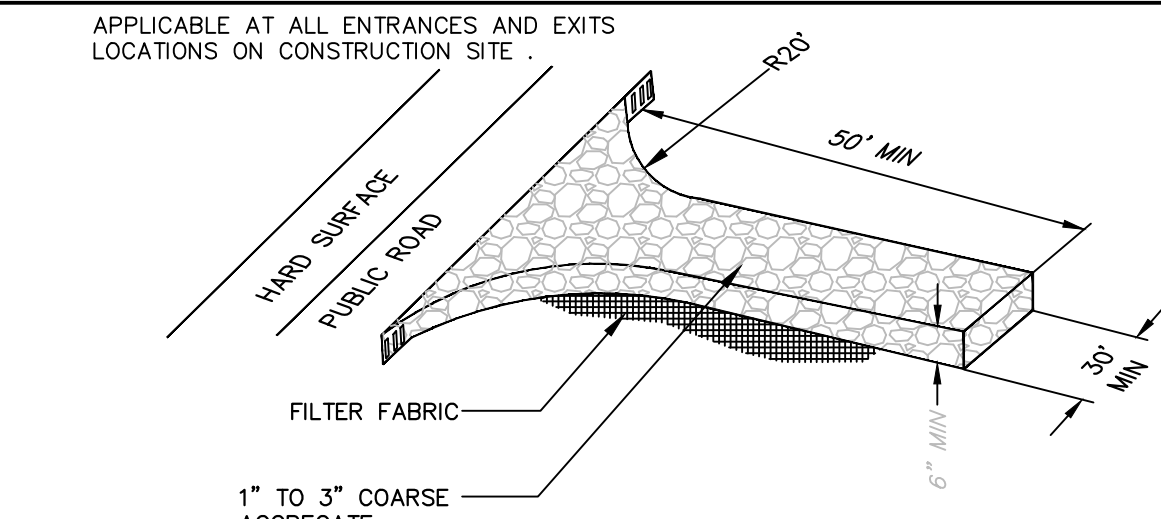



TC-1 | STABILIZED CONSTRUCTION ENTRANCE

LINEAR SEDIMENT BARRIER

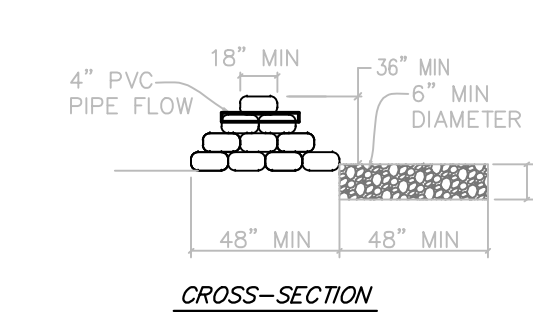


SE-6 | GRAVEL BAG BERM

SWALE, GUTTER OR CURB&GUTTER


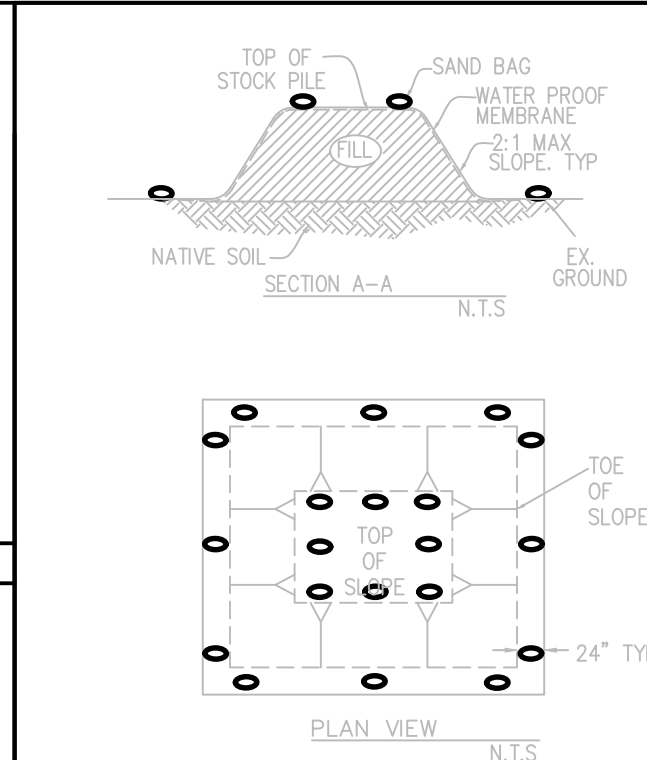
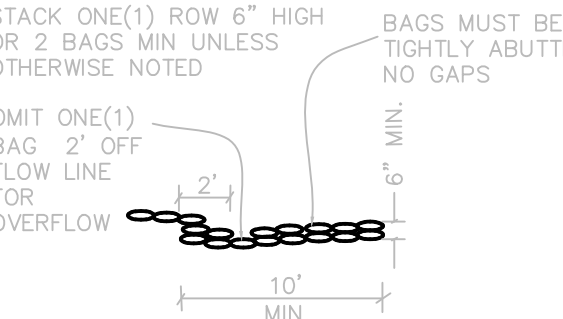


WM-3 | STOCK PILE MANAGEMENT

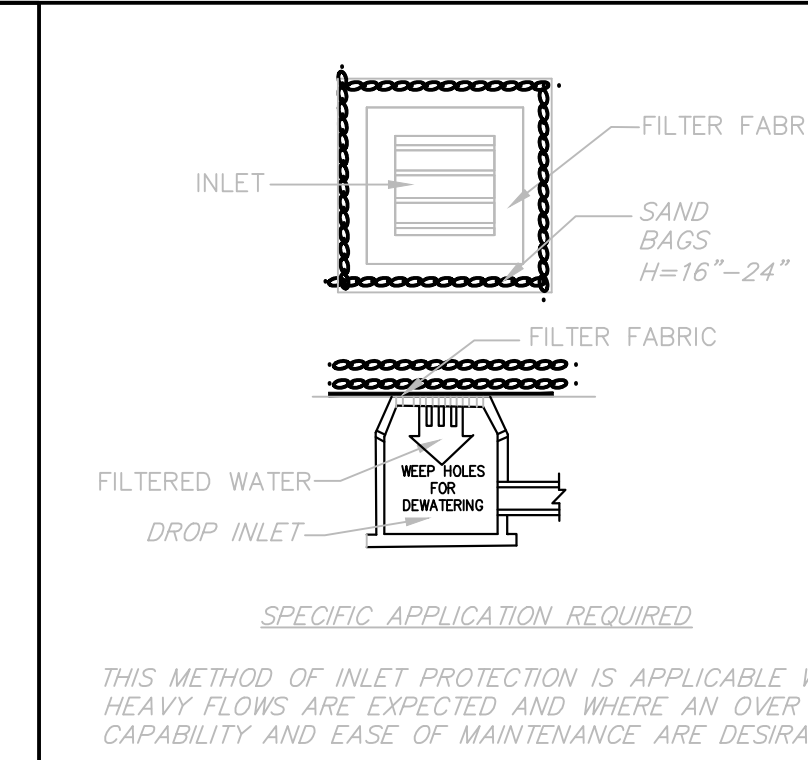

SE-10 | DROP INLET

Entrance/Outlet Tire Wash TC-3

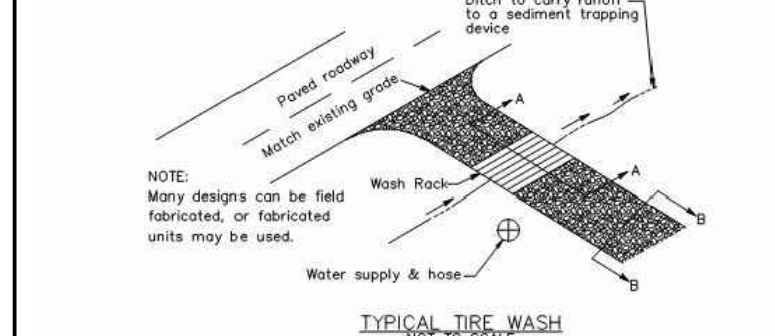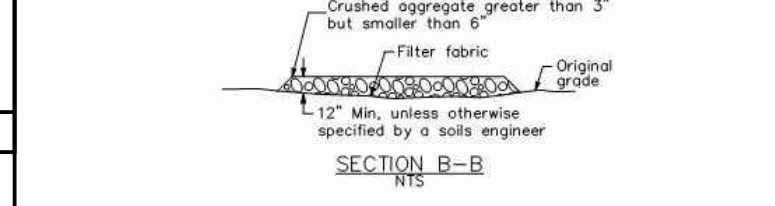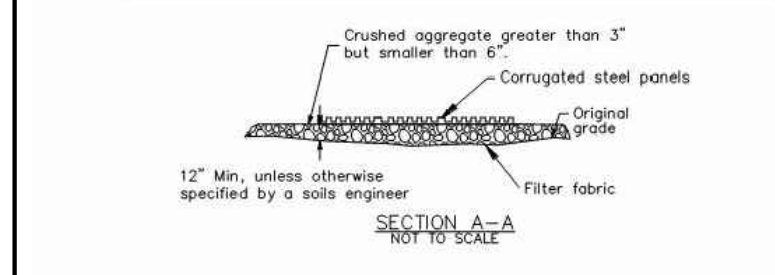

TC-3 | ENTRANCE/OUTLET TIRE WASH

AGENCY REVIEW

IDENTIFICATION STAMP		
DIV. OF THE STATE ARCHITECT	INC.	
APP. 03-120480	REVIEWED FOR	
SS <input type="checkbox"/>	FLS <input type="checkbox"/>	ACS <input type="checkbox"/>
DATE: 07/22/2020		

LITTLE
DIVERSIFIED ARCHITECTURAL CONSULTING

1300 Dove Street, Suite 100
Newport Beach, CA. 92660
T: 949.698.1400

www.littleonline.com

This drawing and the design shown are the property of Little Diversified Architectural Consulting. The reproduction, copying or other use of this drawing without their written consent is prohibited and any infringement will be subject to legal action.

© Little 2020

CLIENT NAME

**OXNARD UNION
HIGH SCHOOL
DISTRICT**

PROJECT NAME


**ADOLFO CAMARILLO HIGH SCHOOL
VISITOR BLEACHERS**

**4660 MISSION OAKS BLVD.,
CAMARILLO, CA. 93012**

CONSULTANT



SEAL

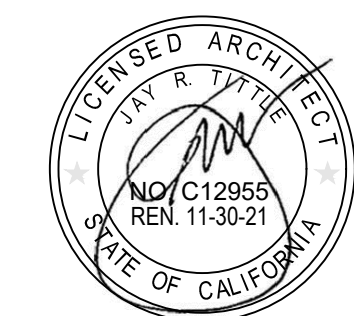

ISSUE FOR
DSA SUBMITTAL

ISSUE DATE
7/22/20

REVISIONS	NO.	REASON	DATE
-----------	-----	--------	------

PROJECT TEAM

PRINCIPAL IN CHARGE
BBC
PROJECT MANAGER
ML
DESIGN TEAM
AT
PROJECT NAME
**ADOLFO CAMARILLO HIGH SCHOOL
VISITOR BLEACHERS**

PROJECT NO.

6121235309

SHEET TITLE
**EROSION CONTROL
PLAN**

SHEET NUMBER

C6.0

STATEMENT BY DESIGN PROFESSIONAL IN GENERAL RESPONSIBLE CHARGE

THE P.O.T. IDENTIFIED IN THESE CONSTRUCTION DOCUMENTS IS COMPLIANT WITH THE CURRENT APPLICABLE CALIFORNIA BUILDING CODE ACCESSIBILITY PROVISIONS FOR PATH OF TRAVEL REQUIREMENTS FOR ALTERATIONS, ADDITIONS AND STRUCTURAL REPAIRS. AS PART OF THE DESIGN OF THIS PROJECT, THE P.O.T. WAS EXAMINED AND ANY ELEMENTS, COMPONENTS OR PORTIONS OF THE P.O.T. THAT WERE DETERMINED TO BE NONCOMPLIANT 1) HAVE BEEN IDENTIFIED AND 2) THE CORRECTIVE WORK NECESSARY TO BRING THEM INTO COMPLIANCE HAS BEEN INCLUDED WITHIN THE SCOPE OF THIS PROJECT'S WORK THROUGH DETAILS, DRAWINGS AND SPECIFICATIONS INCORPORATED INTO THESE CONSTRUCTION DOCUMENTS. ANY NONCOMPLIANT ELEMENTS, COMPONENTS OR PORTIONS OF THE P.O.T. THAT WILL NOT BE CORRECTED BY THIS PROJECT BASED ON VALUATION THRESHOLD LIMITATIONS OR A FINDING OF UNREASONABLE HARDSHIP ARE SO INDICATED IN THESE CONSTRUCTION DOCUMENTS. DURING CONSTRUCTION, IF POT ITEMS WITHIN THE SCOPE OF THE PROJECT REPRESENTED AS CODE COMPLIANT ARE FOUND TO BE NONCONFORMING BEYOND REASONABLE CONSTRUCTION TOLERANCES, THEY SHALL BE BROUGHT INTO COMPLIANCE WITH THE CBC AS A PART OF THIS PROJECT BY MEANS OF A CONSTRUCTION CHANGE DOCUMENT.

GENERAL NOTES

1. POT PER A# 03-120008 INC. 2

2. ARCHITECT SHALL VERIFY PATH OF TRAVEL REQUIREMENTS ARE MET FOR P.O.T. FROM ACCESSIBLE PARKING AND PUBLIC WAY TO RESTROOMS, DRINKING FOUNTAINS, SCHOOL ADMINISTRATION BUILDING, ACCESSIBLE SEATING AND INSIDE TRACK AS INDICATED. ANY DEVIATION FROM P.O.T. DEFINITION LISTED BELOW SHALL BE BROUGHT INTO COMPLIANCE BY THE ARCHITECT PREPARING A C.C.D. AND SUBMITTING IT TO DSA FOR APPROVAL.

3. PATH OF TRAVEL (P.O.T.) AS INDICATED IS A BARRIER-FREE ACCESS WITHOUT ANY ABRUPT VERTICAL CHANGES EXCEEDING 1/2" BEVELED AT 1:2 MAXIMUM SLOPE. EXCEPT THAT LEVEL CHANGES DO NOT EXCEED 1/4" VERTICAL AND IS AT LEAST 48" WIDE. SURFACE IS SLIP-RESISTANT, STABLE, FIRM, AND SMOOTH. CROSS-SLOPE DOES NOT EXCEED 2% AND SLOPE IN THE DIRECTION OF TRAVEL IS LESS THAN 5%, UNLESS OTHERWISE INDICATED. P.O.T. SHALL MAINTAIN FREE OF OVERHANGING OBSTRUCTIONS TO 80" MINIMUM (CBC 11B-307.4) AND PROTRUDING OBJECTS GREATER THAN 4" PROJECTION FROM THE WALL AND ABOVE 27" AND LESS THAN 80" (CBC 11B-307). ARCHITECT SHALL VERIFY THAT ALL BARRIERS IN THE PATH OF TRAVEL HAVE BEEN REMOVED OR WILL BE REMOVED UNDER THIS PROJECT, AND PATH OF TRAVEL COMPLIES WITH CHAPTER 11 DIVISION 4 OF THE 2016 CBC.

4. ALL EXISTING ELEMENTS TO REMAIN SHALL BE PROTECTED IN PLACE, TYP.

KEYNOTES




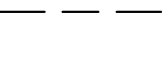
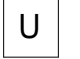
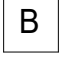
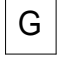
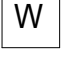
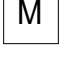

- 32.03 ASPHALT PAVING, SEE CIVIL DRAWINGS - 32.12.16
32.04 CONCRETE PAVING, SEE CIVIL DRAWINGS - 32.13.13
32.51 4' HIGH CHAIN LINK FENCE, SEE DETAIL 1 & 2/G1.1 - 32.31.13

PARKING ANALYSIS

TOTAL SPACES PROVIDED:	554
(E) PARKING LOT 1 -	149
ACCESSIBLE SPACES:	REQUIRED: 5 PROVIDED: 11
VAN ACCESSIBLE SPACES:	REQUIRED: 1 PROVIDED: 1
(E) PARKING LOT 2 -	225
ACCESSIBLE SPACES:	REQUIRED: 7 PROVIDED: 7
VAN ACCESSIBLE SPACES:	REQUIRED: 2 PROVIDED: 2
(E) PARKING LOT 4 -	147
ACCESSIBLE SPACES:	REQUIRED: 5 PROVIDED: 7
VAN ACCESSIBLE SPACES:	REQUIRED: 1 PROVIDED: 1
(E) PARKING LOT 5 -	12
ACCESSIBLE SPACES:	REQUIRED: 1 PROVIDED: 2
VAN ACCESSIBLE SPACES:	REQUIRED: 1 PROVIDED: 1


NOTE: CALCULATION PER 2016 CALIFORNIA BUILDING CODE TABLE 11B-208.2 PARKING SPACES, SEC. 11B-208.2.4 VAN PARKING SPACES

LEGEND

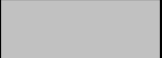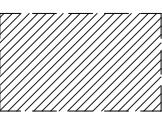	(E) BUILDING TO REMAIN
	SAFE DISPERSAL AREA
	EXTENT OF SCOPE OF WORK
	ACCESSIBLE PATH OF TRAVEL PER DSA A# 03-120008 INC. 2
	UNISEX RESTROOM
	BOYS' RESTROOM
	GIRLS' RESTROOM
	WOMEN'S RESTROOM
	MEN'S RESTROOM
	DRINKING FOUNTAIN

DSA CERTIFICATIONS

03-101554	CERTIFICATION AND CLOSE OF FILE, LETTER TYPE #1, 04/24/2001
03-109189	CERTIFICATION AND CLOSE OF FILE, LETTER TYPE #3, 01/28/2010
03-113830	CERTIFICATION AND CLOSE OF FILE, LETTER TYPE #1, 10/04/2013
03-114471	CERTIFICATION AND CLOSE OF FILE, LETTER TYPE #1, 06/05/2014
03-108509	CERTIFICATION AND CLOSE OF FILE, LETTER TYPE 301P, 12/01/2014
03-109962	CERTIFICATION AND CLOSE OF FILE, LETTER TYPE 301P, 06/26/2015
03-110482	CERTIFICATION AND CLOSE OF FILE, LETTER TYPE #2, 07/14/2015
03-110017	CERTIFICATION AND CLOSE OF FILE, LETTER TYPE #2, 04/19/2016
03-103015	CERTIFICATION AND CLOSE OF FILE, LETTER TYPE #2, 12/04/2017
03-119338	SUBMITTED 12/11/2018, OPEN
03-120008_INC 01	OPEN, APPRPVED 10/02/2019
03-120008_INC 02	OPEN, APPRPVED 01/06/2020

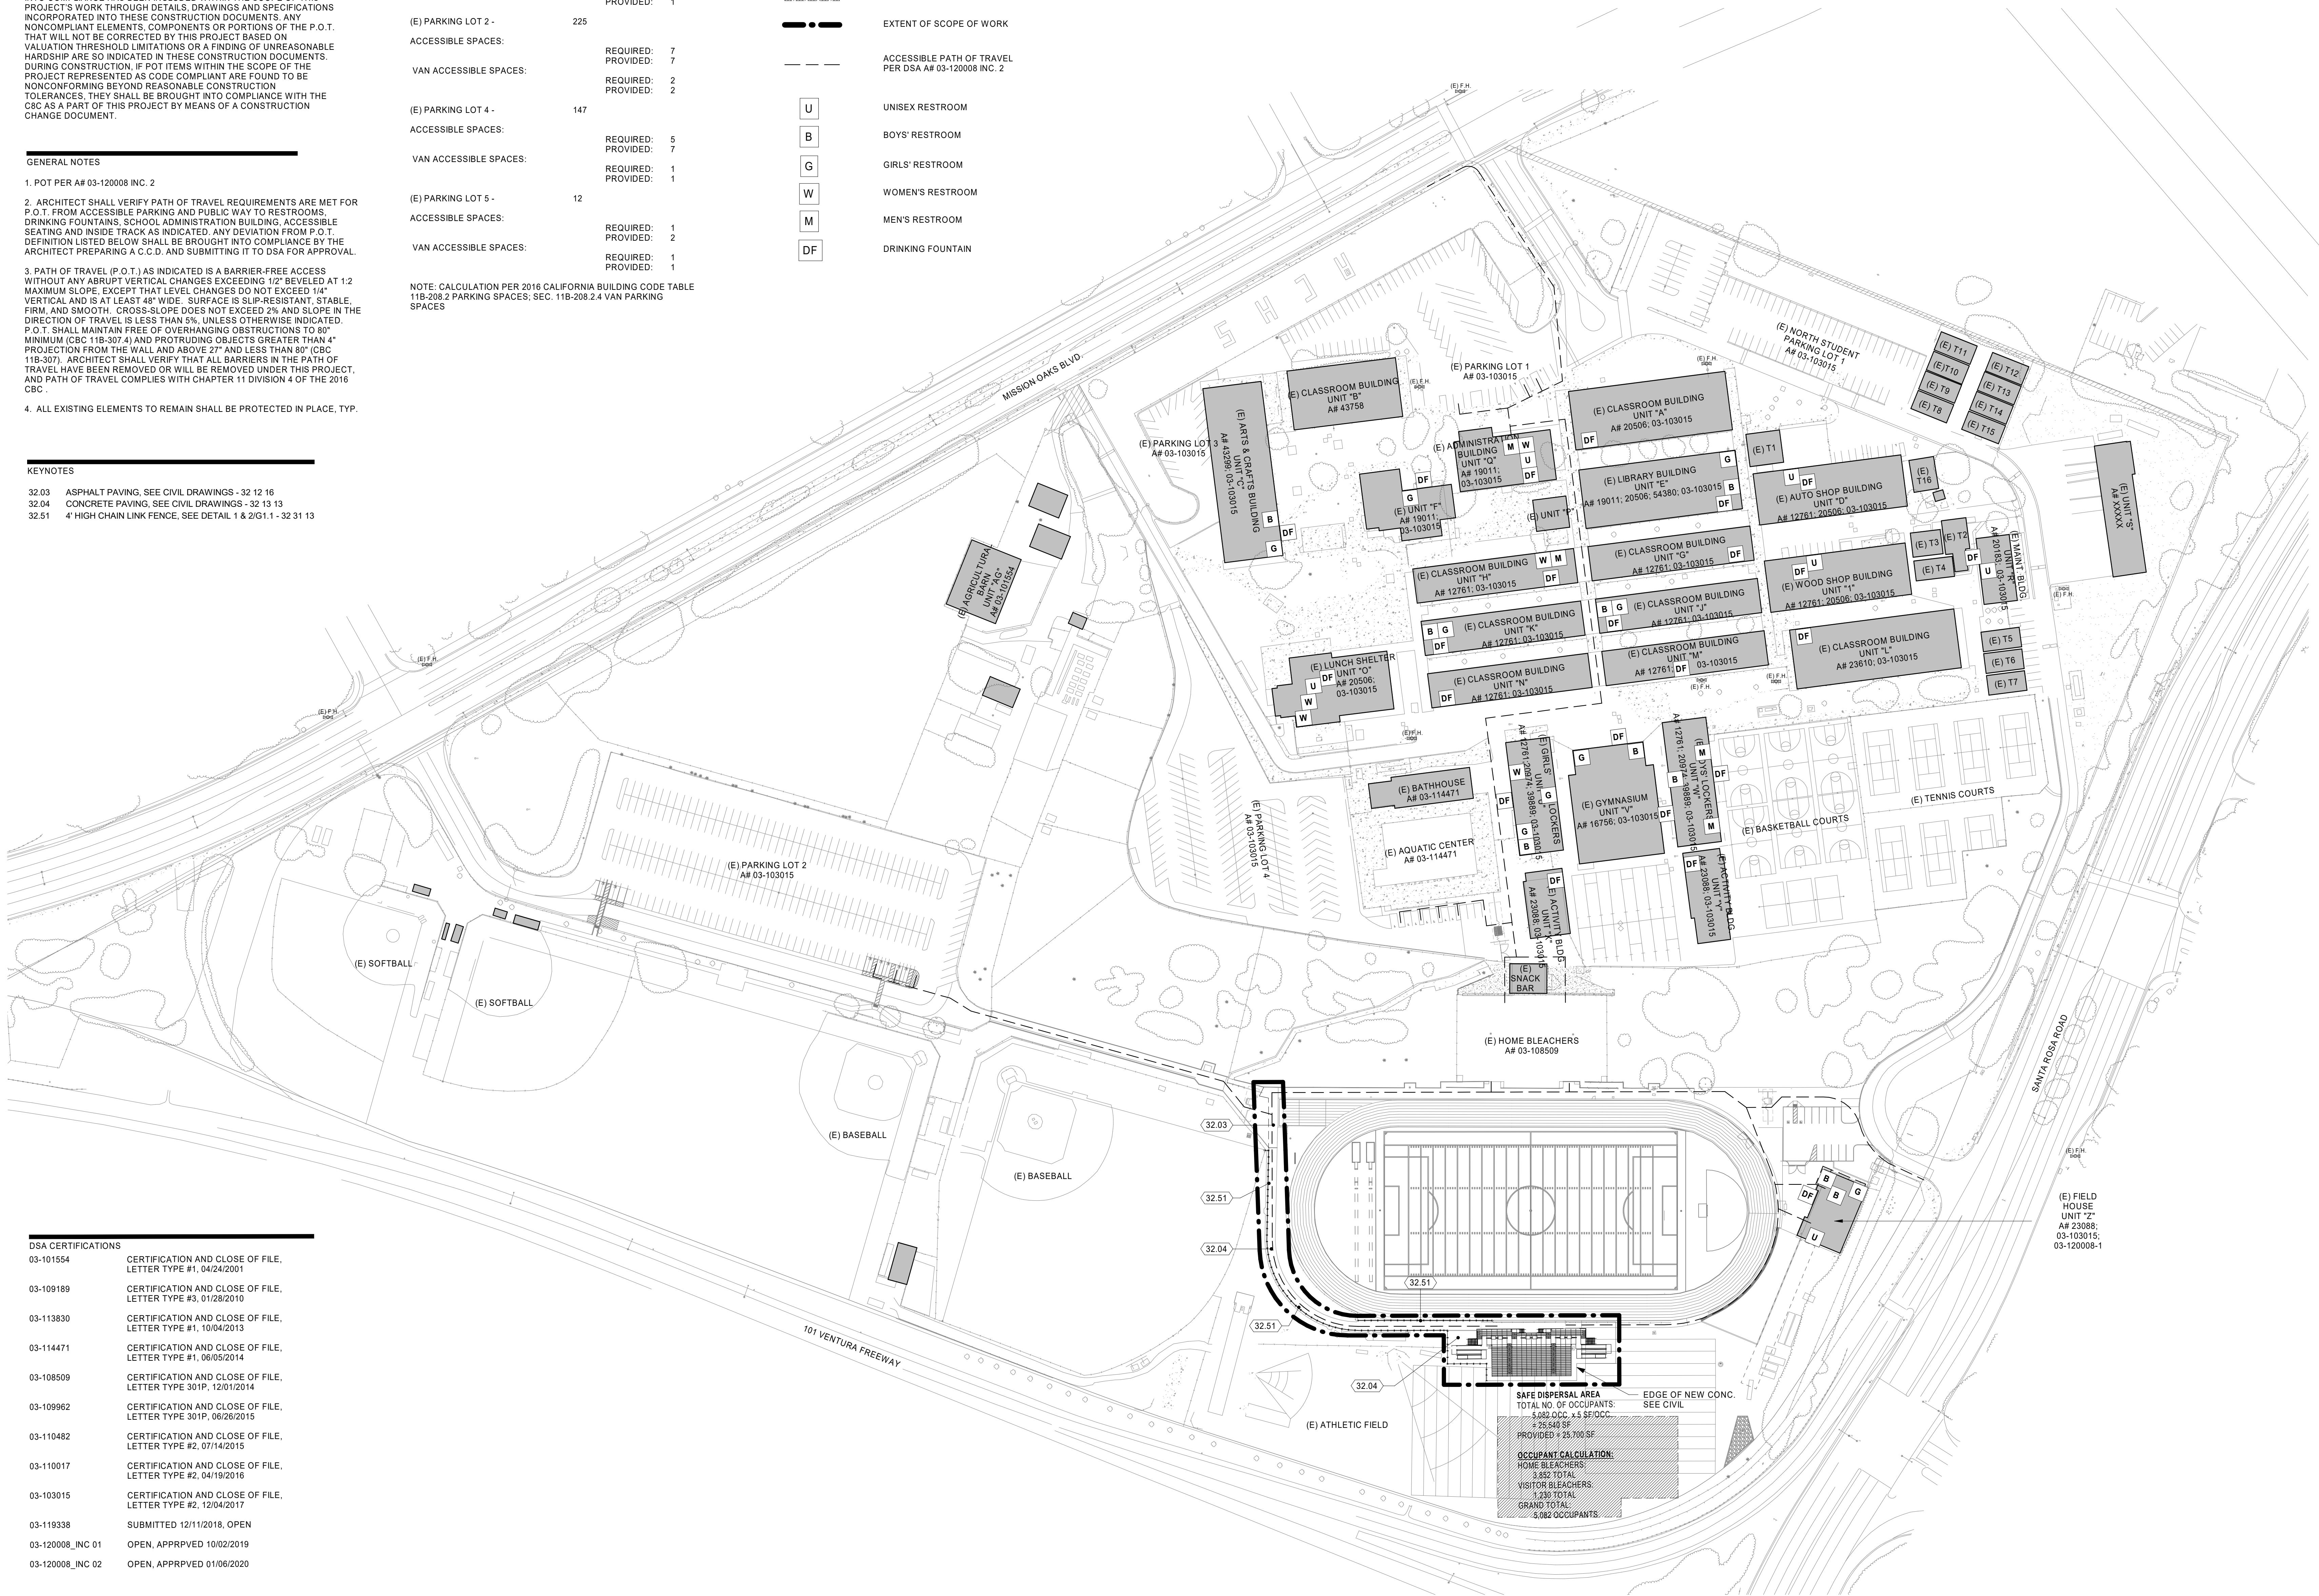

OVERALL SITE PLAN

1

1" = 80'-0" A1.1

AGENCY REVIEW

IDENTIFICATION STAMP	
DIV. OF THE STATE ARCHITECT	
APP. 03-120480 INC.	
REVIEWED FOR	
SS <input type="checkbox"/> FLS <input type="checkbox"/> ACS <input type="checkbox"/>	
DATE: 07/22/2020	

LITTLE
DIVERSIFIED ARCHITECTURAL CONSULTING

1300 Dove Street, Suite 100
Newport Beach, CA, 92660
T: 949.698.1400

www.littleonline.com

This drawing and the design shown are the property of Little Diversified Architectural Consulting. The reproduction, copying or other use of this drawing without their written consent is prohibited and any infringement will be subject to legal action.

© Little 2019

CLIENT NAME

**OXNARD UNION
HIGH SCHOOL
DISTRICT**


PROJECT NAME

**ADOLFO CAMARILLO HIGH SCHOOL
VISITOR BLEACHERS**

**4660 MISSION OAKS BLVD.,
CAMARILLO, CA. 93012**

CONSULTANT

SEAL

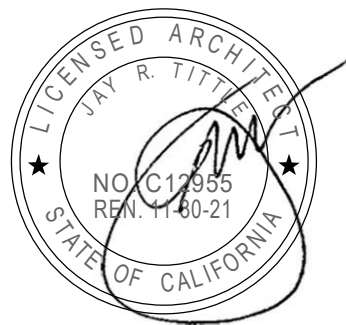

ISSUE FOR

DSA SUBMITTAL

ISSUE DATE

07/22/2020

REVISIONS

NO.	REASON	DATE

PROJECT TEAM

PRINCIPAL IN CHARGE

JT

PROJECT MANAGER

FM

DESIGN TEAM

FM

PROJECT NAME

**ADOLFO CAMARILLO HIGH
SCHOOL VISITOR
BLEACHERS**

PROJECT NO.

6121235309

SHEET TITLE

OVERALL SITE PLAN

SHEET NUMBER

A1.1

C:\Users\lamez.mahjoub\Documents\6121235309 OXNARD UHSD ADOLFO CAMARILLO HS VISITOR BLEACHER-CENTRAL 18
NEW_lamez.mahjoub.rvt

7/15/2020 4:38:01 PM

OXNARD UNION H.S. DISTRICT ADOLFO CAMARILLO H. S. VISITOR CAMARILLO, CALIFORNIA

SHEET TITLE	SHEET NUMBER
COVER PAGE	B1
GENERAL NOTES	B2
FOOTING LAYOUT	B3
FOOTING DETAILS	B4
UNDERSTRUCTURE LAYOUT	B5
ELEVATION VIEWS	B6
SECTION VIEW	B7
SECTION VIEW	B8
SECTION VIEW	B9
SIGHT LINES	B10
SEATING LAYOUT	B11
EXITS	B12
EXITS	B13
EXIT DETAILS	B14
EXIT DETAILS	B15
EXIT DETAILS	B16
SEAT BRACKET LAYOUT	B17
PLANK DETAILS	B18
DETAILS	B19
DETAILS	B20



PO Box One, Graham, Texas 76450
801 Fifth Street.
Phone: 940/549-0733 Fax: 940/549-1365

Established 1946



REVISION 1 7/13/2020


GENERAL INFORMATION	
RISE:	8" & 12"
TREAD:	26"
ROWS:	22
LENGTH:	133'-6"
SEAT COUNT:	1230

DATE: 4/20/20
JOB #20013
OXNARD UNION H.S. DISTRICT
ADOLFO CAMARILLO H. S. VISITOR
CAMARILLO, CALIFORNIA

#20013 - CAMARILLO, CALIFORNIA


SHEET
B1

OF
B20

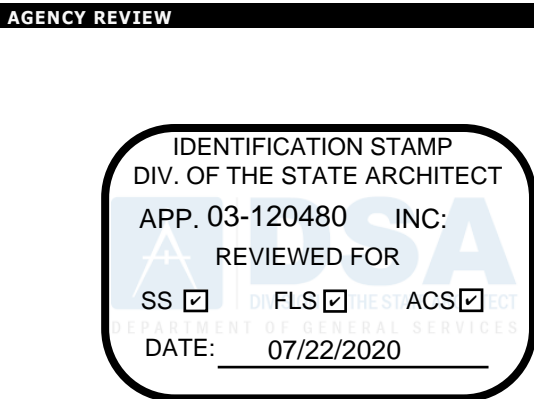

CLIENT NAME
OXNARD UNION
HIGH SCHOOL
DISTRICT

PROJECT NAME
ADOLFO CAMARILLO HIGH SCHOOL
VISITOR BLEACHERS
4660 MISSION OAKS BLVD,
CAMARILLO, CA. 93012

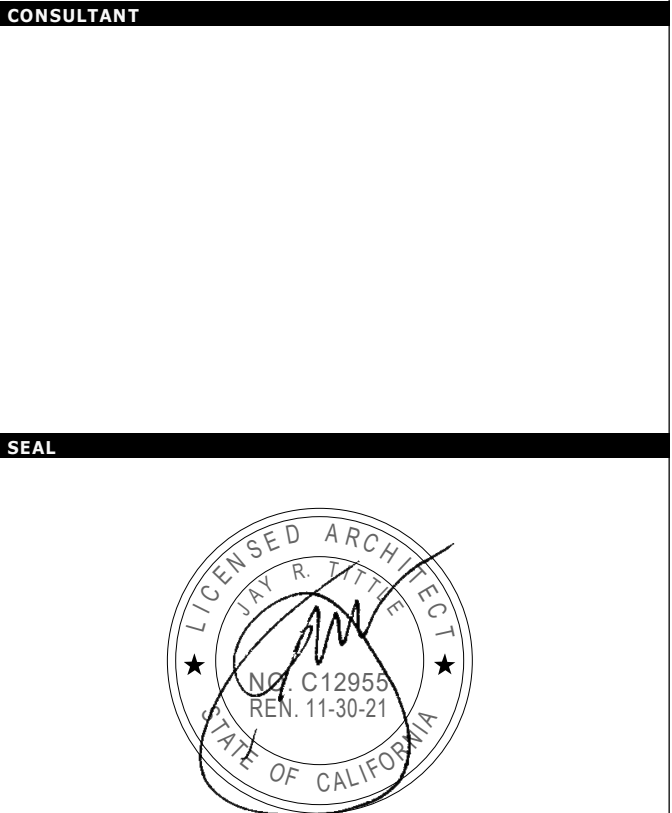

ISSUE FOR
DSA SUBMITTAL
ISSUE DATE
07/22/2020
REVISIONS
NO. REASON DATE





PROJECT TEAM
PRINCIPAL IN CHARGE
PROJECT MANAGER
DESIGN TEAM
PROJECT NAME
ADOLFO CAMARILLO HIGH
SCHOOL VISITOR
BLEACHERS

PROJECT NO.
6121235309
SHEET TITLE
COVER PAGE

SHEET NUMBER
B1

FOUNDATION NOTES




1. OWNER/OWNERS REP SHALL VERIFY ALL DIMENSIONS PRIOR TO START OF CONSTRUCTION.
2. REINFORCING STEEL SHALL BE ASTM A615 GRADE 60.
3. CONCRETE SHALL HAVE A MINIMUM COMPRESSIVE STRENGTH OF 3000 PSI AT 28 DAYS.
4. MAXIMUM HORIZ. TOLERANCE OF ANCHOR BOLT PLACEMENT SHALL BE $\pm\frac{3}{8}"$.
5. ALL ANCHOR BOLTS SHALL HAVE A $3\frac{1}{2}"$ PROJECTION ($\pm\frac{3}{8}"$) ABOVE THE TOP OF PIER ELEVATION, UNLESS SPECIFICALLY NOTED OTHERWISE.
6. THE CONCRETE FOUNDATION CONTRACTOR IS RESPONSIBLE FOR NON SHRINK GROUTING.
7. THE ELEVATION AT THE TOP OF THE CONCRETE PIER IS DESIGNED TO BE 1" BELOW THE BOTTOM OF STEEL ELEVATION. THE TOLERANCE FOR THE BOTTOM OF STEEL ELEVATION IS $\pm\frac{3}{8}"$. THE TOP OF CONCRETE ELEVATION MAY BE RAISED TO MATCH THE BOTTOM OF STEEL ELEVATION, AT THE CONCRETE CONTRACTORS DISCRETION. THE CONTRACTOR OF THE CONCRETE FOUNDATIONS IS RESPONSIBLE FOR ANY ADJUSTMENTS REQUIRED.
8. ALL UNDERGROUND UTILITIES ARE TO BE LOCATED AND MARKED DURING THE REVIEW PROCESS BY THE OWNERS REPRESENTATIVE PRIOR TO FOUNDATION EXCAVATION.
9. REMOVE/RELOCATE THE UNDERGROUND UTILITIES AS REQUIRED WHERE UNDERGROUND UTILITIES CONFLICT WITH THE NEW FOOTINGS.

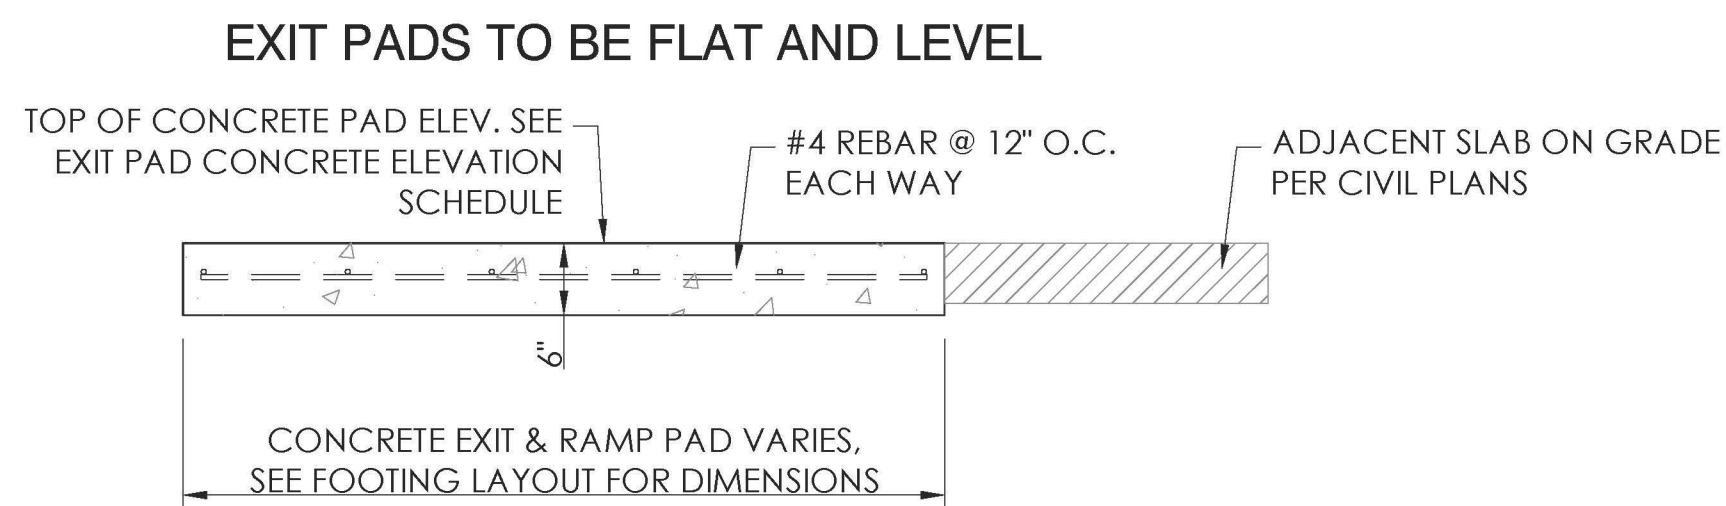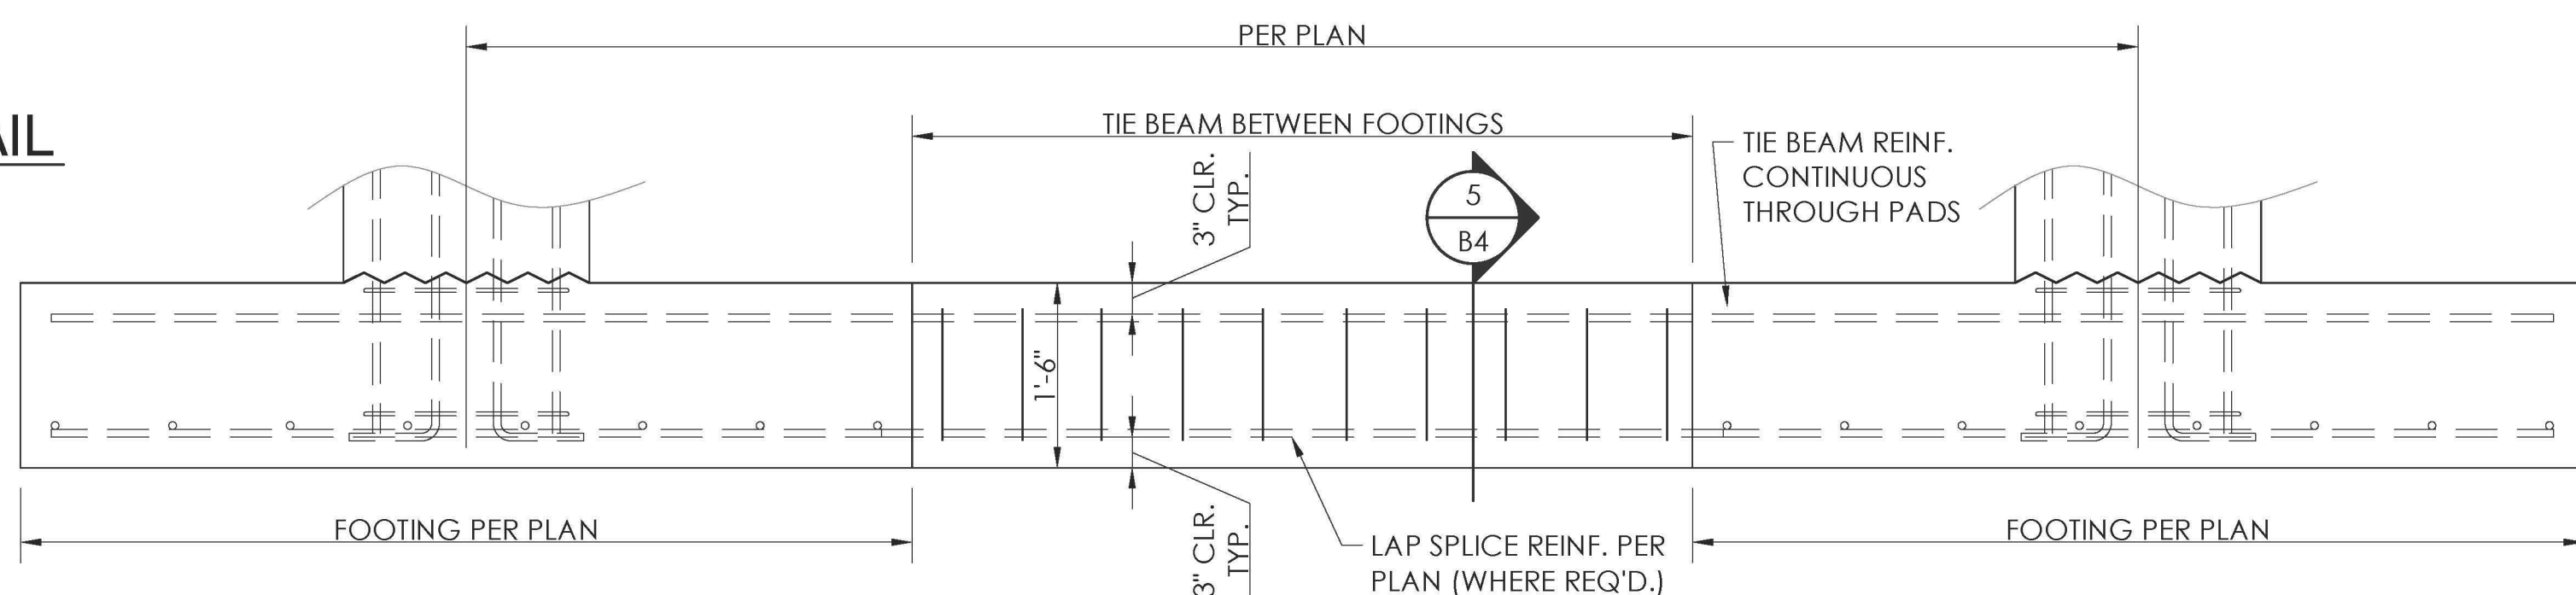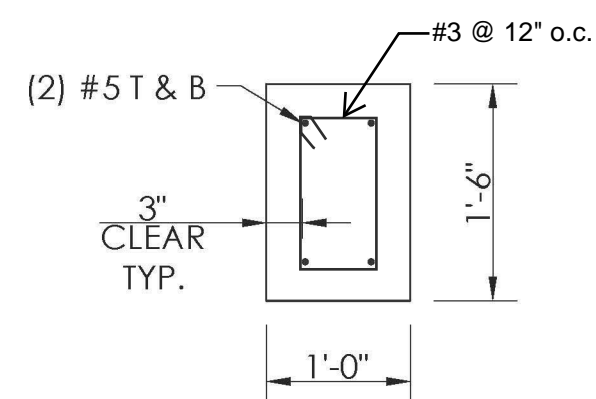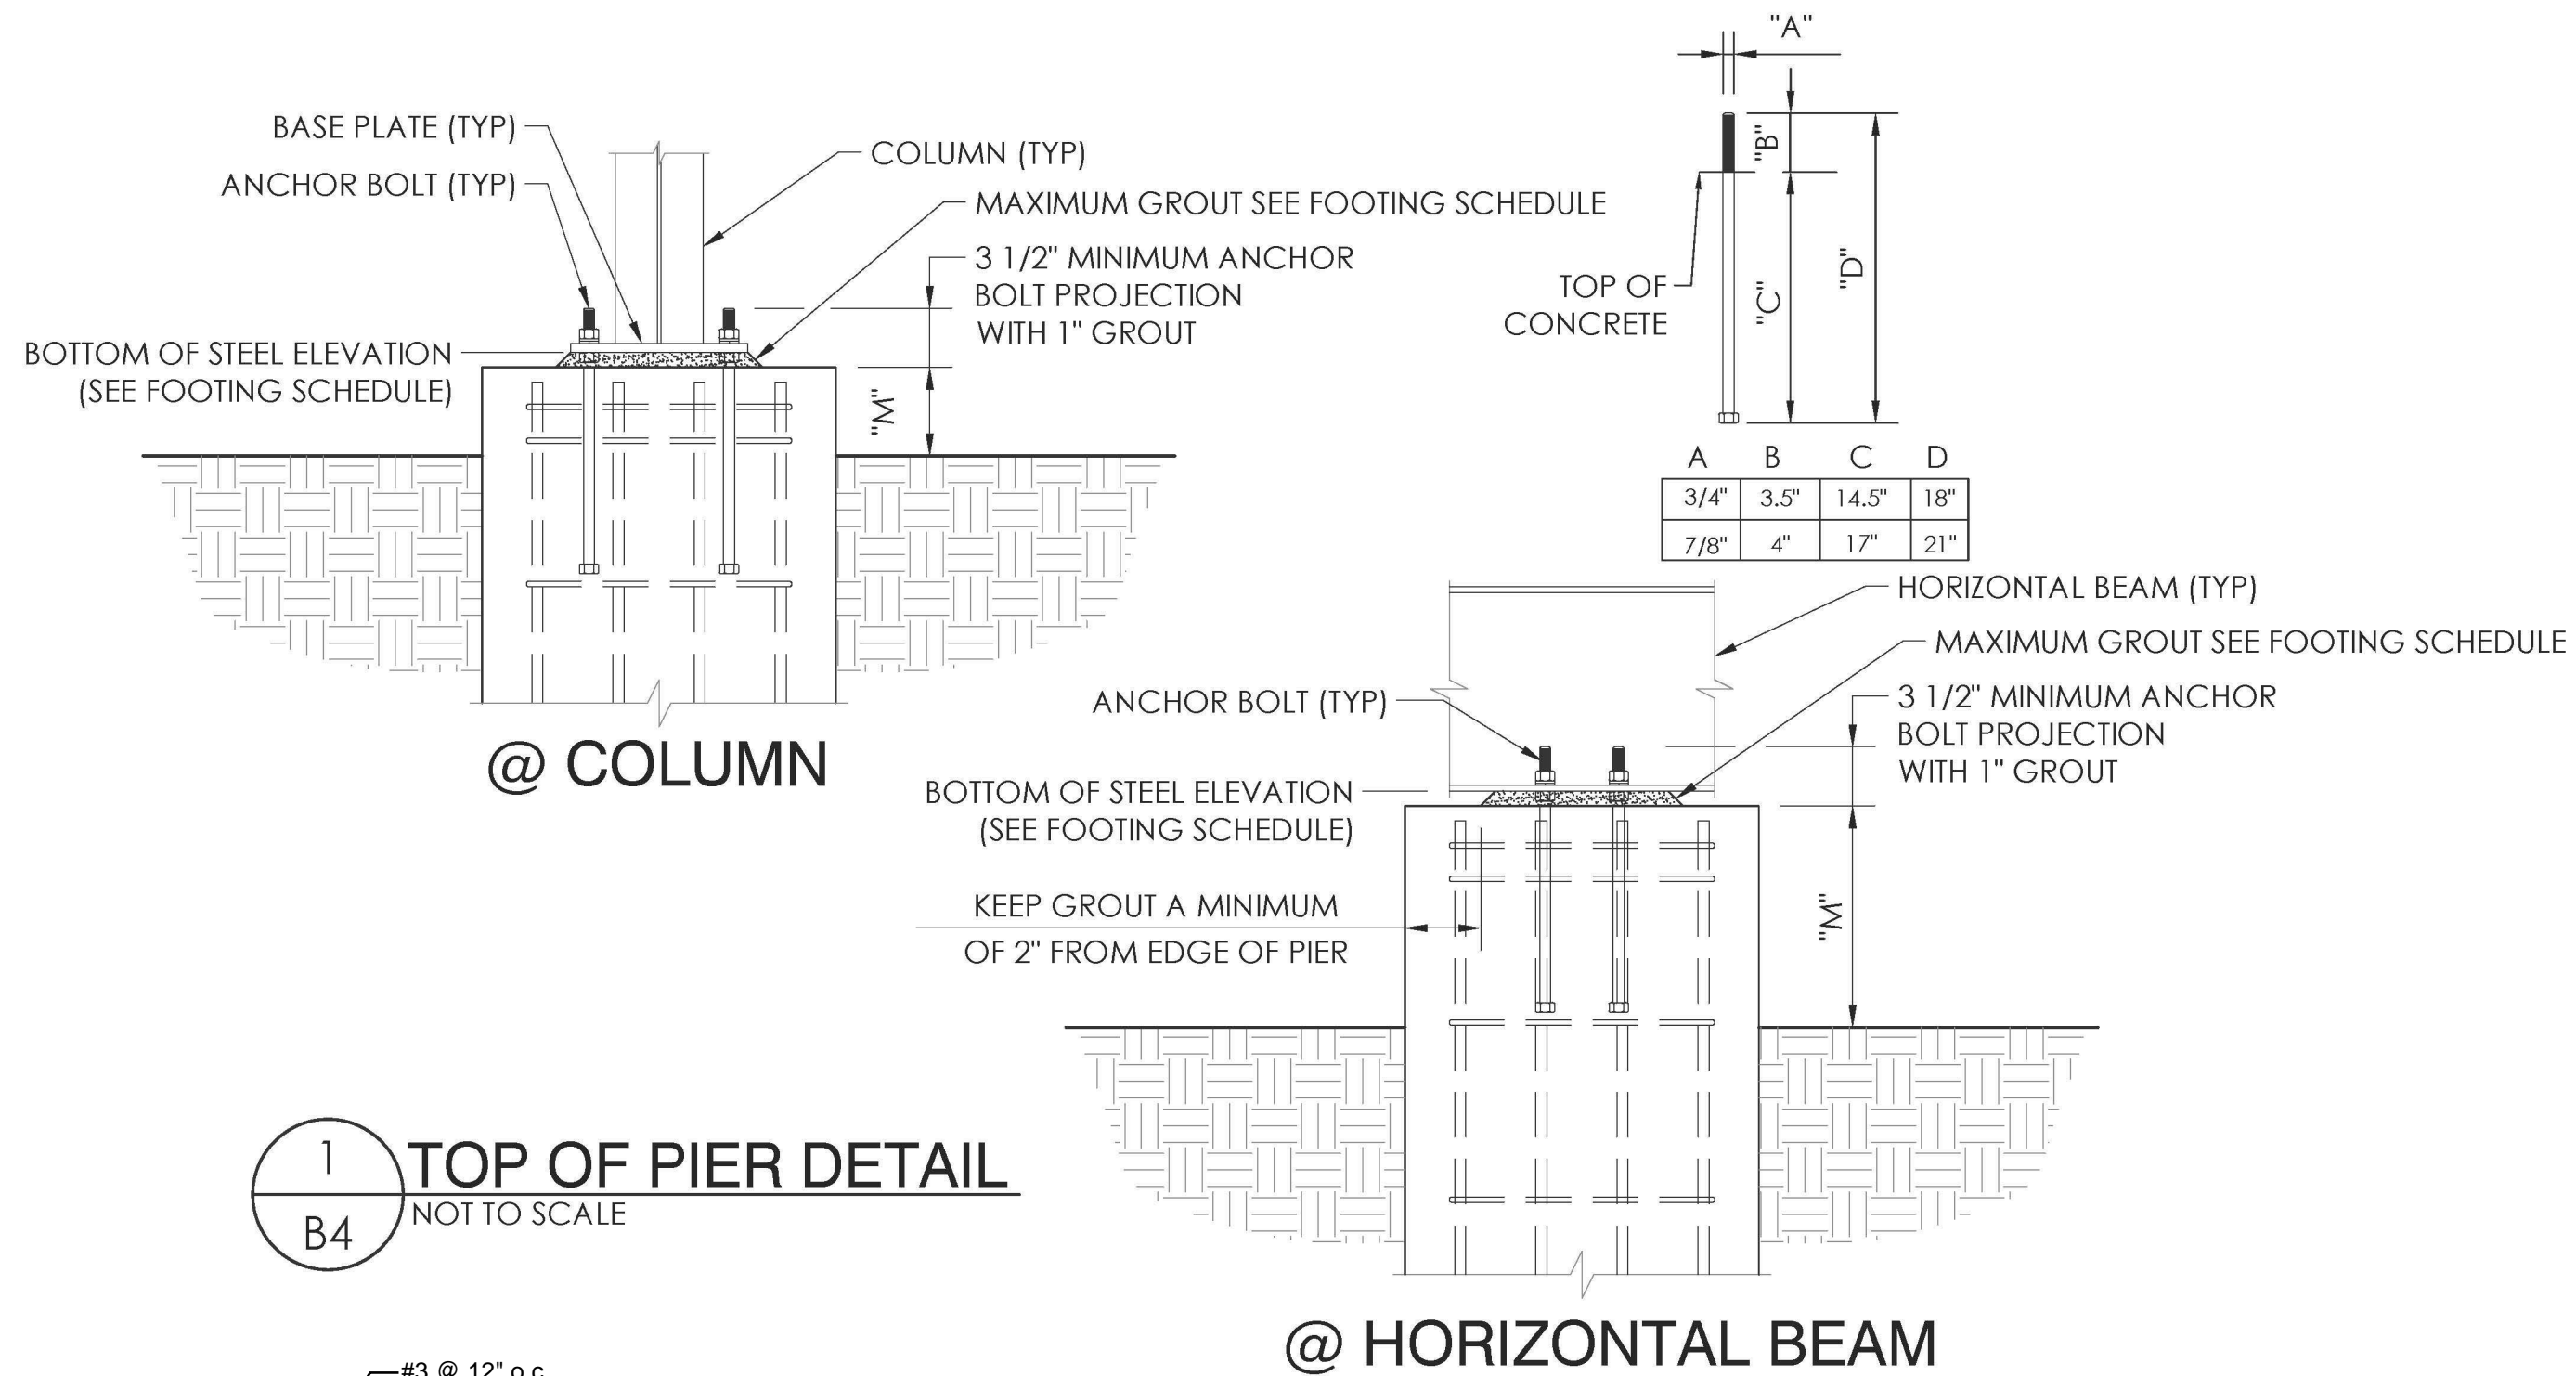


EXIT PAD CONCRETE ELEVATION SCHEDULE

(P = CONCRETE PAD)	TOP OF CONCRETE ELEV.
P1, & P6	99.25'
P2, & P5	99.75'
P3, & P4	100.00'

FOOTING # (R = RAMP PIER)	T.O.P. ELEV.	B.O.S. ELEV.	GROUT	"H"	"D"	"M"	"W"	FOOTING REINFORCEMENT
A1, A7	101.23'	101.33'	1 1/4"	15"	18"	24" MAX.	5'-9" X 5'-9"	(6) #6 EACH WAY BOTTOM & TOP
A2, A6	101.23'	101.33'	1 1/4"	15"	18"	24" MAX.	7'-9" X 7'-9"	(7) #6 EACH WAY BOTTOM & TOP
A3, A5	101.23'	101.31'	1"	15"	18"	24" MAX.	8'-3" X 8'-3"	(8) #6 EACH WAY BOTTOM & TOP
A4	101.23'	101.31'	1"	15"	18"	24" MAX.	7'-9" X 7'-9"	(7) #6 EACH WAY BOTTOM & TOP
B	100.02'	100.13'	1"	15"	18"	12" MAX.	5'-0" X 5'-0"	(5) #6 EACH WAY BOTTOM
C	99.62'	99.70'	1"	15"	18"	12" MAX.	5'-0" X 5'-0"	(5) #6 EACH WAY BOTTOM
D	99.22'	99.30'	1"	15"	18"	12" MAX.	4'-6" X 4'-6"	(4) #6 EACH WAY BOTTOM
R1, R2, R7, R8	99.90'	99.98'	1"	15"	18"	12" MAX.	4'-3" X 4'-3"	(4) #6 EACH WAY BOTTOM
R5, R6, R11, R12	100.62'	100.70'	1"	15"	18"	36" MAX.	3'-9" X 3'-9"	(4) #6 EACH WAY BOTTOM
R3, R4, R9, R10	99.76'	99.84'	1"	15"	18"	12" MAX.	3'-9" X 3'-9"	(4) #6 EACH WAY BOTTOM

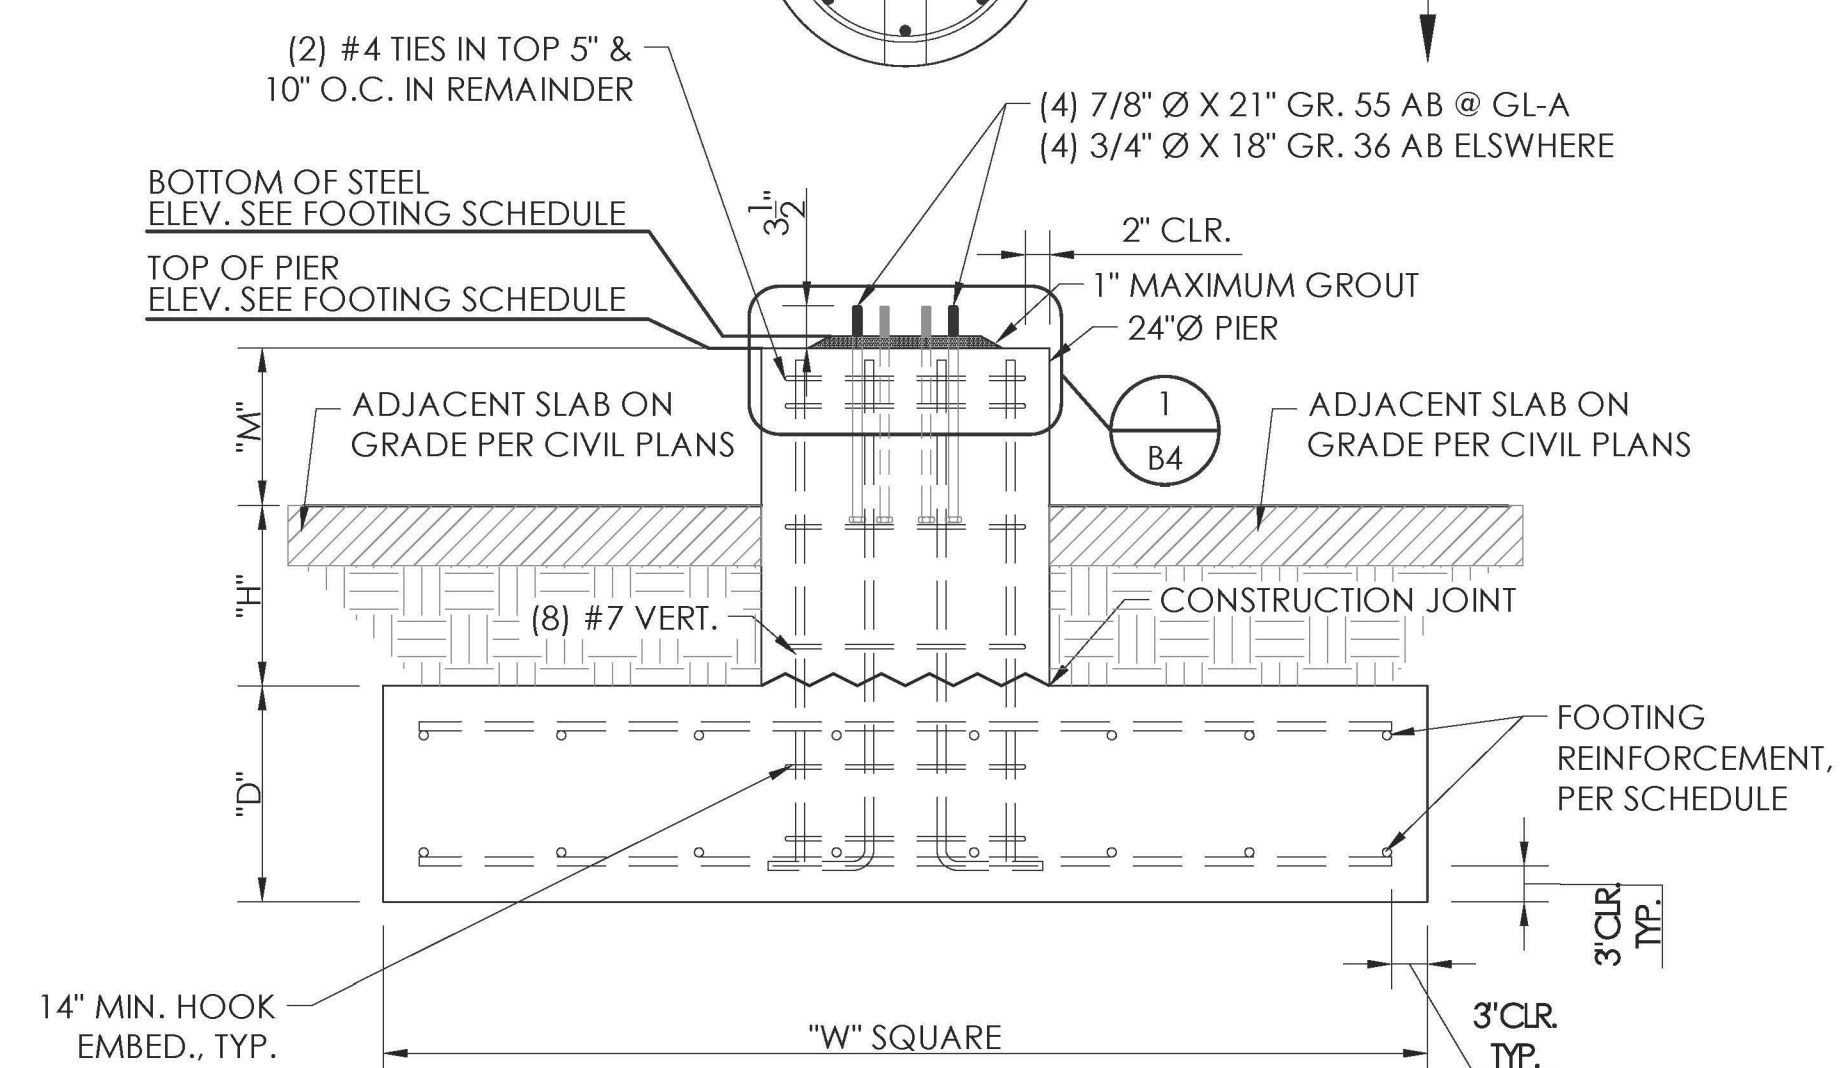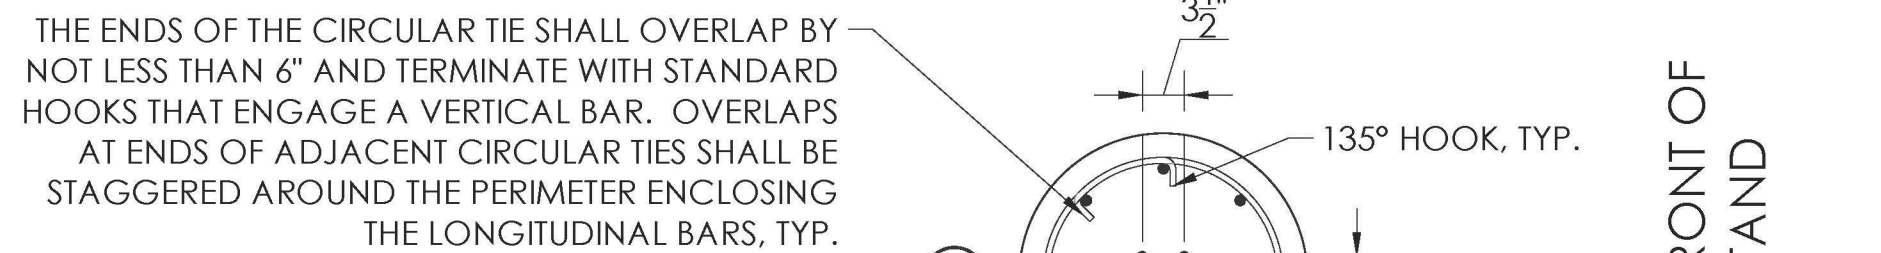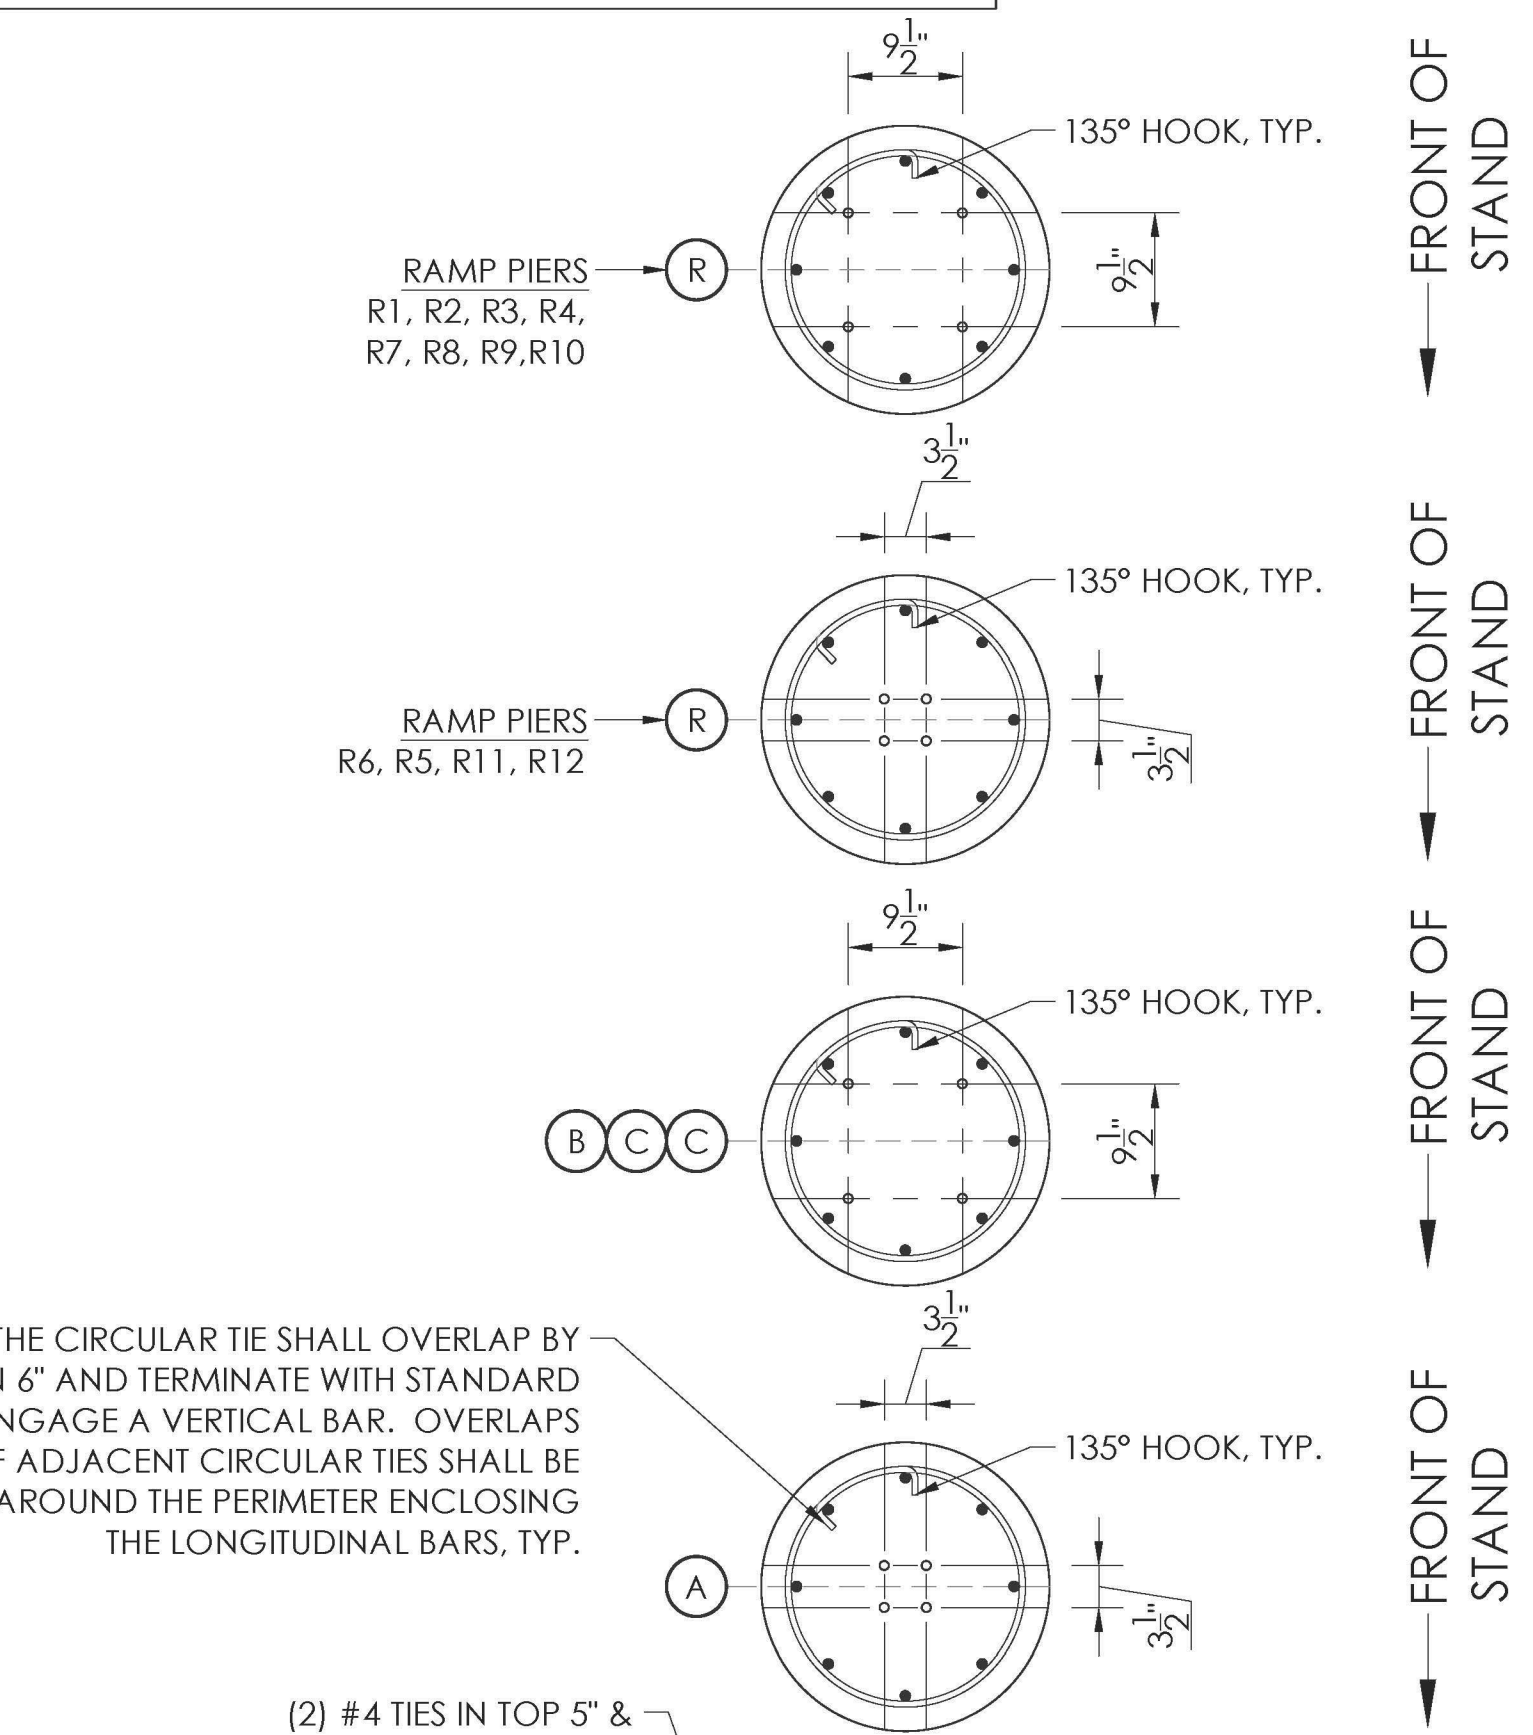[illegible]

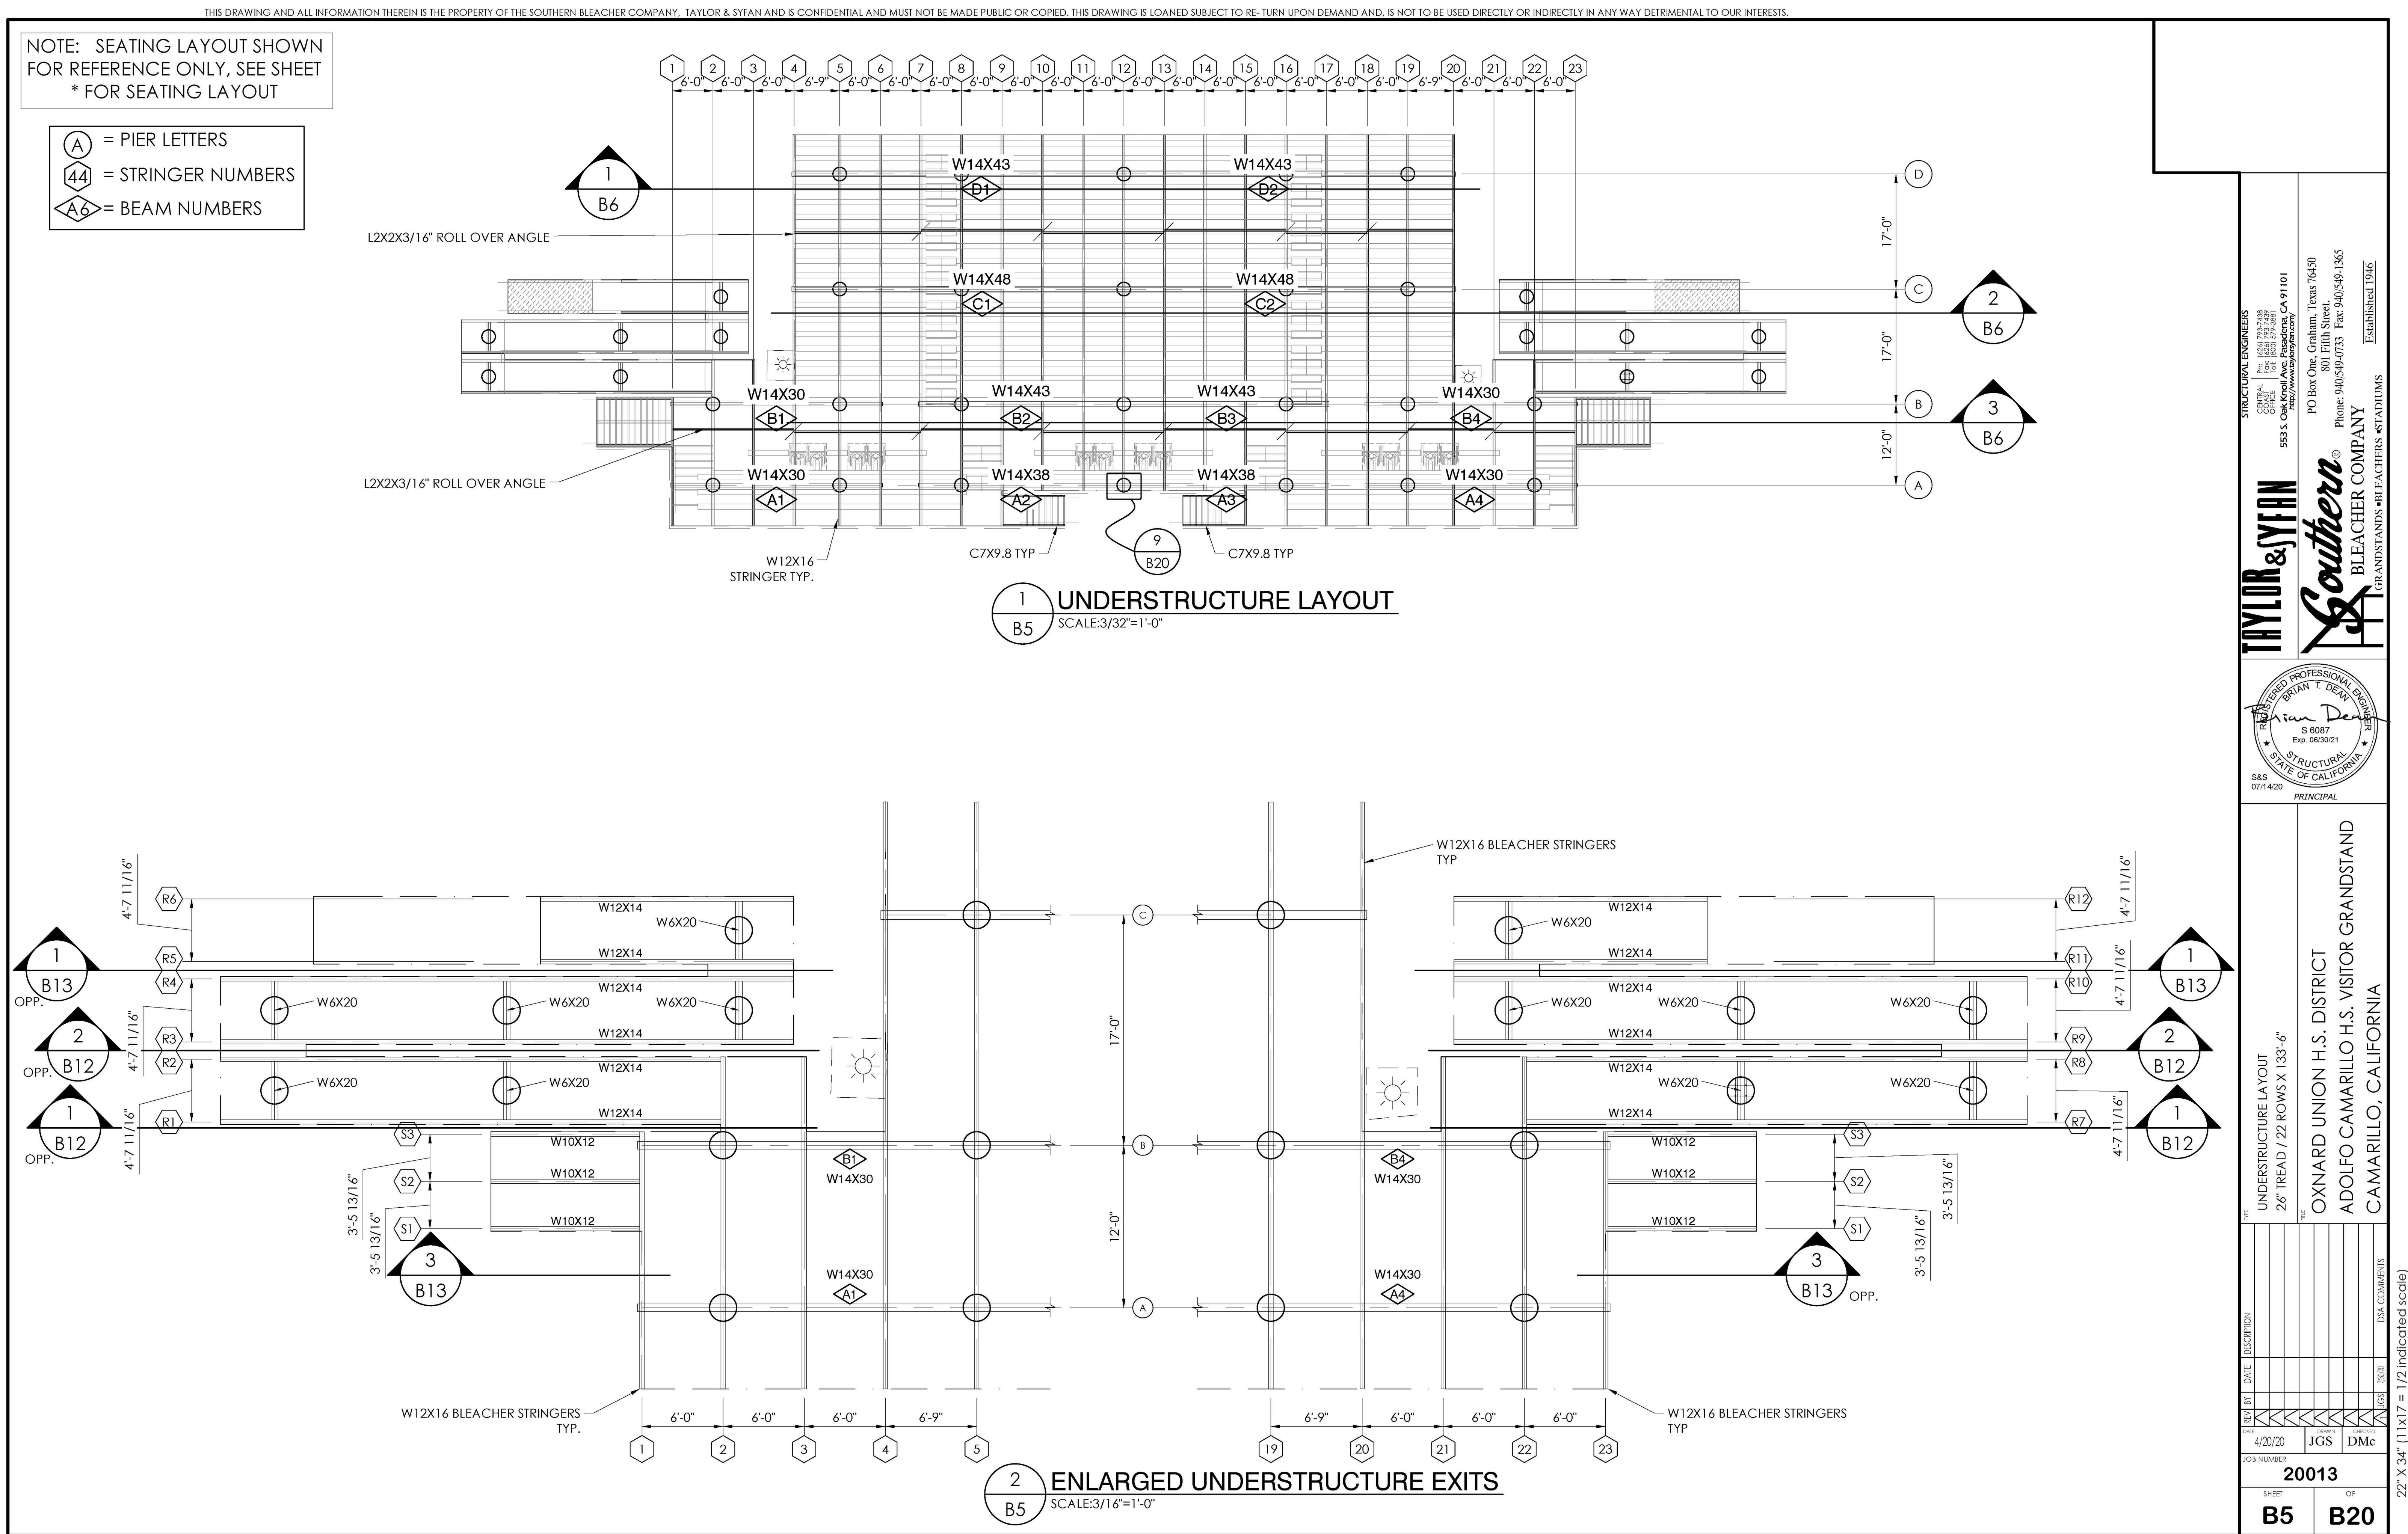

AGENCY REVIEW

IDENTIFICATION STAMP
DIV. OF THE STATE ARCHITECT
APP. 03-120480 INC.
REVIEWED FOR
SS ☐ FLS ☐ ACS ☐
DATE: 07/22/2020

LITTLE

DIVERSIFIED ARCHITECTURAL CONSULTING

1300 Dove Street, Suite 100
Newport Beach, CA, 92660
T: 949.698.1400
www.littleonline.com

This drawing and the design shown are the property of Little Diversified Architectural Consulting. The reproduction, copying or other use of this drawing without their written consent is prohibited and any infringement will be subject to legal action.
© Little 2019

CLIENT NAME

OXNARD UNION HIGH SCHOOL DISTRICT

PROJECT NAME

ADOLFO CAMARILLO HIGH SCHOOL VISITOR BLEACHERS
4660 MISSION OAKS BLVD,
CAMARILLO, CA. 93012

CONSULTANT

TAYLOR & SYFAN
SOUTHERN BLEACHER COMPANY
GRANDSTANDS • BLEACHERS • STADIUMS

SEAL

REGISTERED PROFESSIONAL ENGINEER
BRYAN T. DEAN
S 6087
Exp. 06/30/21
STRUCTURAL
STATE OF CALIFORNIA
07/14/20
PRINCIPAL

ISSUE FOR

DSA SUBMITTAL

ISSUE DATE

07/22/2020

REVISIONS

NO.	REASON	DATE
-----	--------	------

PROJECT TEAM

PRINCIPAL IN CHARGE

PROJECT MANAGER

DESIGN TEAM

PROJECT NAME

ADOLFO CAMARILLO HIGH SCHOOL VISITOR BLEACHERS

PROJECT NO.

6121235309

SHEET TITLE




UNDERSTRUCTURE LAYOUT

SHEET NUMBER

B5

THIS DRAWING AND ALL INFORMATION THEREIN IS THE PROPERTY OF THE SOUTHERN BLEACHER COMPANY. TAYLOR & SYFAN AND IS CONFIDENTIAL AND MUST NOT BE MADE PUBLIC OR COPIED. THIS DRAWING IS LOANED SUBJECT TO RE-TURN UPON DEMAND AND, IS NOT TO BE USED DIRECTLY OR INDIRECTLY IN ANY WAY DETRIMENTAL TO OUR INTERESTS.

A = PIER LETTERS
44 = STRINGER NUMBERS
A6 = BEAM NUMBERS

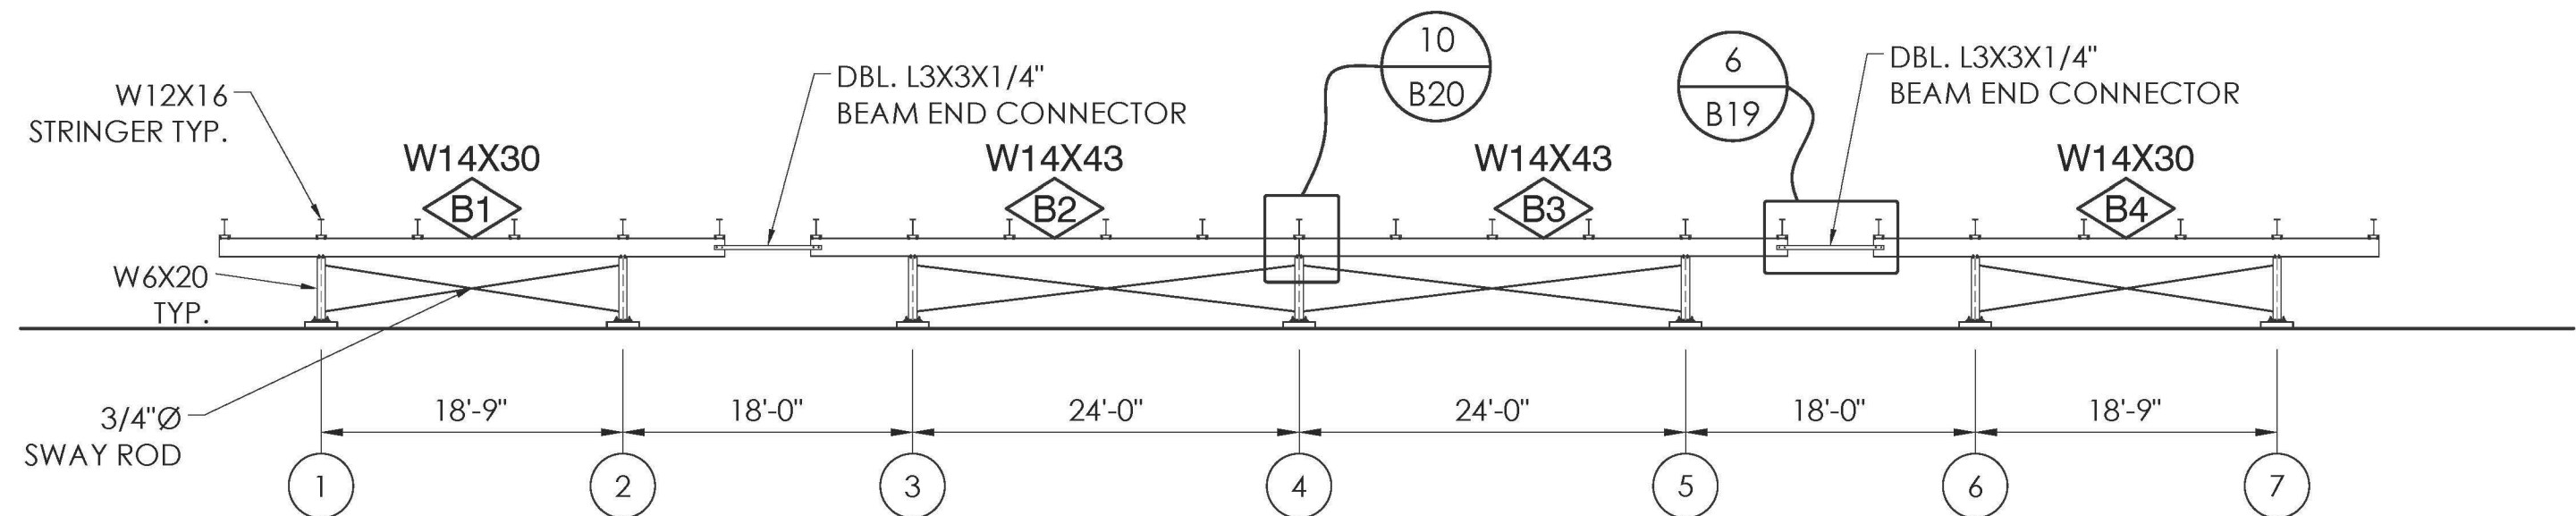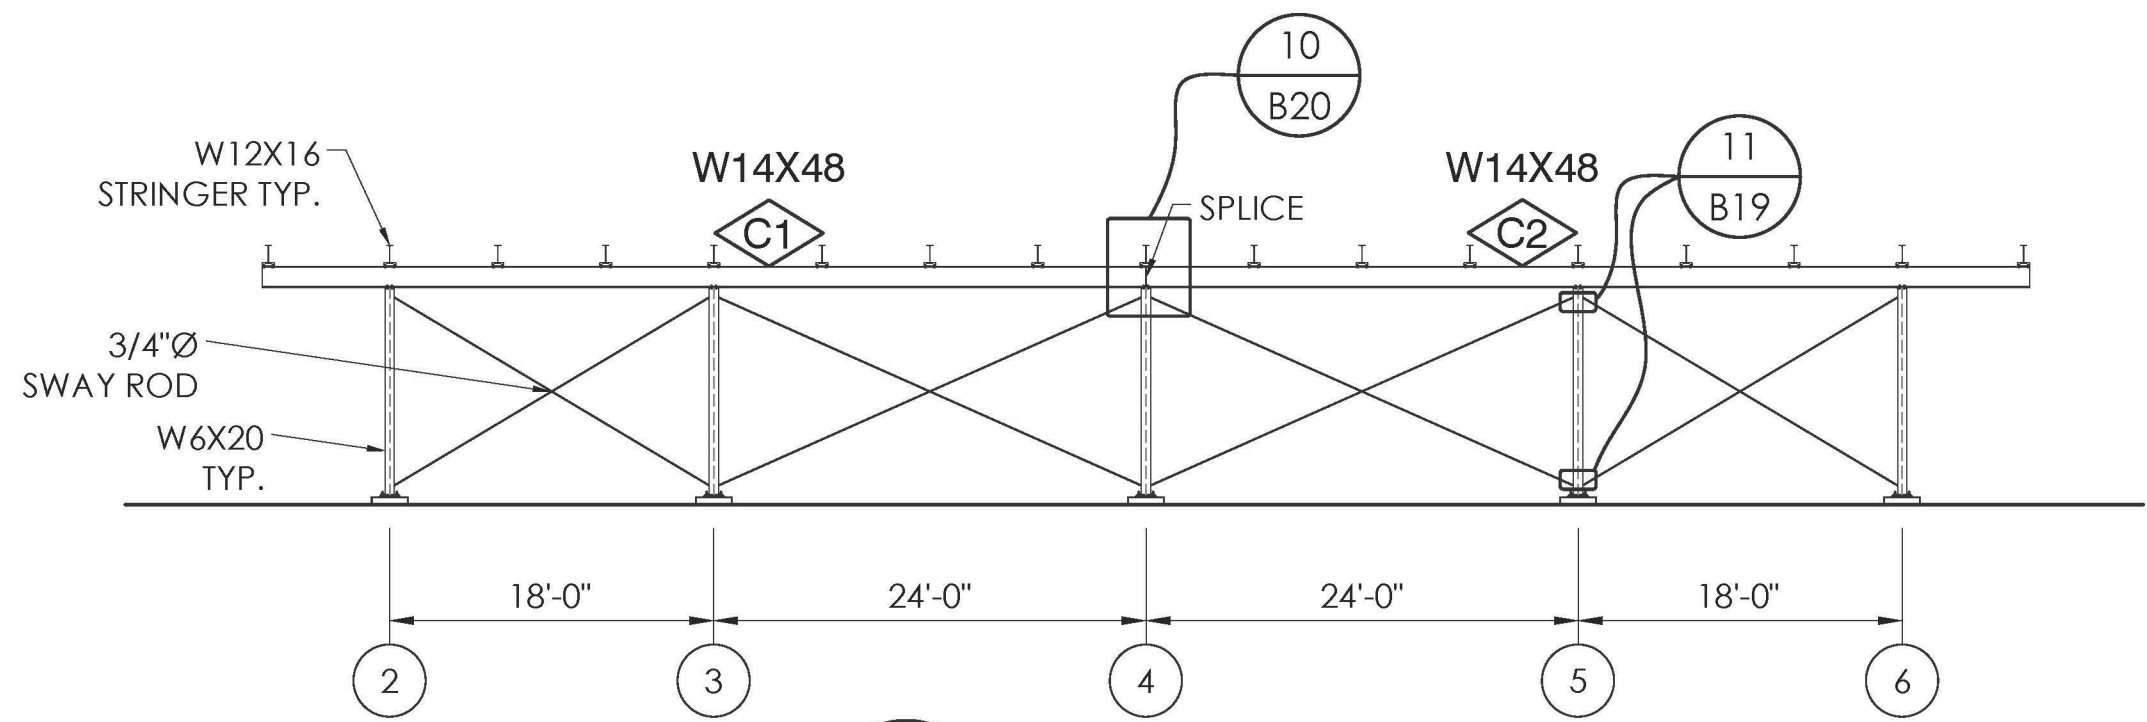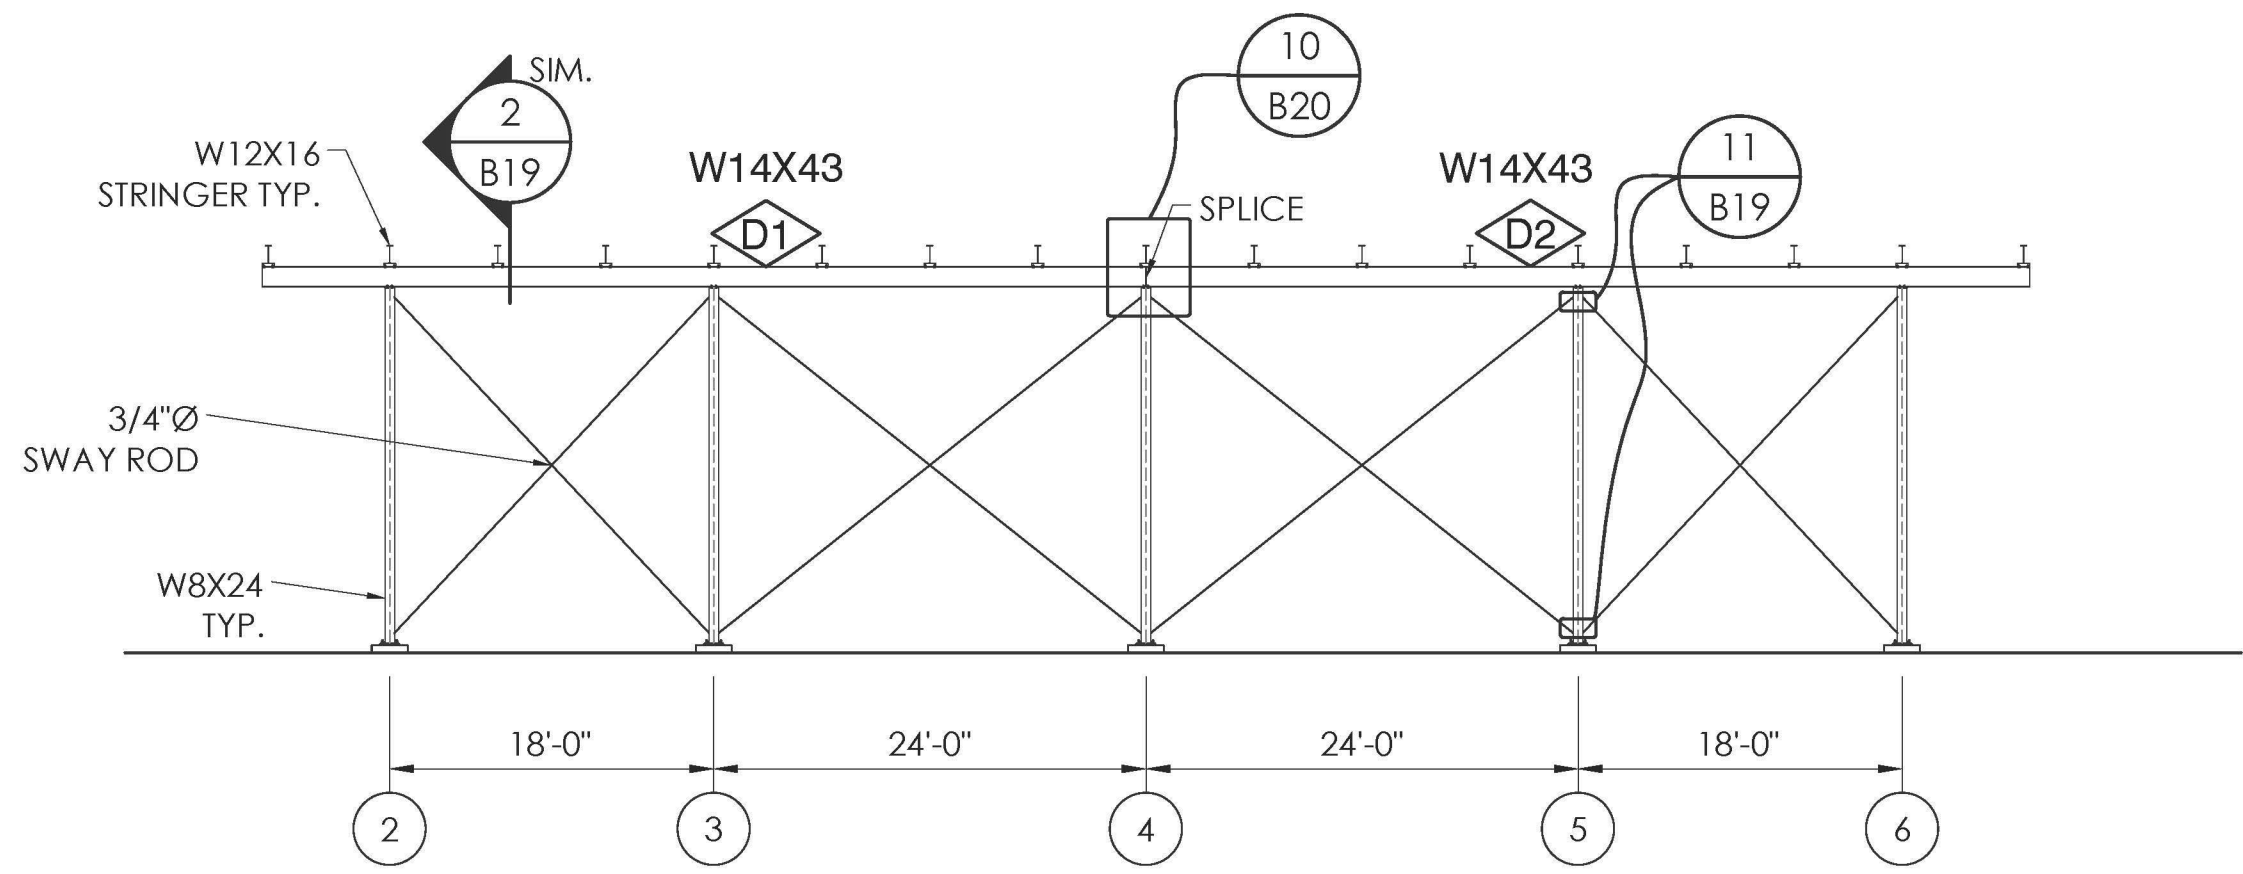

STRUCTURAL ENGINEERS
TAYLOR & SYFAN
555 S. Oak Knoll Ave. Pasadena, CA 91101
Phone: (626) 792-7438
Fax: (626) 792-2881
PO Box One, Camarillo, Texas 76400
801 Fifth Street
Phone: 940/549-0733 Fax: 940/549-1365
Established 1946
GRANDSTANDS • BLEACHERS • STADIUMS

REGISTERED PROFESSIONAL ENGINEER
BRYAN T. DEAN
S 6087
Exp. 06/30/21
STRUCTURAL
STATE OF CALIFORNIA
07/11/20
PRINCIPAL

ELEVATION VIEWS
26 TREAD / 22 ROWS X 133'-6"
OXNARD UNION H.S. DISTRICT
ADOLFO CAMARILLO H.S. VISITOR GRANDSTAND
CAMARILLO, CALIFORNIA

REV	DATE	DESCRIPTION	BY	CHKD
1	4/20/20	JGS	DMc	
2				
3				
4				
100				

20013
B6 B20



AGENCY REVIEW
IDENTIFICATION STAMP
DIV. OF THE STATE ARCHITECT
APP. 03-120480 INC.
REVIEWED FOR
SS ☐ FLS ☐ ACS ☐
DATE: 07/22/2020

LITTLE
DIVERSIFIED ARCHITECTURAL CONSULTING

1300 Dove Street, Suite 100
Newport Beach, CA, 92660
T: 949.698.1400

www.littleonline.com

This drawing and the design shown are the property of Little Diversified Architectural Consulting. The reproduction, copying or other use of this drawing without their written consent is prohibited and any infringement will be subject to legal action.


© Little 2019

OXNARD UNION
HIGH SCHOOL
DISTRICT

ADOLFO CAMARILLO HIGH SCHOOL
VISITOR BLEACHERS
4660 MISSION OAKS BLVD,
CAMARILLO, CA. 93012

CONSULTANT

SEAL

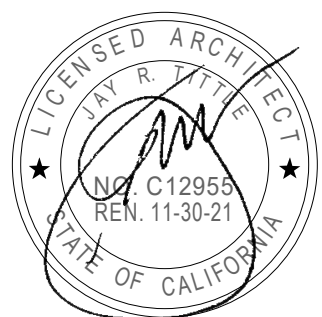

ISSUE FOR
DSA SUBMITTAL

ISSUE DATE
07/22/2020

NO.	REASON	DATE

PROJECT TEAM

PRINCIPAL IN CHARGE

PROJECT MANAGER

DESIGN TEAM

PROJECT NAME

ADOLFO CAMARILLO HIGH
SCHOOL VISITOR
BLEACHERS

PROJECT NO.

6121235309

SHEET TITLE

ELEVATION VIEWS

SHEET NUMBER

B6


OXNARD UNION
HIGH SCHOOL
DISTRICT

PROJECT NAME

OCAMARILLO HIGH SCHOOL
VISITOR BLEACHERS

**4660 MISSION OAKS BLVD,
CAMARILLO, CA. 93012**

CONSULTANT

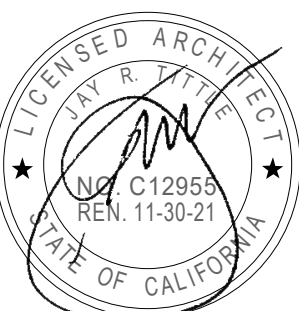

ISSUE FOR
DSA SUBMITTAL

ISSUE DATE
07/22/2020

REVISIONS		
NO.	REASON	DATE

PROJECT TEAM
PRINCIPAL IN CHARGE

PROJECT MANAGER

DESIGN TEAM

PROJECT NAME

ADOLFO CAMARILLO HIGH
SCHOOL VISITOR
BLEACHERS


PROJECT NO.

6121235309


SECTION VIEW

SHEET NUMBER

B7

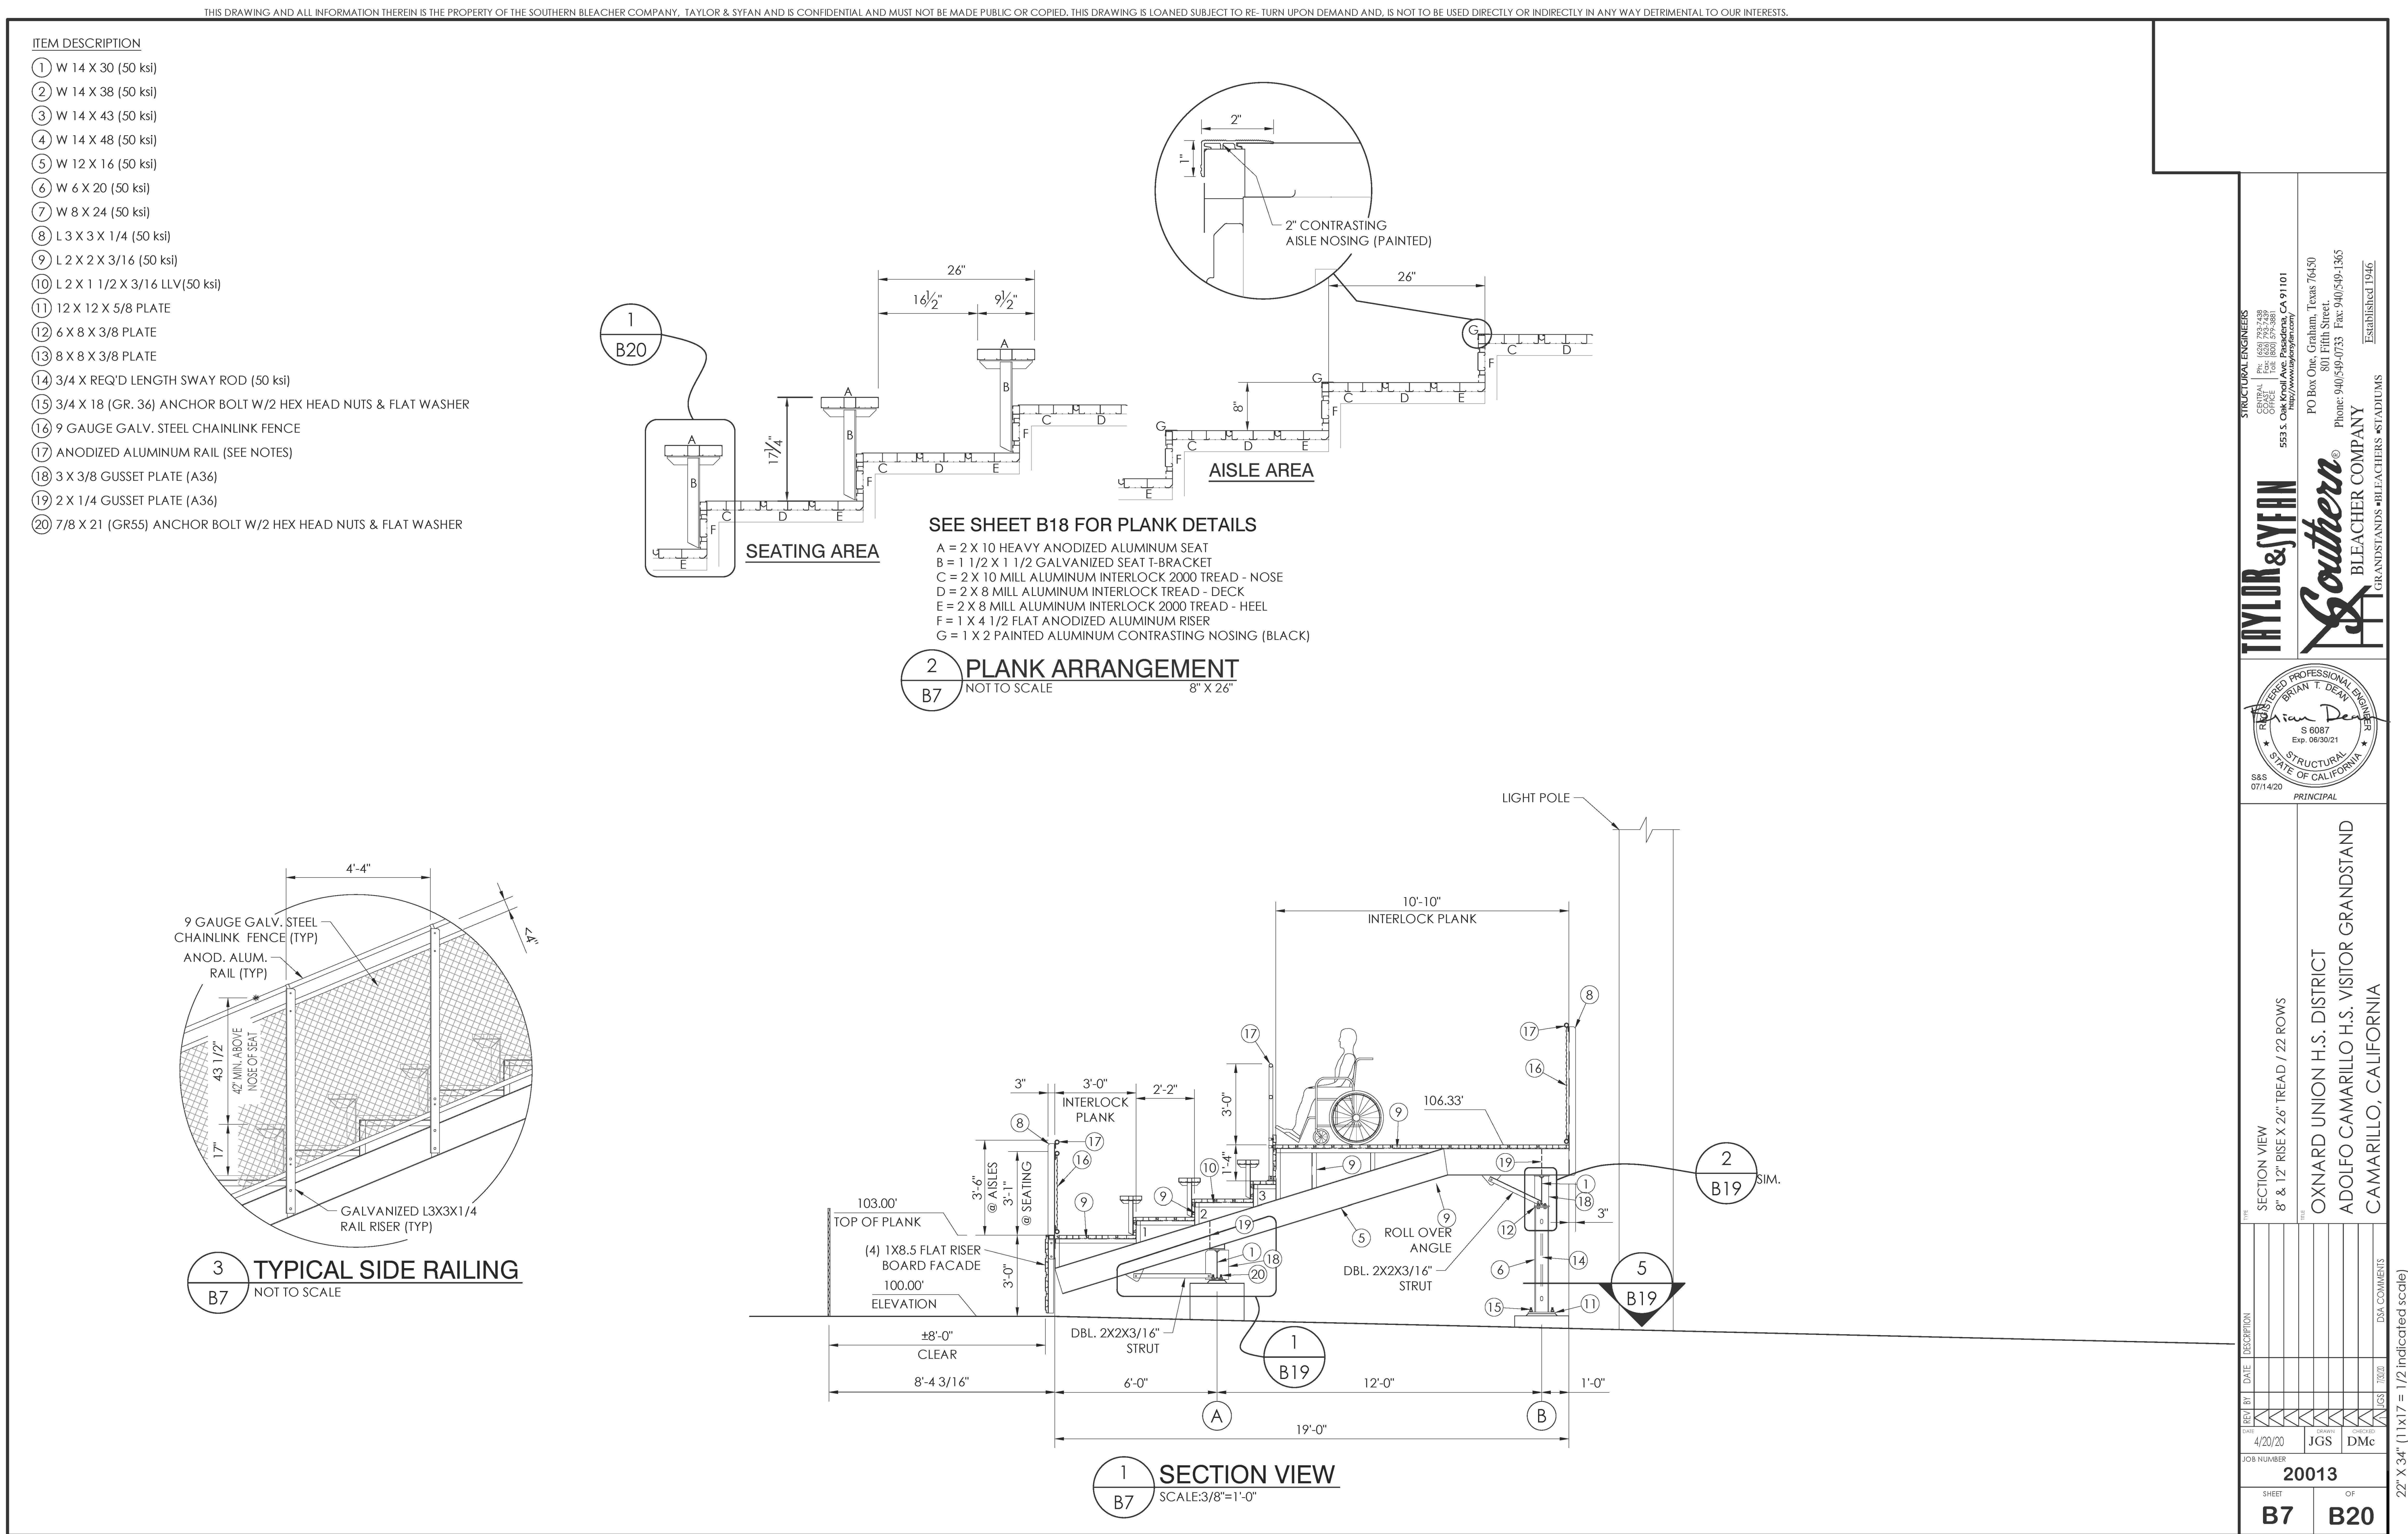

THIS DRAWING AND ALL INFORMATION THEREIN IS THE PROPERTY OF THE SOUTHERN BLEACHER COMPANY. TAYLOR & SYFAN AND IS CONFIDENTIAL AND MUST NOT BE MADE PUBLIC OR COPIED. THIS DRAWING IS LOANED SUBJECT TO RE-TURN UPON DEMAND AND, IS NOT TO BE USED DIRECTLY OR INDIRECTLY IN ANY WAY DETRIMENTAL TO OUR INTERESTS.

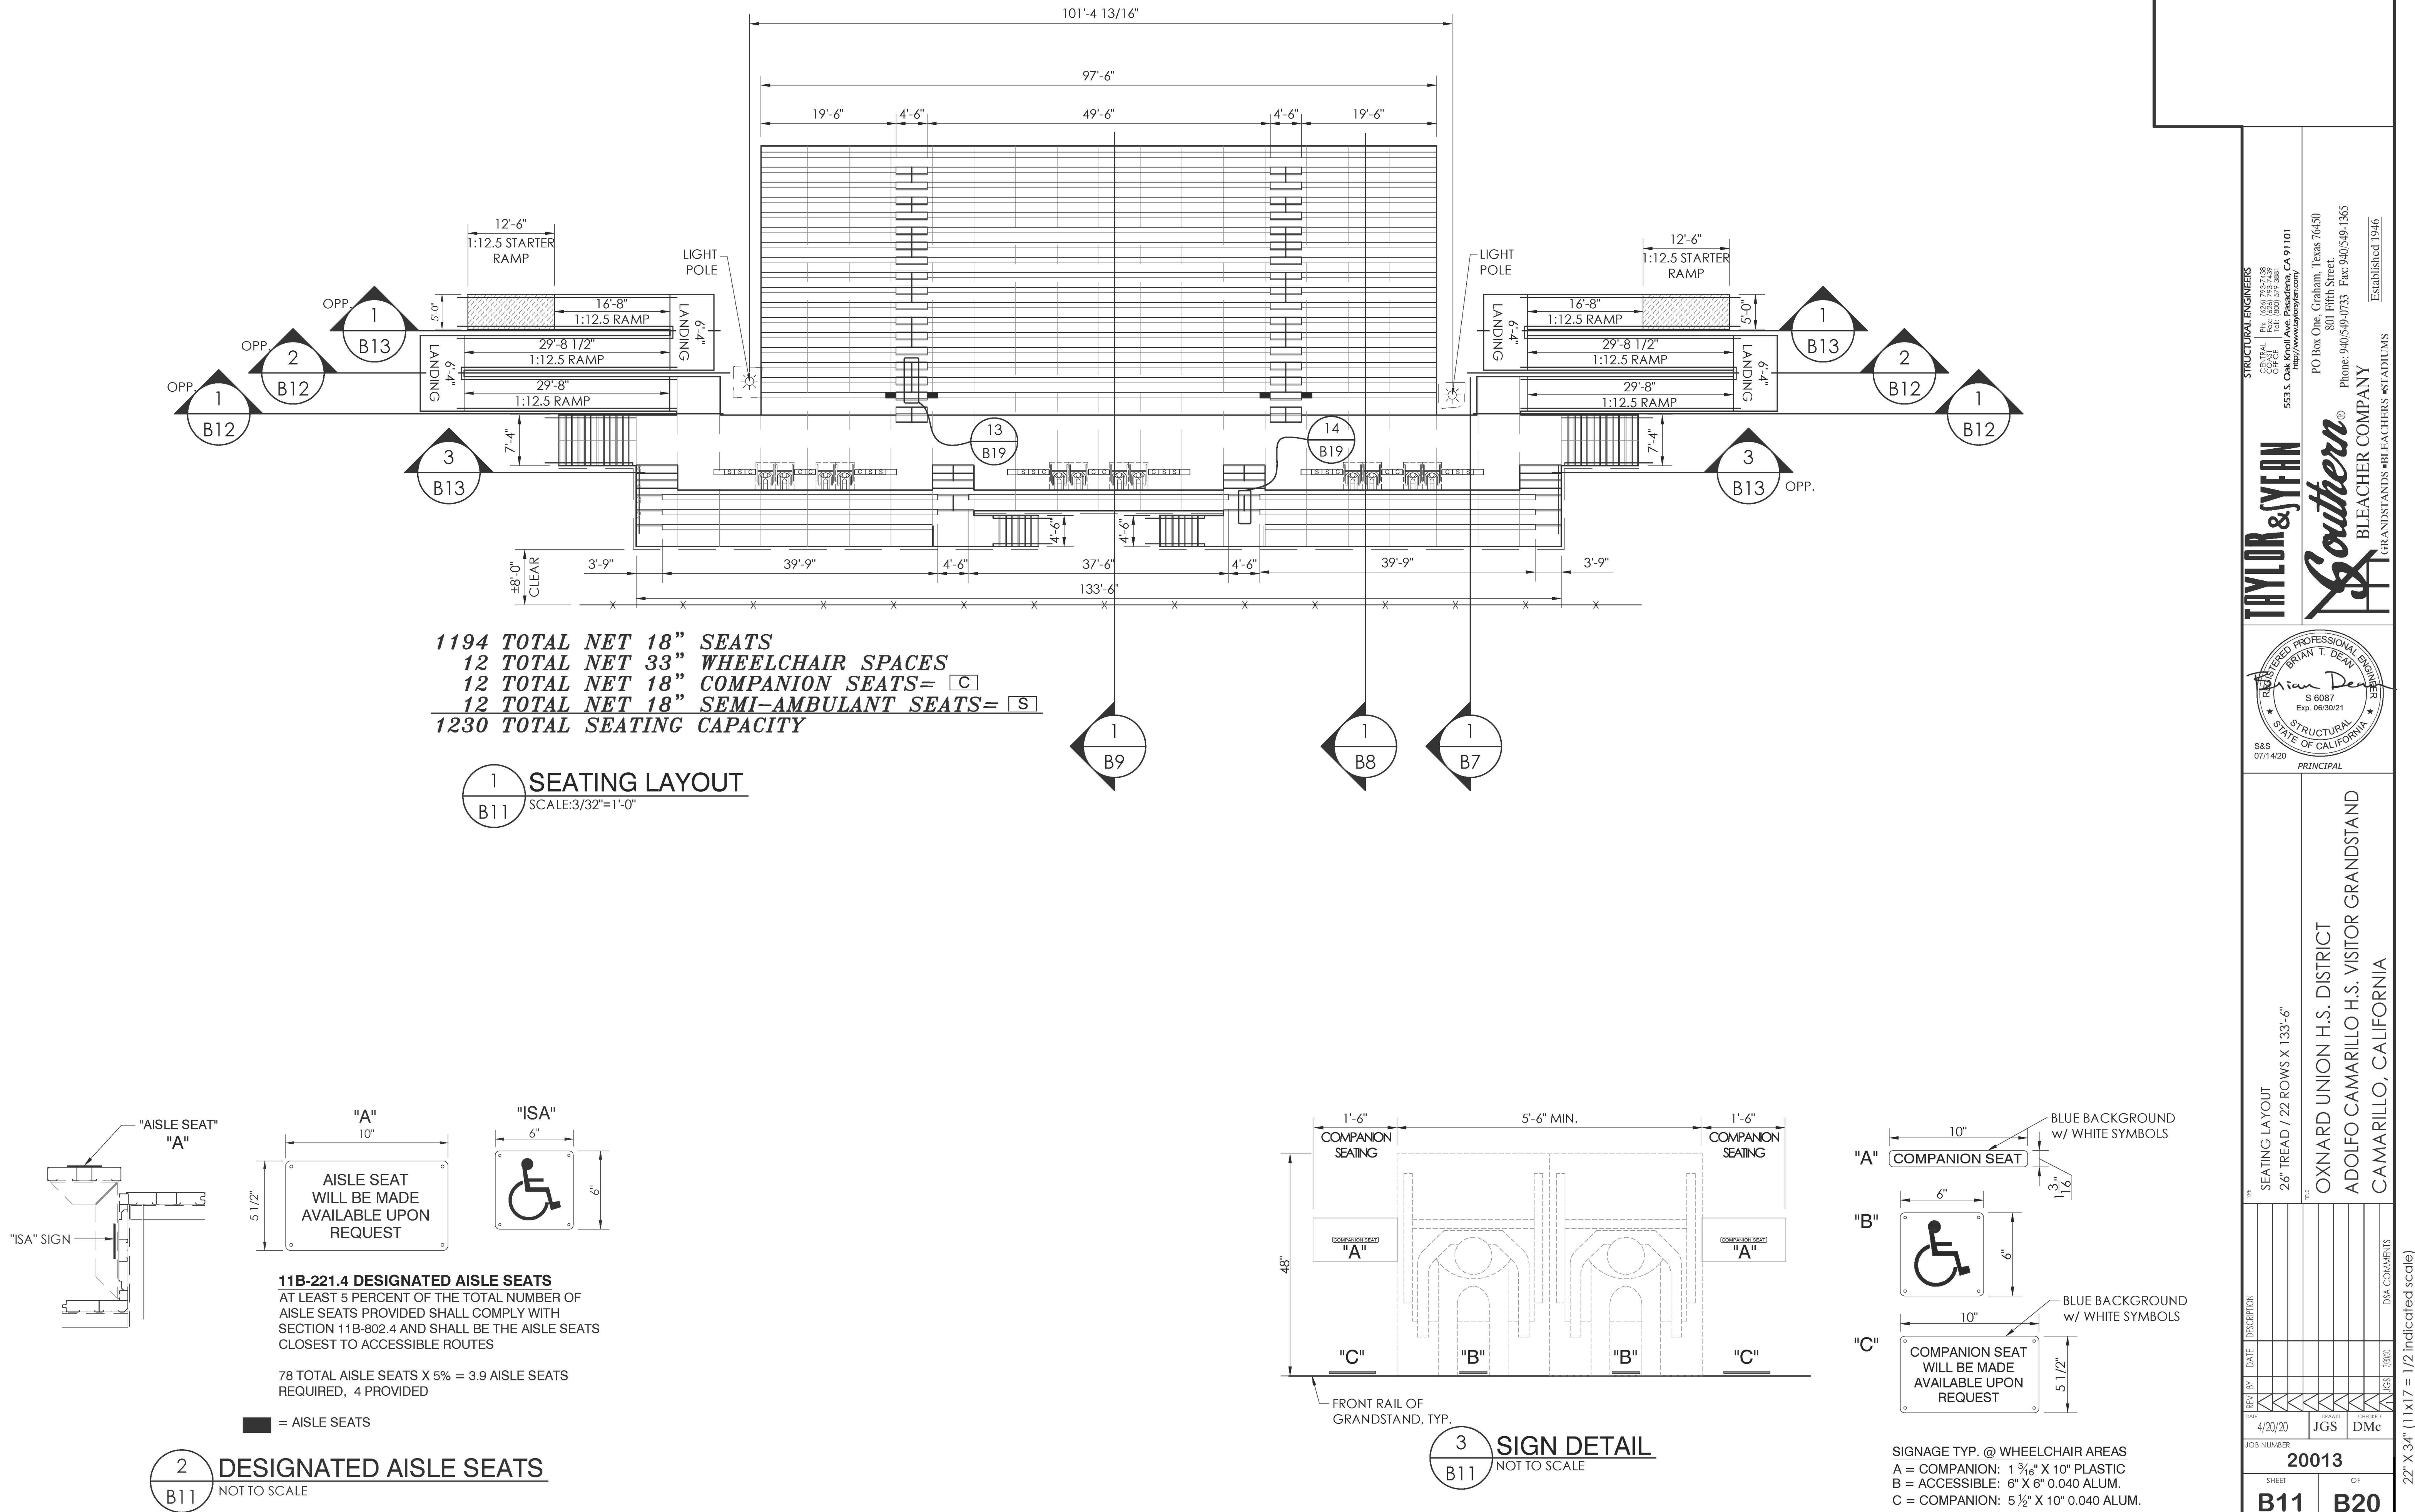

AGENCY REVIEW

IDENTIFICATION STAMP
DIV. OF THE STATE ARCHITECT
APP. 03-120480 INC.
REVIEWED FOR
SS ☐ FLS ☐ ACS ☐
DATE: 07/22/2020

LITTLE
DIVERSIFIED ARCHITECTURAL CONSULTING

1300 Dove Street, Suite 100
Newport Beach, CA, 92660
T: 949.698.1400

www.littleonline.com

This drawing and the design shown are the property of Little Diversified Architectural Consulting. The reproduction, copying or other use of this drawing without their written consent is prohibited and any infringement will be subject to legal action.

© Little 2019

CLIENT NAME

OXNARD UNION
HIGH SCHOOL
DISTRICT


PROJECT NAME

ADOLFO CAMARILLO HIGH SCHOOL
VISITOR BLEACHERS

4660 MISSION OAKS BLVD,
CAMARILLO, CA. 93012

CONSULTANT

SEAL

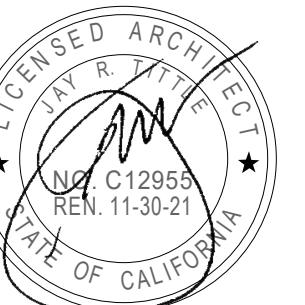

ISSUE FOR

DSA SUBMITTAL

ISSUE DATE

07/22/2020

REVISIONS

NO. REASON DATE

PROJECT TEAM

PRINCIPAL IN CHARGE

PROJECT MANAGER

DESIGN TEAM

PROJECT NAME

ADOLFO CAMARILLO HIGH
SCHOOL VISITOR
BLEACHERS

PROJECT NO.

6121235309


SHEET TITLE

SEATING LAYOUT


SHEET NUMBER

B11

THIS DRAWING AND ALL INFORMATION THEREIN IS THE PROPERTY OF THE SOUTHERN BLEACHER COMPANY, TAYLOR & SYFAN AND IS CONFIDENTIAL AND MUST NOT BE MADE PUBLIC OR COPIED. THIS DRAWING IS LOANED SUBJECT TO RE- TURN UPON DEMAND AND, IS NOT TO BE USED DIRECTLY OR INDIRECTLY IN ANY WAY DETRIMENTAL TO OUR INTERESTS.

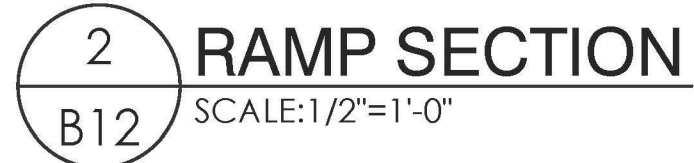[illegible]

B13

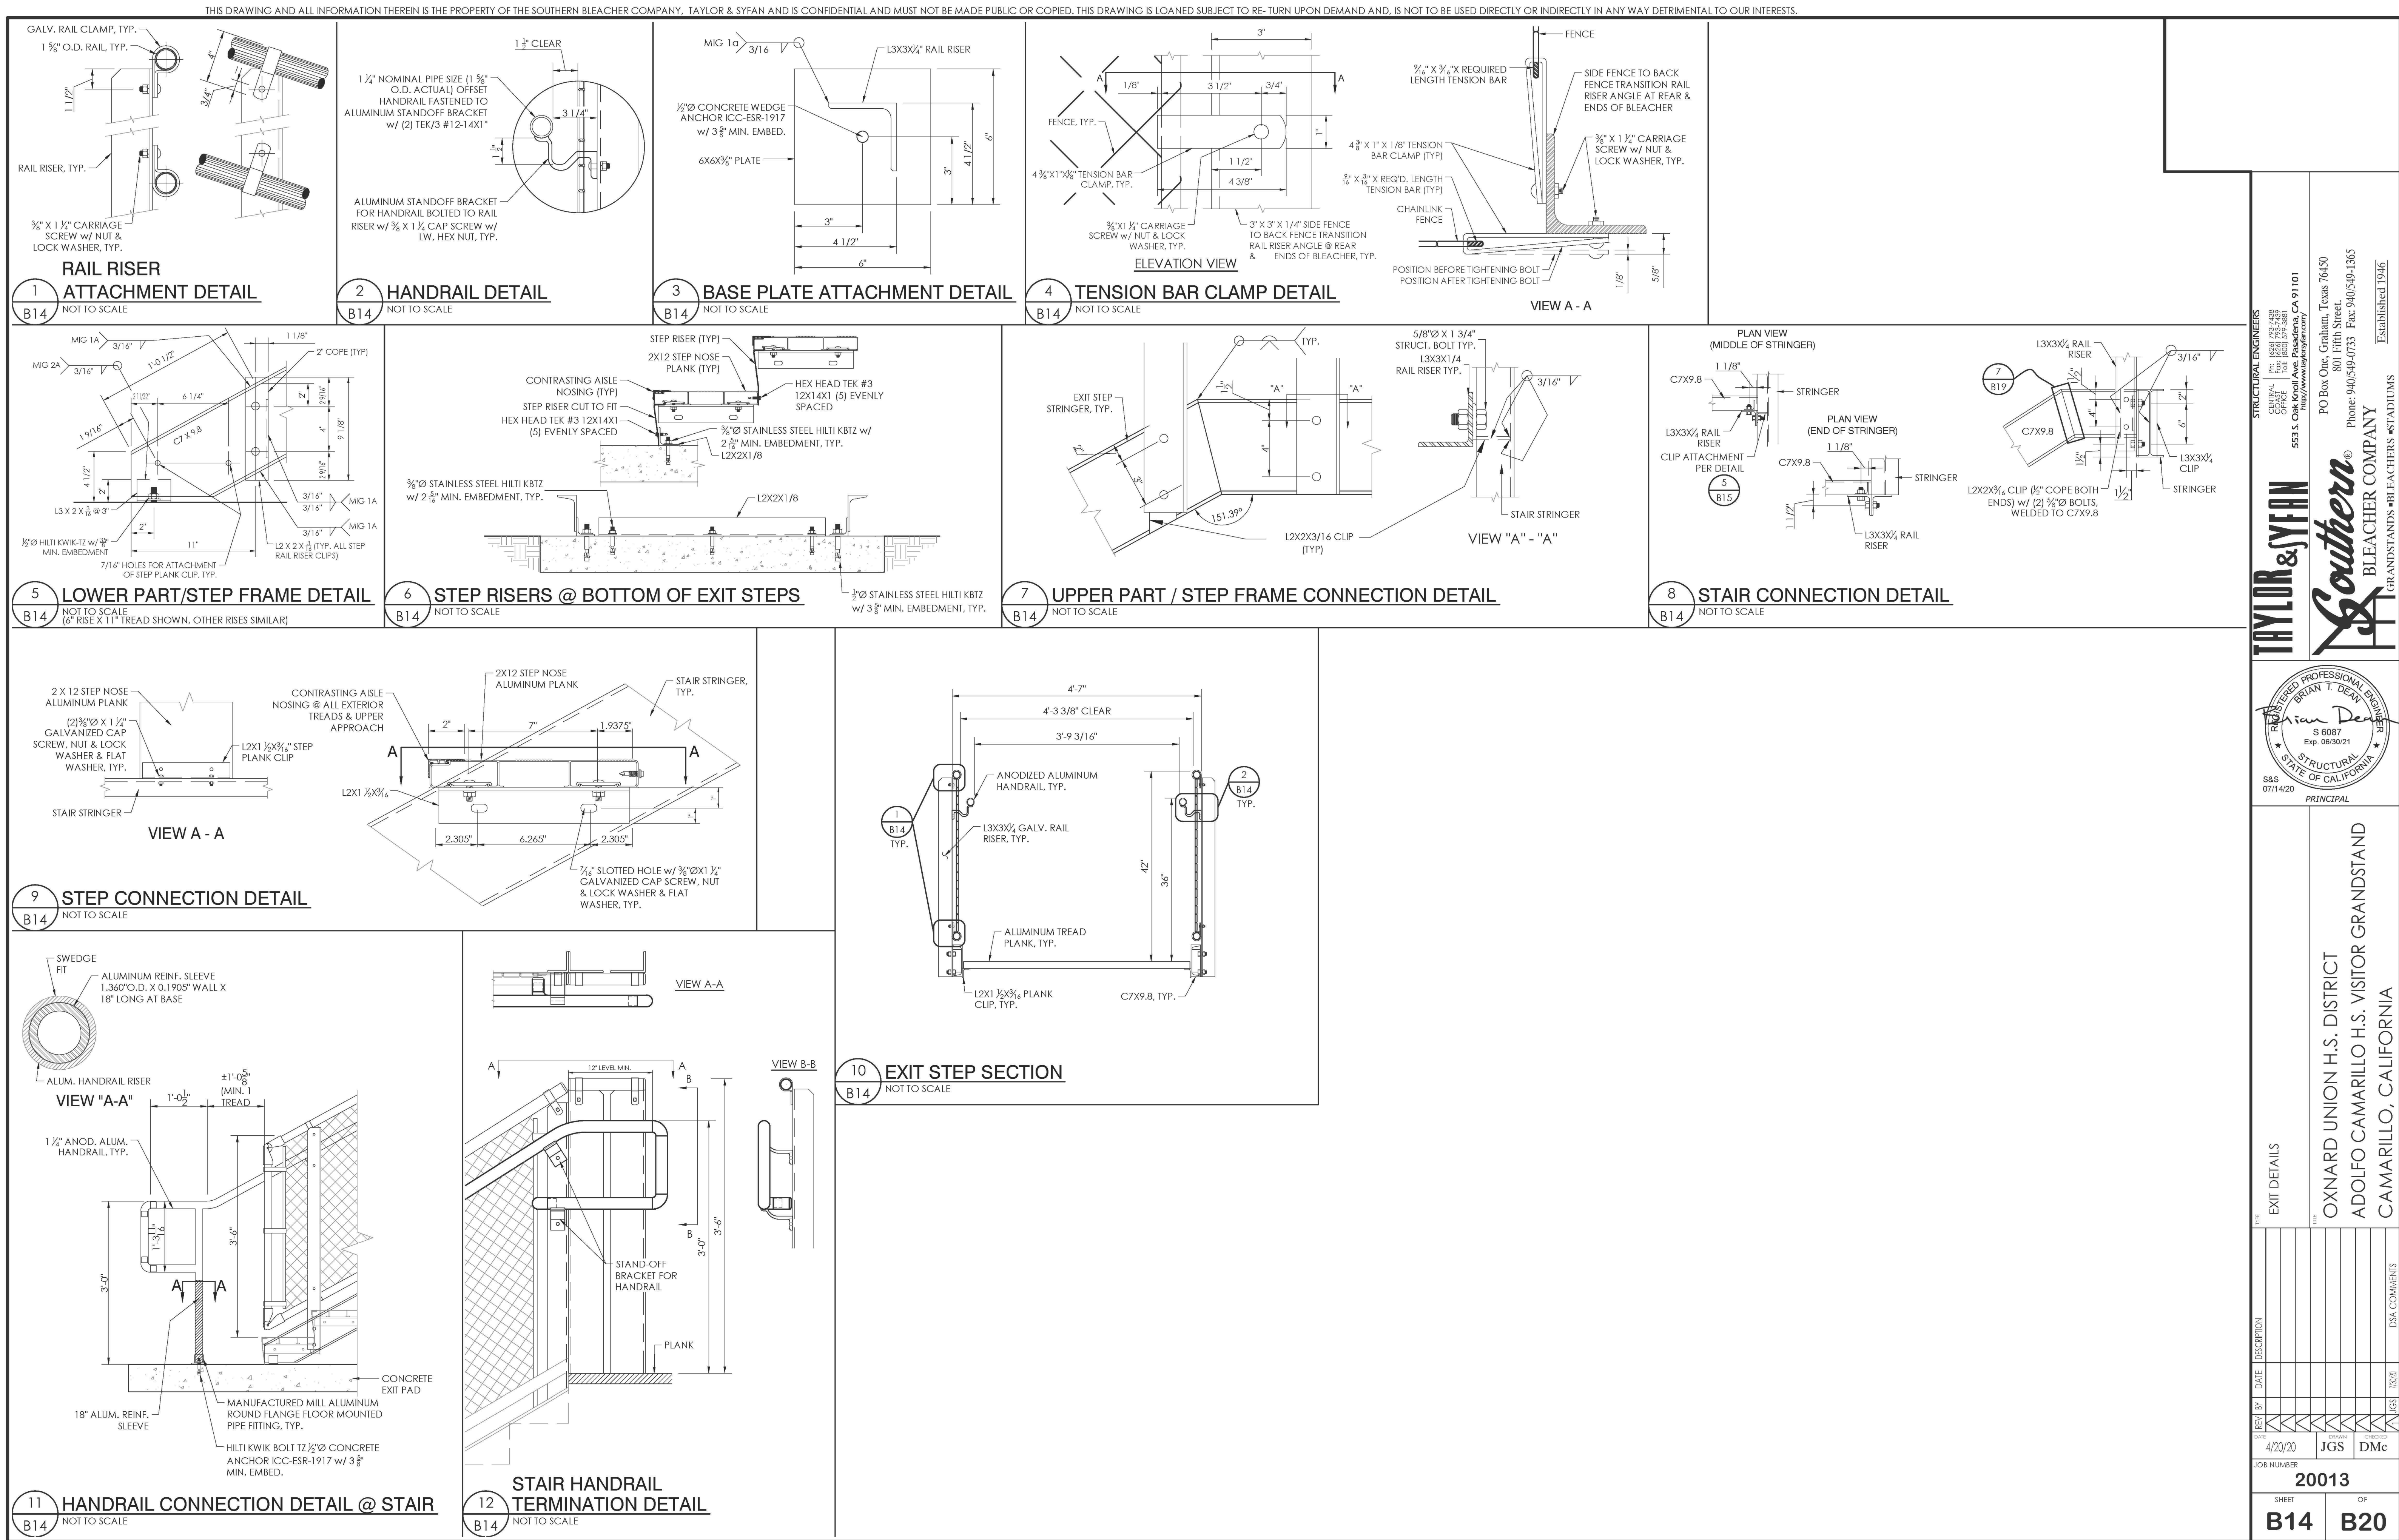

AGENCY REVIEW

IDENTIFICATION STAMP
DIV. OF THE STATE ARCHITECT
APP. 03-120480 INC.
REVIEWED FOR
SS ☒ FLS ☒ ACS ☒
DATE: 07/22/2020

LITTLE
DIVERSIFIED ARCHITECTURAL CONSULTING

1300 Dove Street, Suite 100
Newport Beach, CA, 92660
T: 949.698.1400

www.littleonline.com

This drawing and the design shown are the property of Little Diversified Architectural Consulting. The reproduction, copying or other use of this drawing without their written consent is prohibited and any infringement will be subject to legal action.

© Little 2019

CLIENT NAME

**OXNARD UNION
HIGH SCHOOL
DISTRICT**


PROJECT NAME

**ADOLFO CAMARILLO HIGH SCHOOL
VISITOR BLEACHERS**

**4660 MISSION OAKS BLVD.,
CAMARILLO, CA. 93012**

CONSULTANT

SEAL

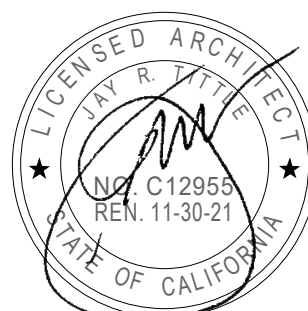

ISSUE FOR
DSA SUBMITTAL

ISSUE DATE
07/22/2020

REVISIONS	NO.	REASON	DATE

PROJECT TEAM

PRINCIPAL IN CHARGE

PROJECT MANAGER

DESIGN TEAM

PROJECT NAME

**ADOLFO CAMARILLO HIGH
SCHOOL VISITOR
BLEACHERS**

PROJECT NO.


6121235309

SHEET TITLE

EXIT DETAILS

SHEET NUMBER

B14

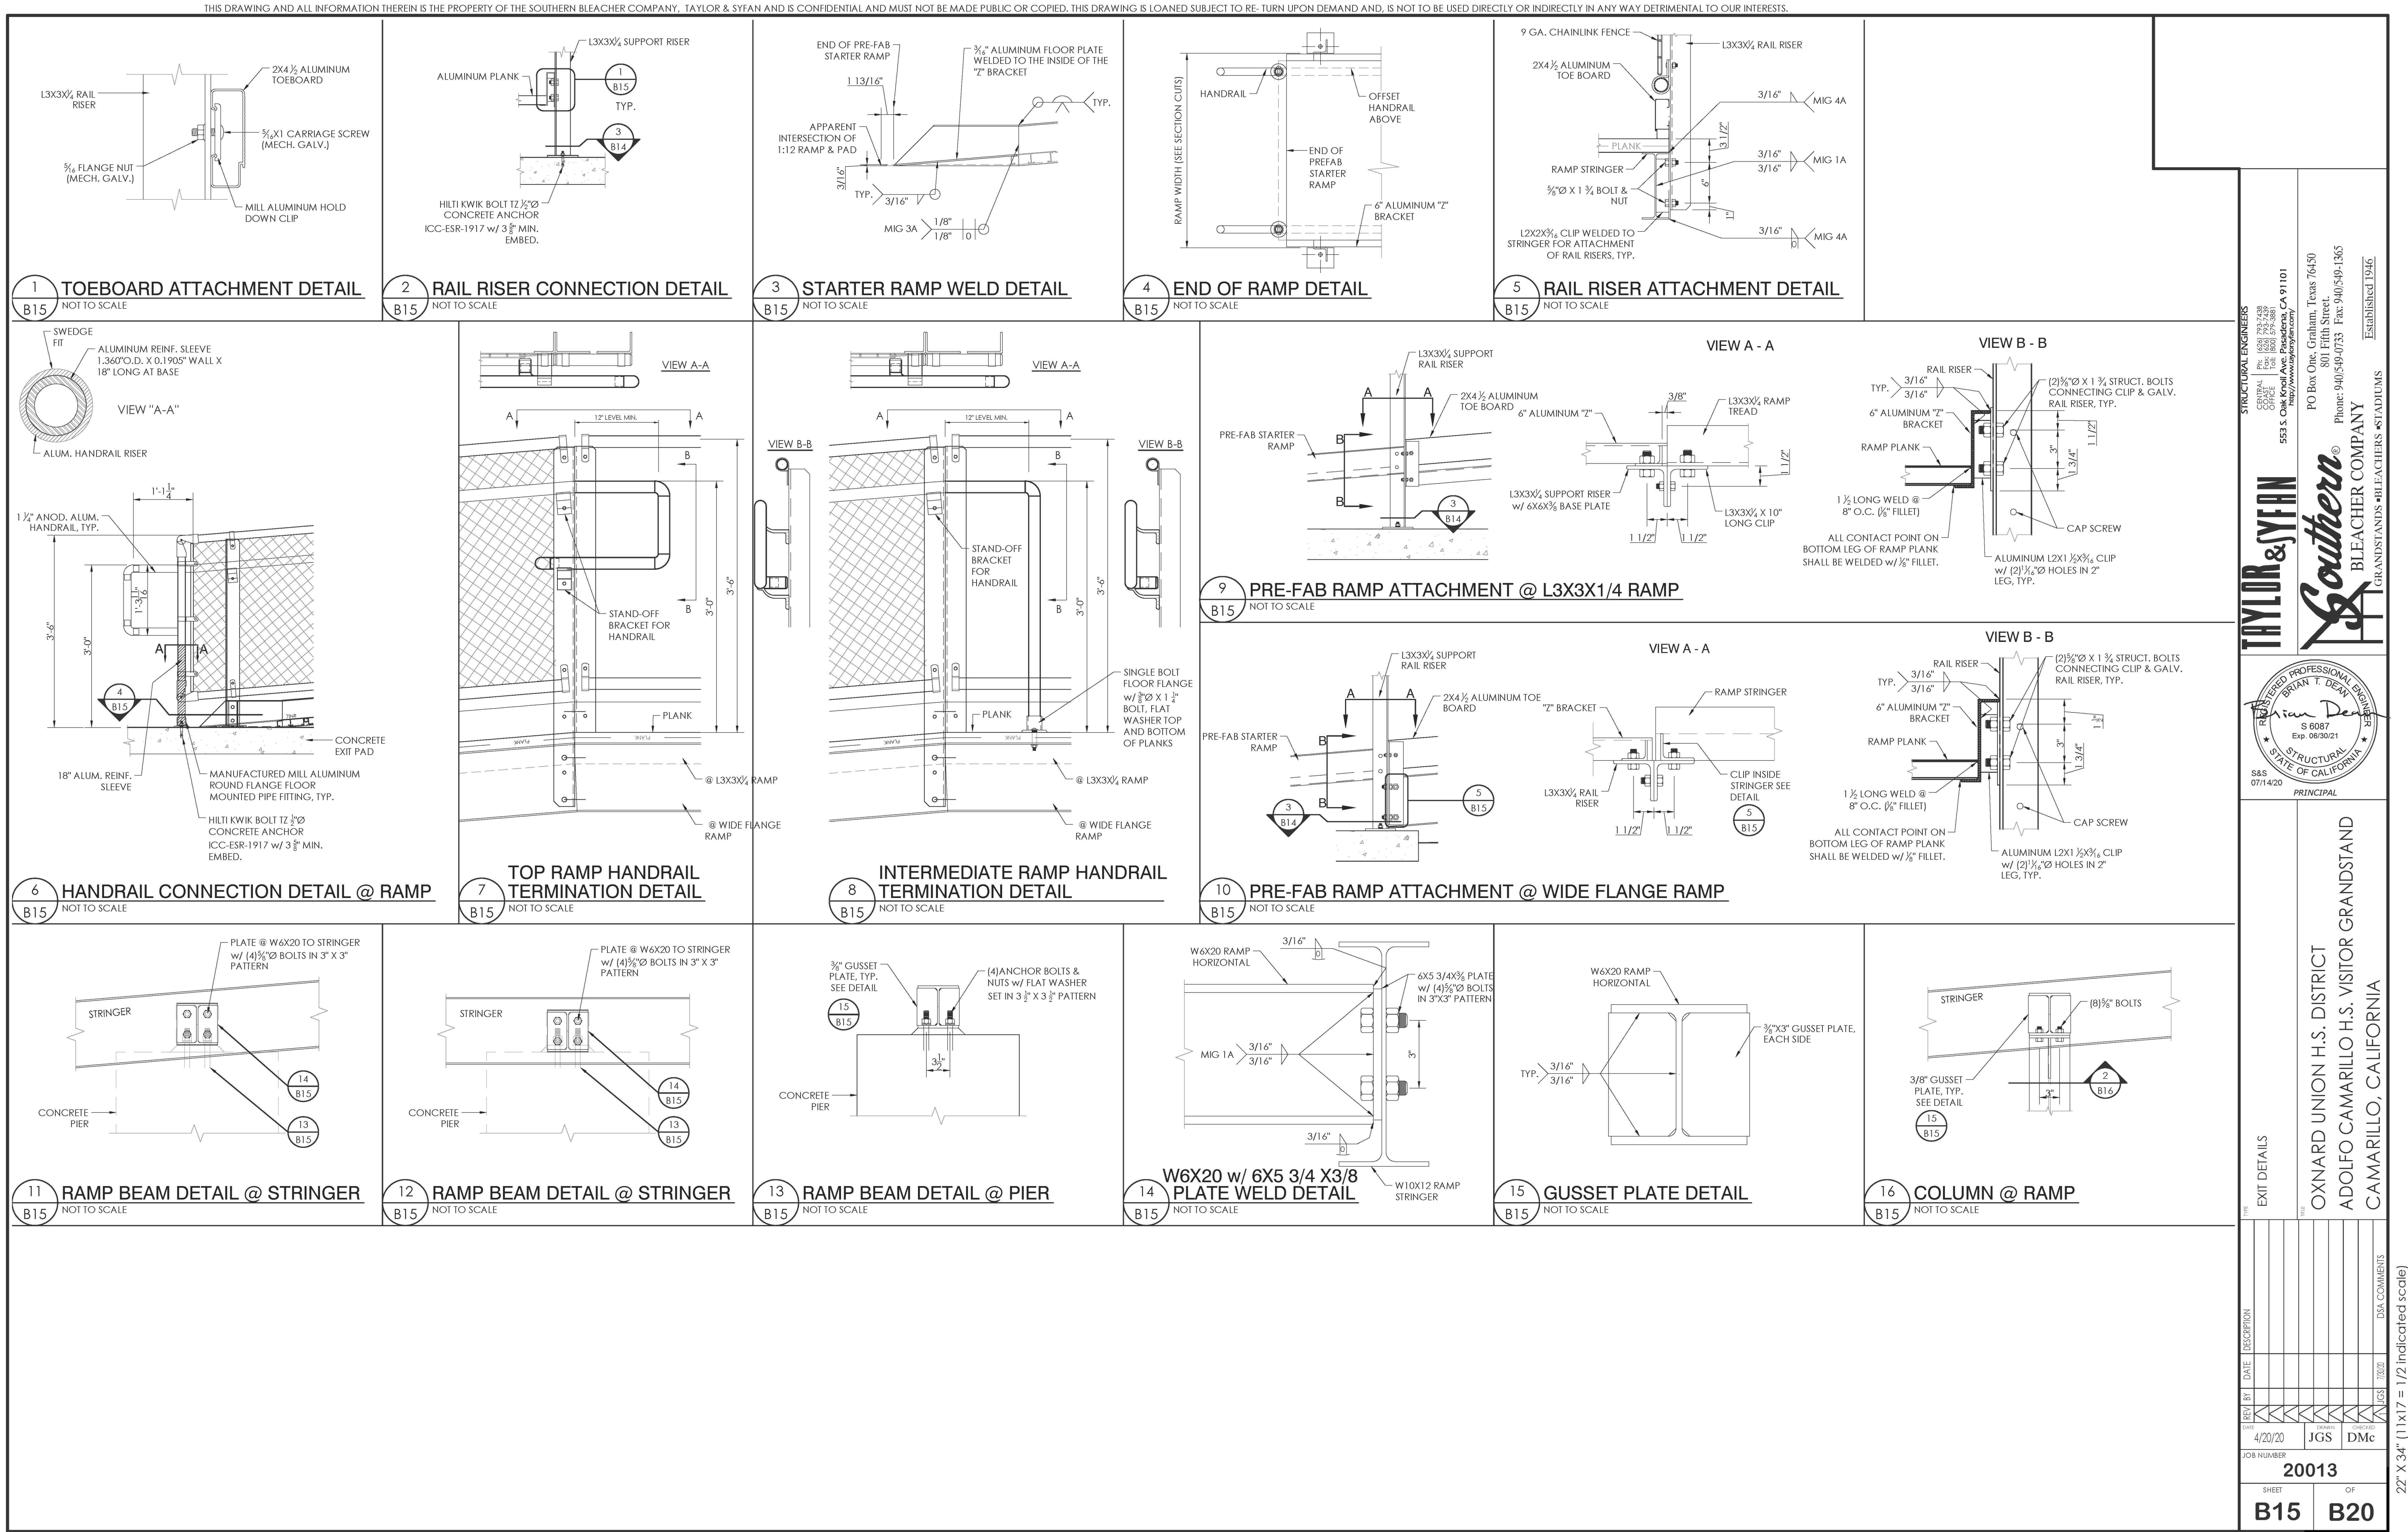

AGENCY REVIEW

IDENTIFICATION STAMP
DIV. OF THE STATE ARCHITECT
APP. 03-120480 INC.
REVIEWED FOR
SS ☒ FLS ☒ ACS ☒
DATE: 07/22/2020

LITTLE

DIVERSIFIED ARCHITECTURAL CONSULTING

1300 Dove Street, Suite 100
Newport Beach, CA, 92660
T: 949.698.1400

www.littleonline.com

This drawing and the design shown are the property of Little Diversified Architectural Consulting. The reproduction, copying or other use of this drawing without their written consent is prohibited and any infringement will be subject to legal action.

© Little 2019

CLIENT NAME

OXNARD UNION HIGH SCHOOL DISTRICT

PROJECT NAME

ADOLFO CAMARILLO HIGH SCHOOL VISITOR BLEACHERS

4660 MISSION OAKS BLVD.,
CAMARILLO, CA. 93012

STRUCTURAL ENGINEERS

TAYLOR & SYFAN

553 S. Oak Road Ave. Pasadena, CA 91101
Tel: (626) 793-7438
Fax: (626) 793-3881

PO Box 904, Camarillo, Texas 76450
800 Fifth Street
Phone: 940/549-0733 Fax: 940/549-1365

ESTABLISHED 1946

GRANDSTANDS • BLEACHERS • STADIUMS

REGISTERED PROFESSIONAL ENGINEER
BRYAN T. DEAN
S 6087
Exp. 06/30/21
STRUCTURAL
STATE OF CALIFORNIA
88-6
07/14/20
PRINCIPAL

OXNARD UNION H.S. DISTRICT
ADOLFO CAMARILLO H.S. VISITOR GRANDSTAND
CAMARILLO, CALIFORNIA

ISSUE FOR

DSA SUBMITTAL

ISSUE DATE

07/22/2020

REVISIONS

NO. REASON DATE

PROJECT TEAM

PRINCIPAL IN CHARGE

PROJECT MANAGER

DESIGN TEAM

PROJECT NAME

ADOLFO CAMARILLO HIGH SCHOOL VISITOR BLEACHERS

PROJECT NO.


6121235309

SHEET TITLE


EXIT DETAILS

SHEET NUMBER

B15

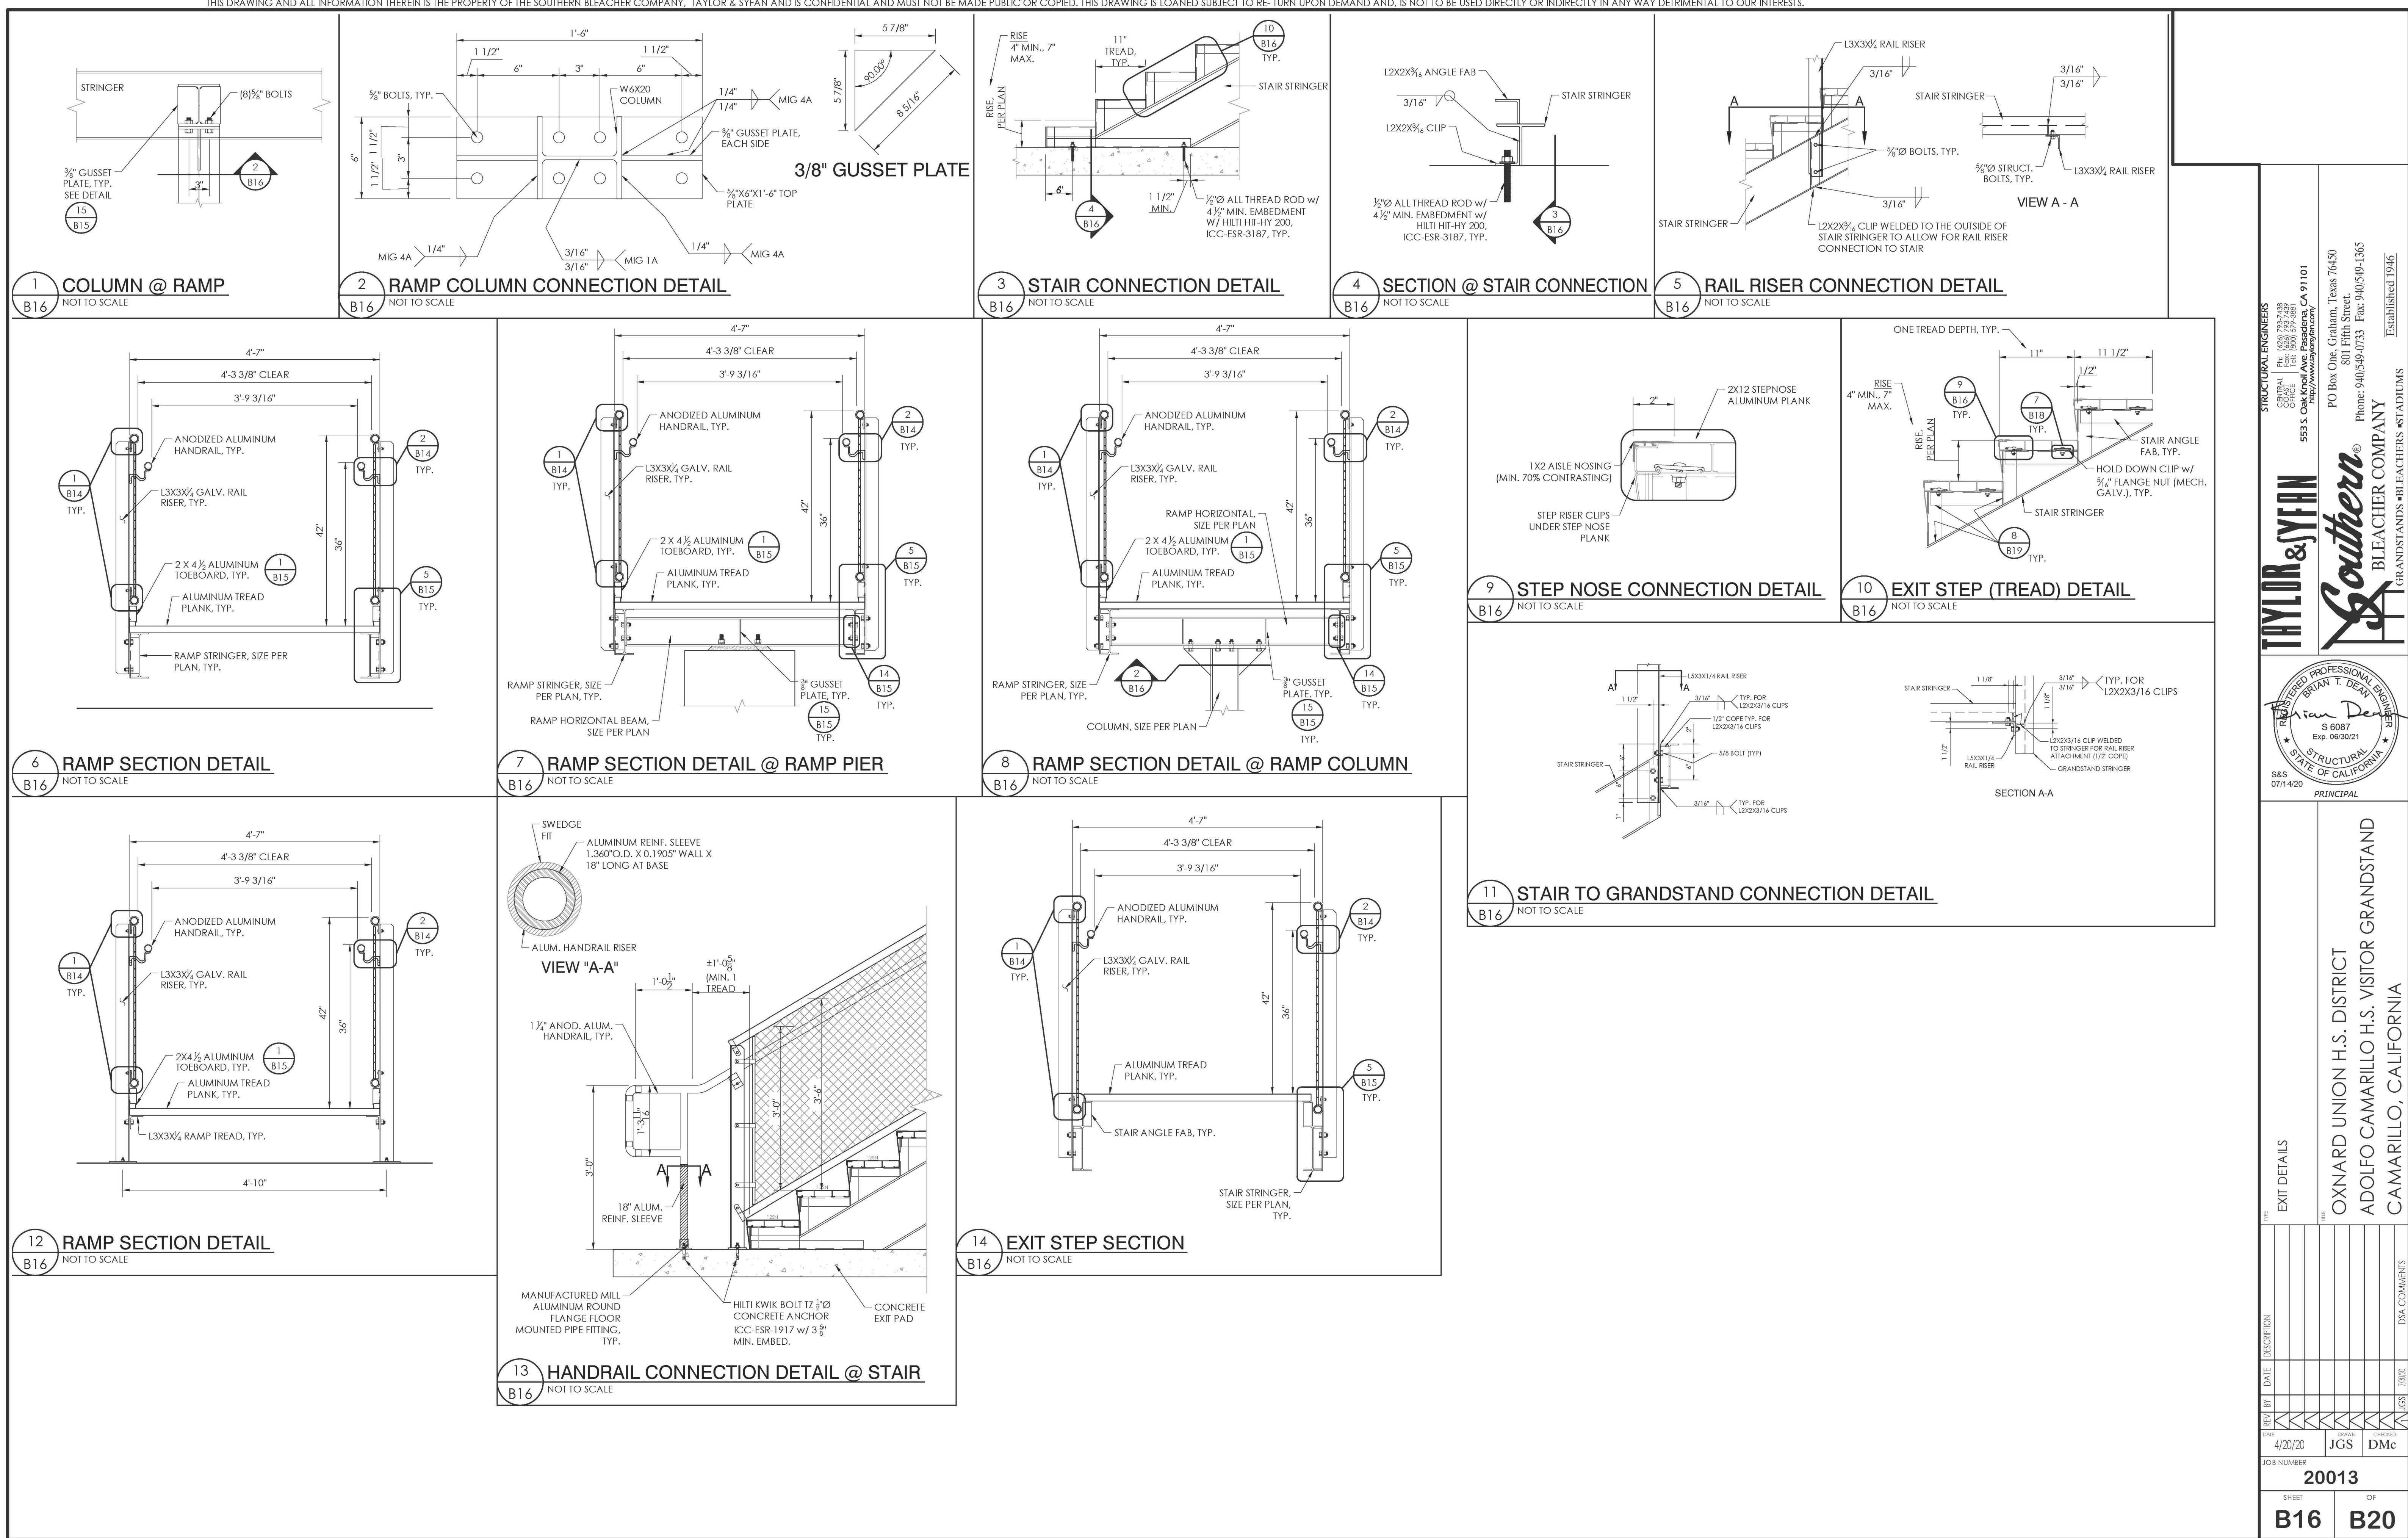

REVISIONS	NO.	REASON	DATE

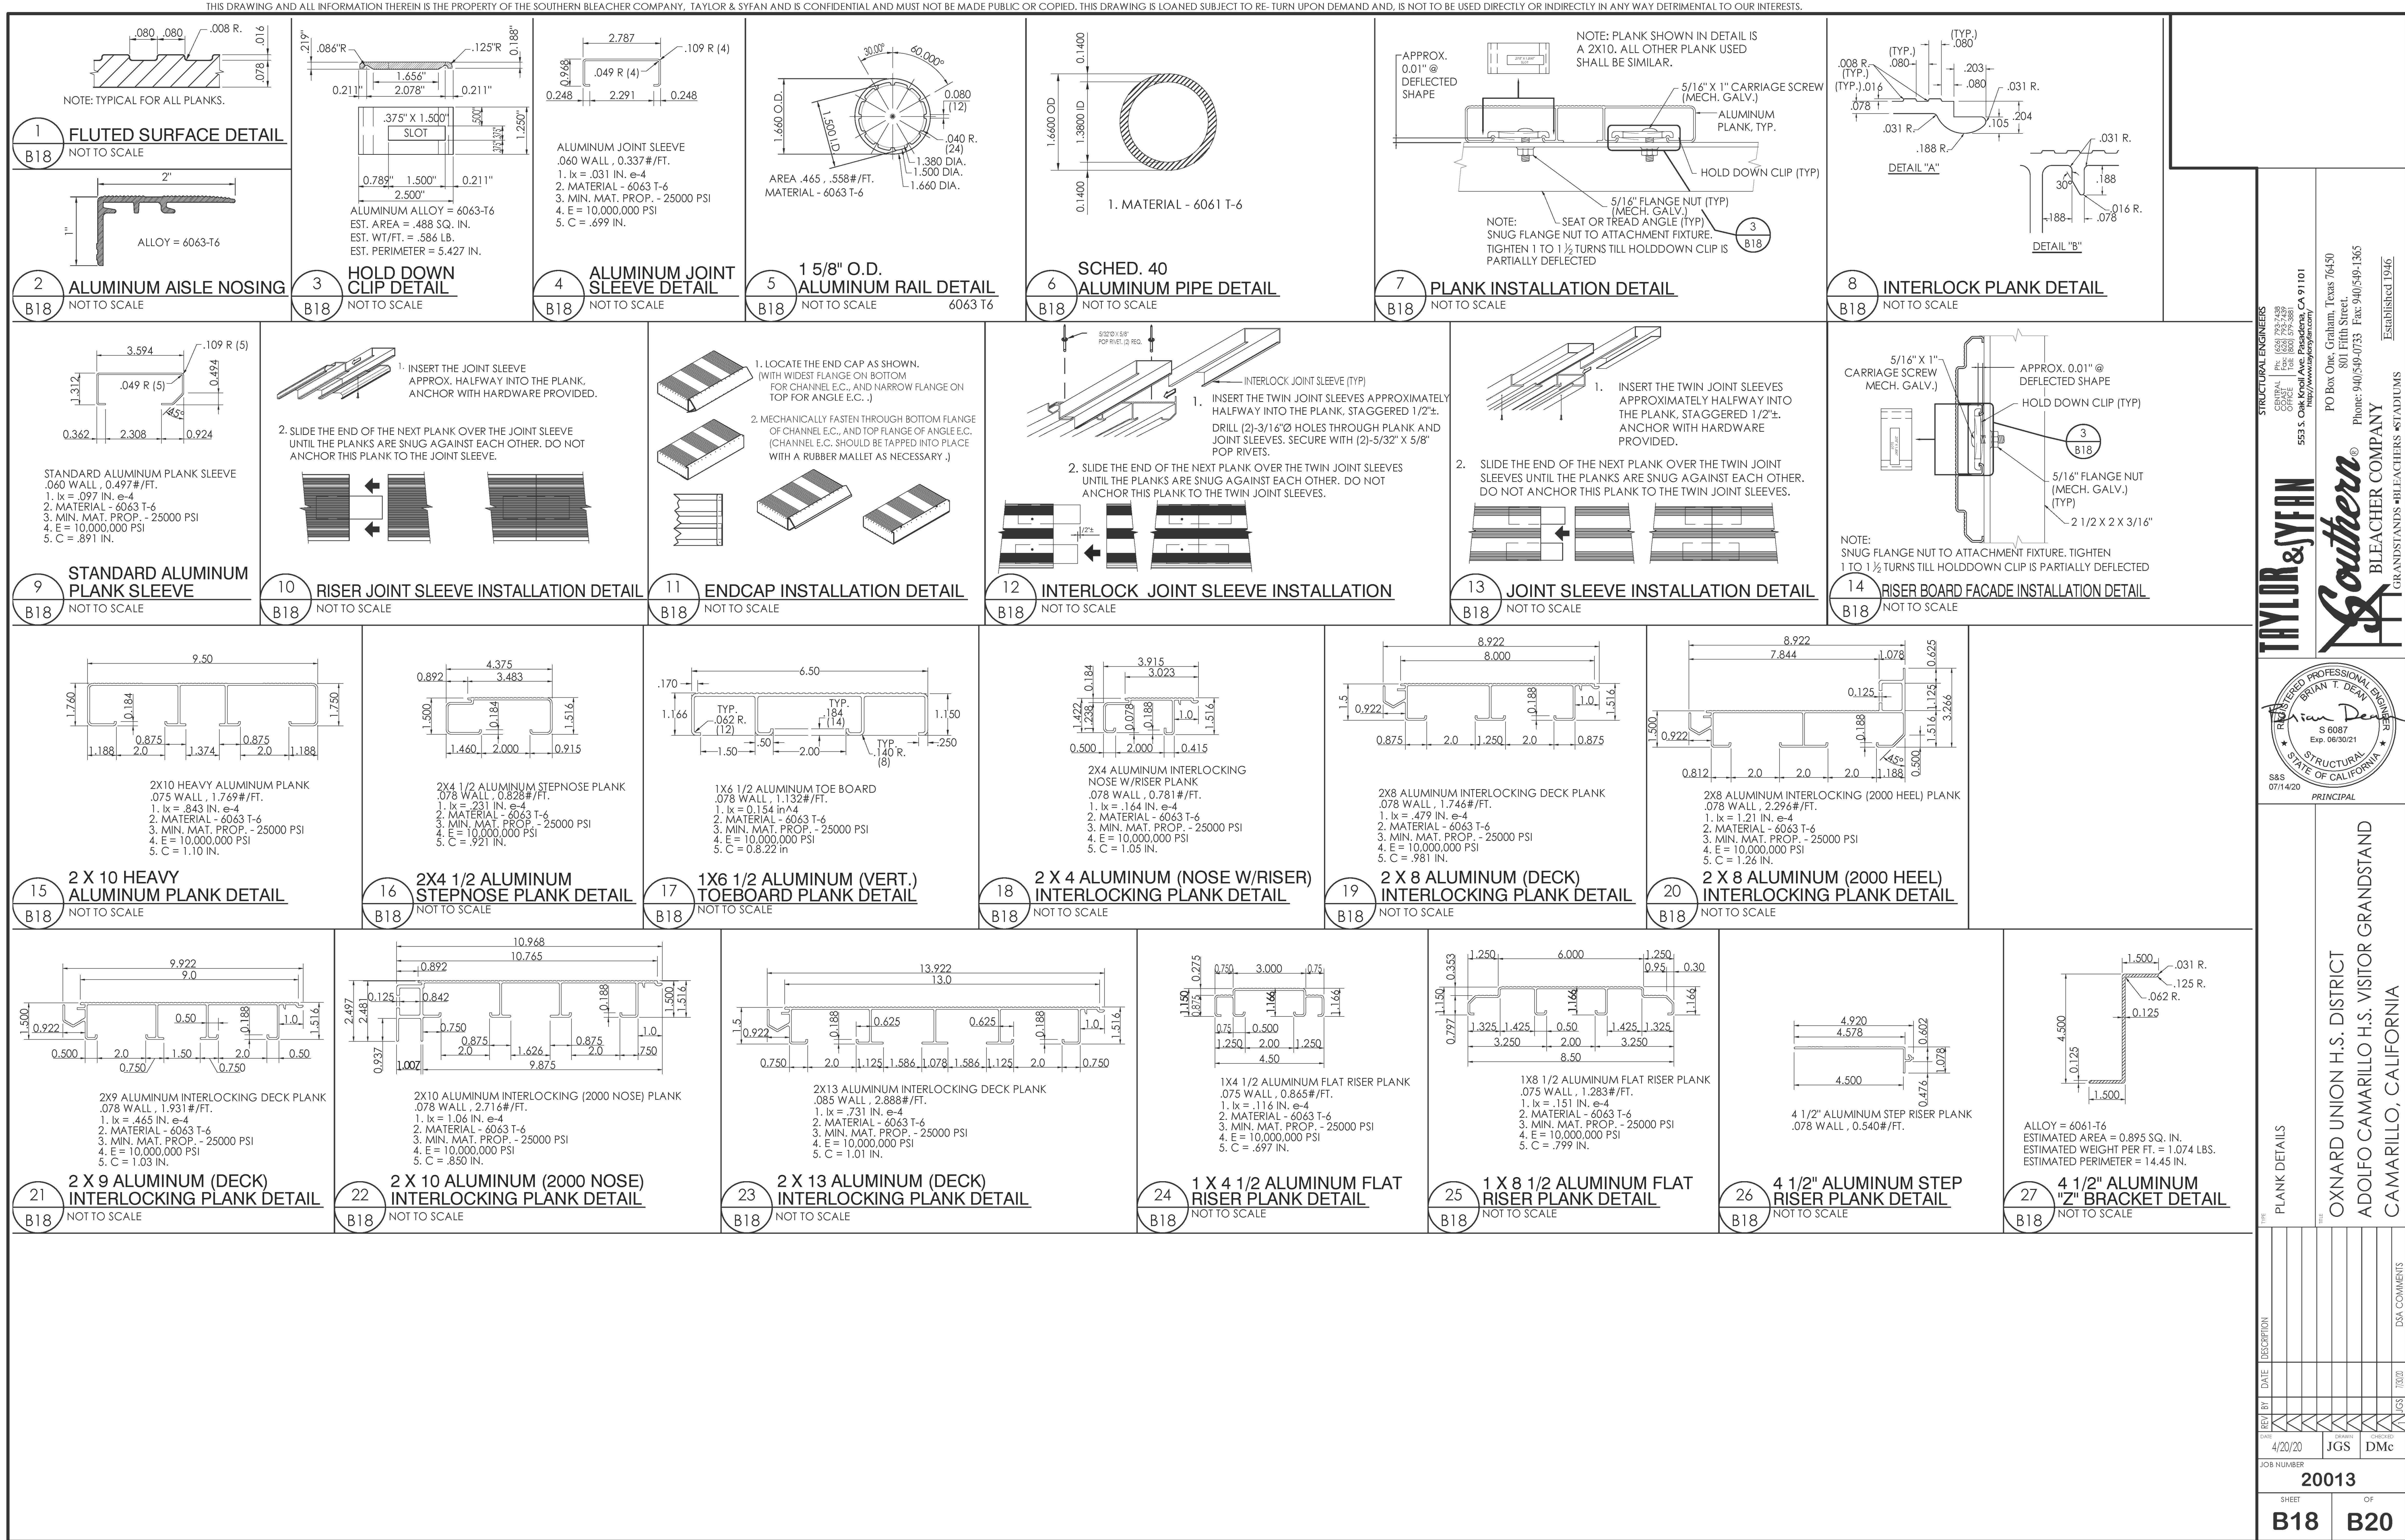

TAYLOR & SYFAN
SOUTHERN BLEACHERS
GENERAL CORP.
5535 Oak Knoll Ave. Pasadena, CA 91101
Phone: (626) 792-7488 Fax: (626) 792-7481
PO Box 608, Camarillo, Texas 76620
880 Fifth Street
Phone: (949) 548-0733 Fax: (949) 549-1365
ESTABLISHED 1946
GRANDSTANDS • BLEACHERS • STADIUMS
BLEACHER COMPANY

SEAN DEAN
REGISTERED PROFESSIONAL ENGINEER
S 6087
Exp. 06/30/21
STRUCTURAL
STATE OF CALIFORNIA
888
07/14/20
PRINCIPAL

AGENCY REVIEW

IDENTIFICATION STAMP
DIV. OF THE STATE ARCHITECT
APP. 03-120480 INC.
REVIEWED FOR
SS ☐ FLS ☐ ACS ☐
DATE: 07/22/2020

LITTLE
DIVERSIFIED ARCHITECTURAL CONSULTING

1300 Dove Street, Suite 100
Newport Beach, CA, 92660
T: 949.698.1400

www.littleonline.com

This drawing and the design shown are the property of Little Diversified Architectural Consulting. The reproduction, copying or other use of this drawing without their written consent is prohibited and any infringement will be subject to legal action.

© Little 2019

CLIENT NAME

OXNARD UNION
HIGH SCHOOL
DISTRICT


PROJECT NAME

ADOLFO CAMARILLO HIGH SCHOOL
VISITOR BLEACHERS

4660 MISSION OAKS BLVD.,
CAMARILLO, CA. 93012

CONSULTANT

SEAL

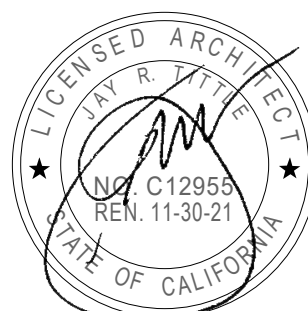

ISSUE FOR

DSA SUBMITTAL

ISSUE DATE

07/22/2020

REVISIONS

NO.	REASON	DATE

PROJECT TEAM

PRINCIPAL IN CHARGE

PROJECT MANAGER

DESIGN TEAM

PROJECT NAME

ADOLFO CAMARILLO HIGH
SCHOOL VISITOR
BLEACHERS

PROJECT NO.


6121235309

SHEET TITLE

PLANK DETAILS

SHEET NUMBER

B18

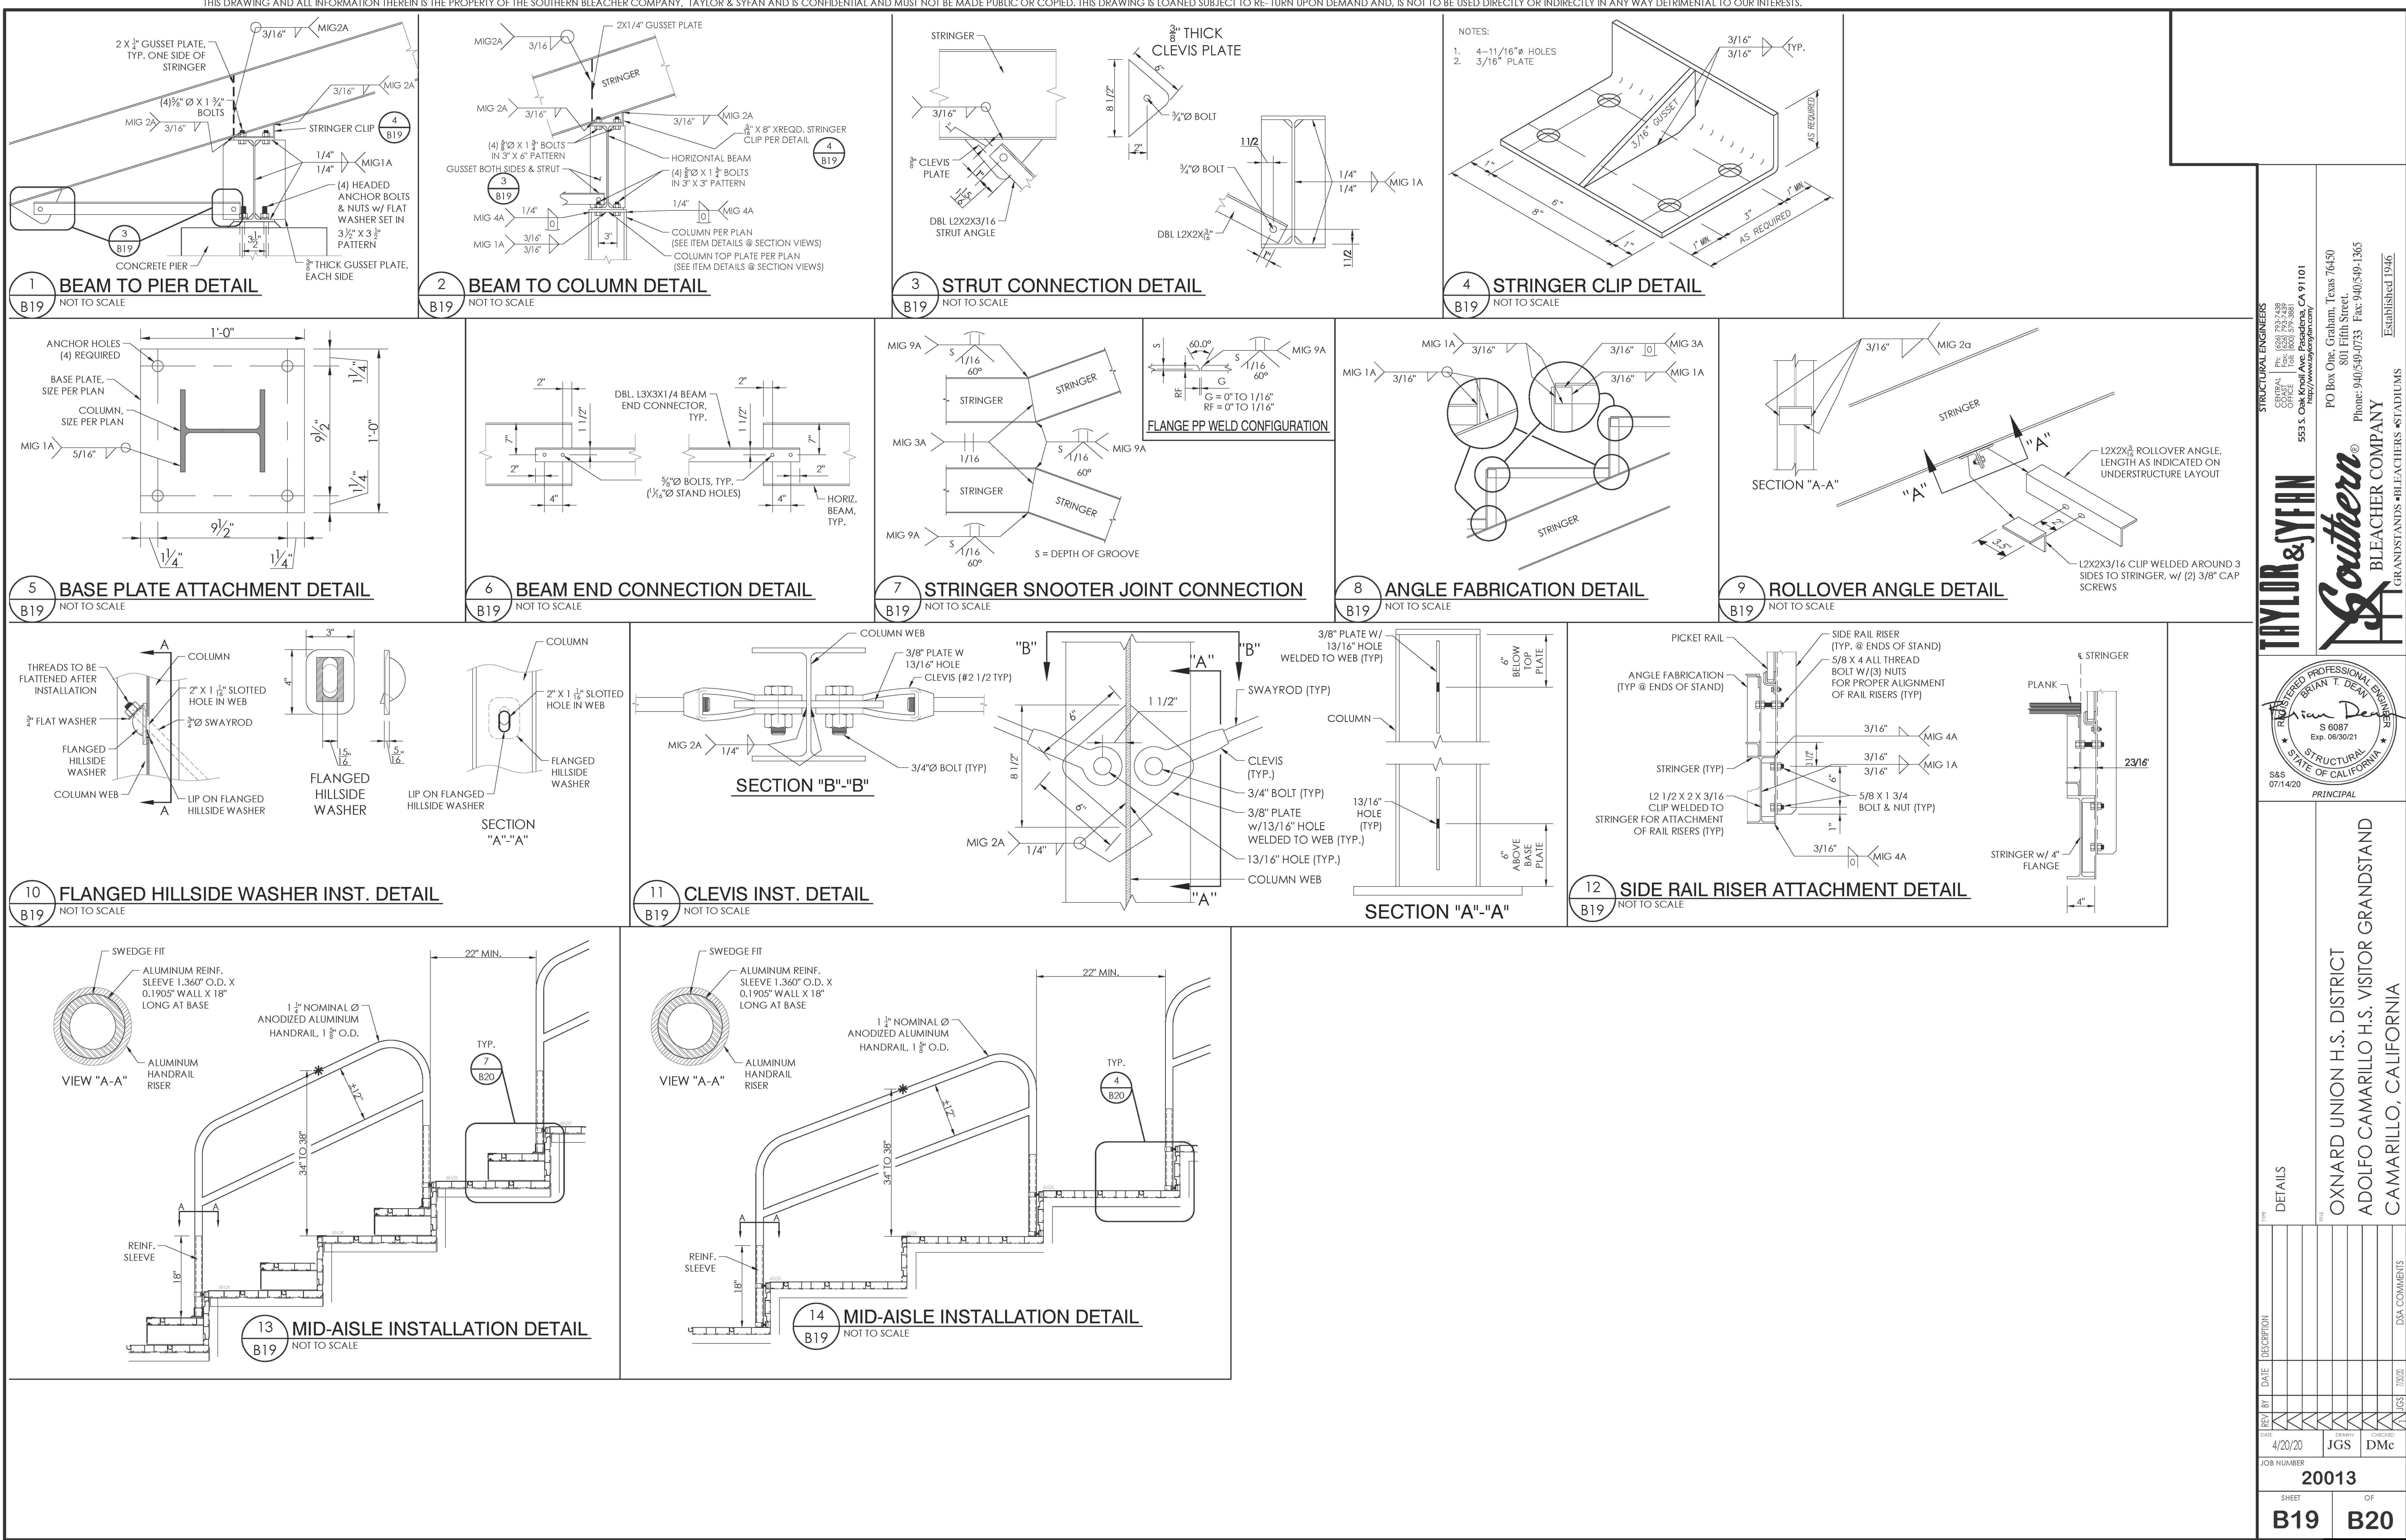

AGENCY REVIEW

IDENTIFICATION STAMP
DIV. OF THE STATE ARCHITECT
APP. 03-120480 INC.
REVIEWED FOR
SS ☐ FLS ☐ ACS ☐
DATE: 07/22/2020

LITTLE
DIVERSIFIED ARCHITECTURAL CONSULTING

1300 Dove Street, Suite 100
Newport Beach, CA, 92660
T: 949.698.1400

www.littleonline.com

This drawing and the design shown are the property of Little Diversified Architectural Consulting. The reproduction, copying or other use of this drawing without their written consent is prohibited and any infringement will be subject to legal action.

© Little 2019

CLIENT NAME

OXNARD UNION
HIGH SCHOOL
DISTRICT

PROJECT NAME

ADOLFO CAMARILLO HIGH SCHOOL
VISITOR BLEACHERS

4660 MISSION OAKS BLVD,
CAMARILLO, CA. 93012

STRUCTURAL ENGINEERS
TAYLOR & SYFAN
GENERAL ENGINEERS
P.O. Box 940, Camarillo, CA 93010
555 S. Oak Road, Suite 100, Camarillo, CA 93010
Phone: (805) 725-2588 Fax: (805) 725-2588

PO Box 940, Camarillo, Texas 76400
801 Fifth Street
Phone: (940) 540-0733 Fax: (940) 549-1365

ESTABLISHED 1946


TAYLOR & SYFAN

Southern
BLEACHER COMPANY

GRANDSTANDS • BLEACHERS • STADIUMS

REGISTERED PROFESSIONAL ENGINEER
BRYAN T. DEAN
S 6087
Exp. 06/30/21
STRUCTURAL
STATE OF CALIFORNIA
830 S
07/14/20
PRINCIPAL

OXNARD UNION H.S. DISTRICT
ADOLFO CAMARILLO H.S. VISITOR GRANDSTAND
CAMARILLO, CALIFORNIA

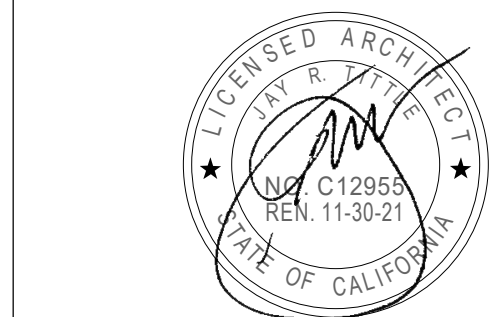

ISSUE FOR
DSA SUBMITTAL

ISSUE DATE
07/22/2020

REVISIONS	NO.	REASON	DATE

PROJECT TEAM

PRINCIPAL IN CHARGE

PROJECT MANAGER

DESIGN TEAM

PROJECT NAME

ADOLFO CAMARILLO HIGH
SCHOOL VISITOR
BLEACHERS

PROJECT NO.



6121235309

SHEET TITLE








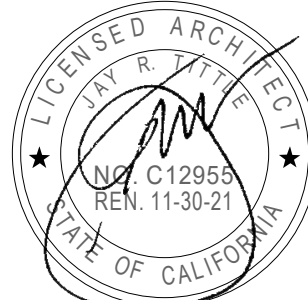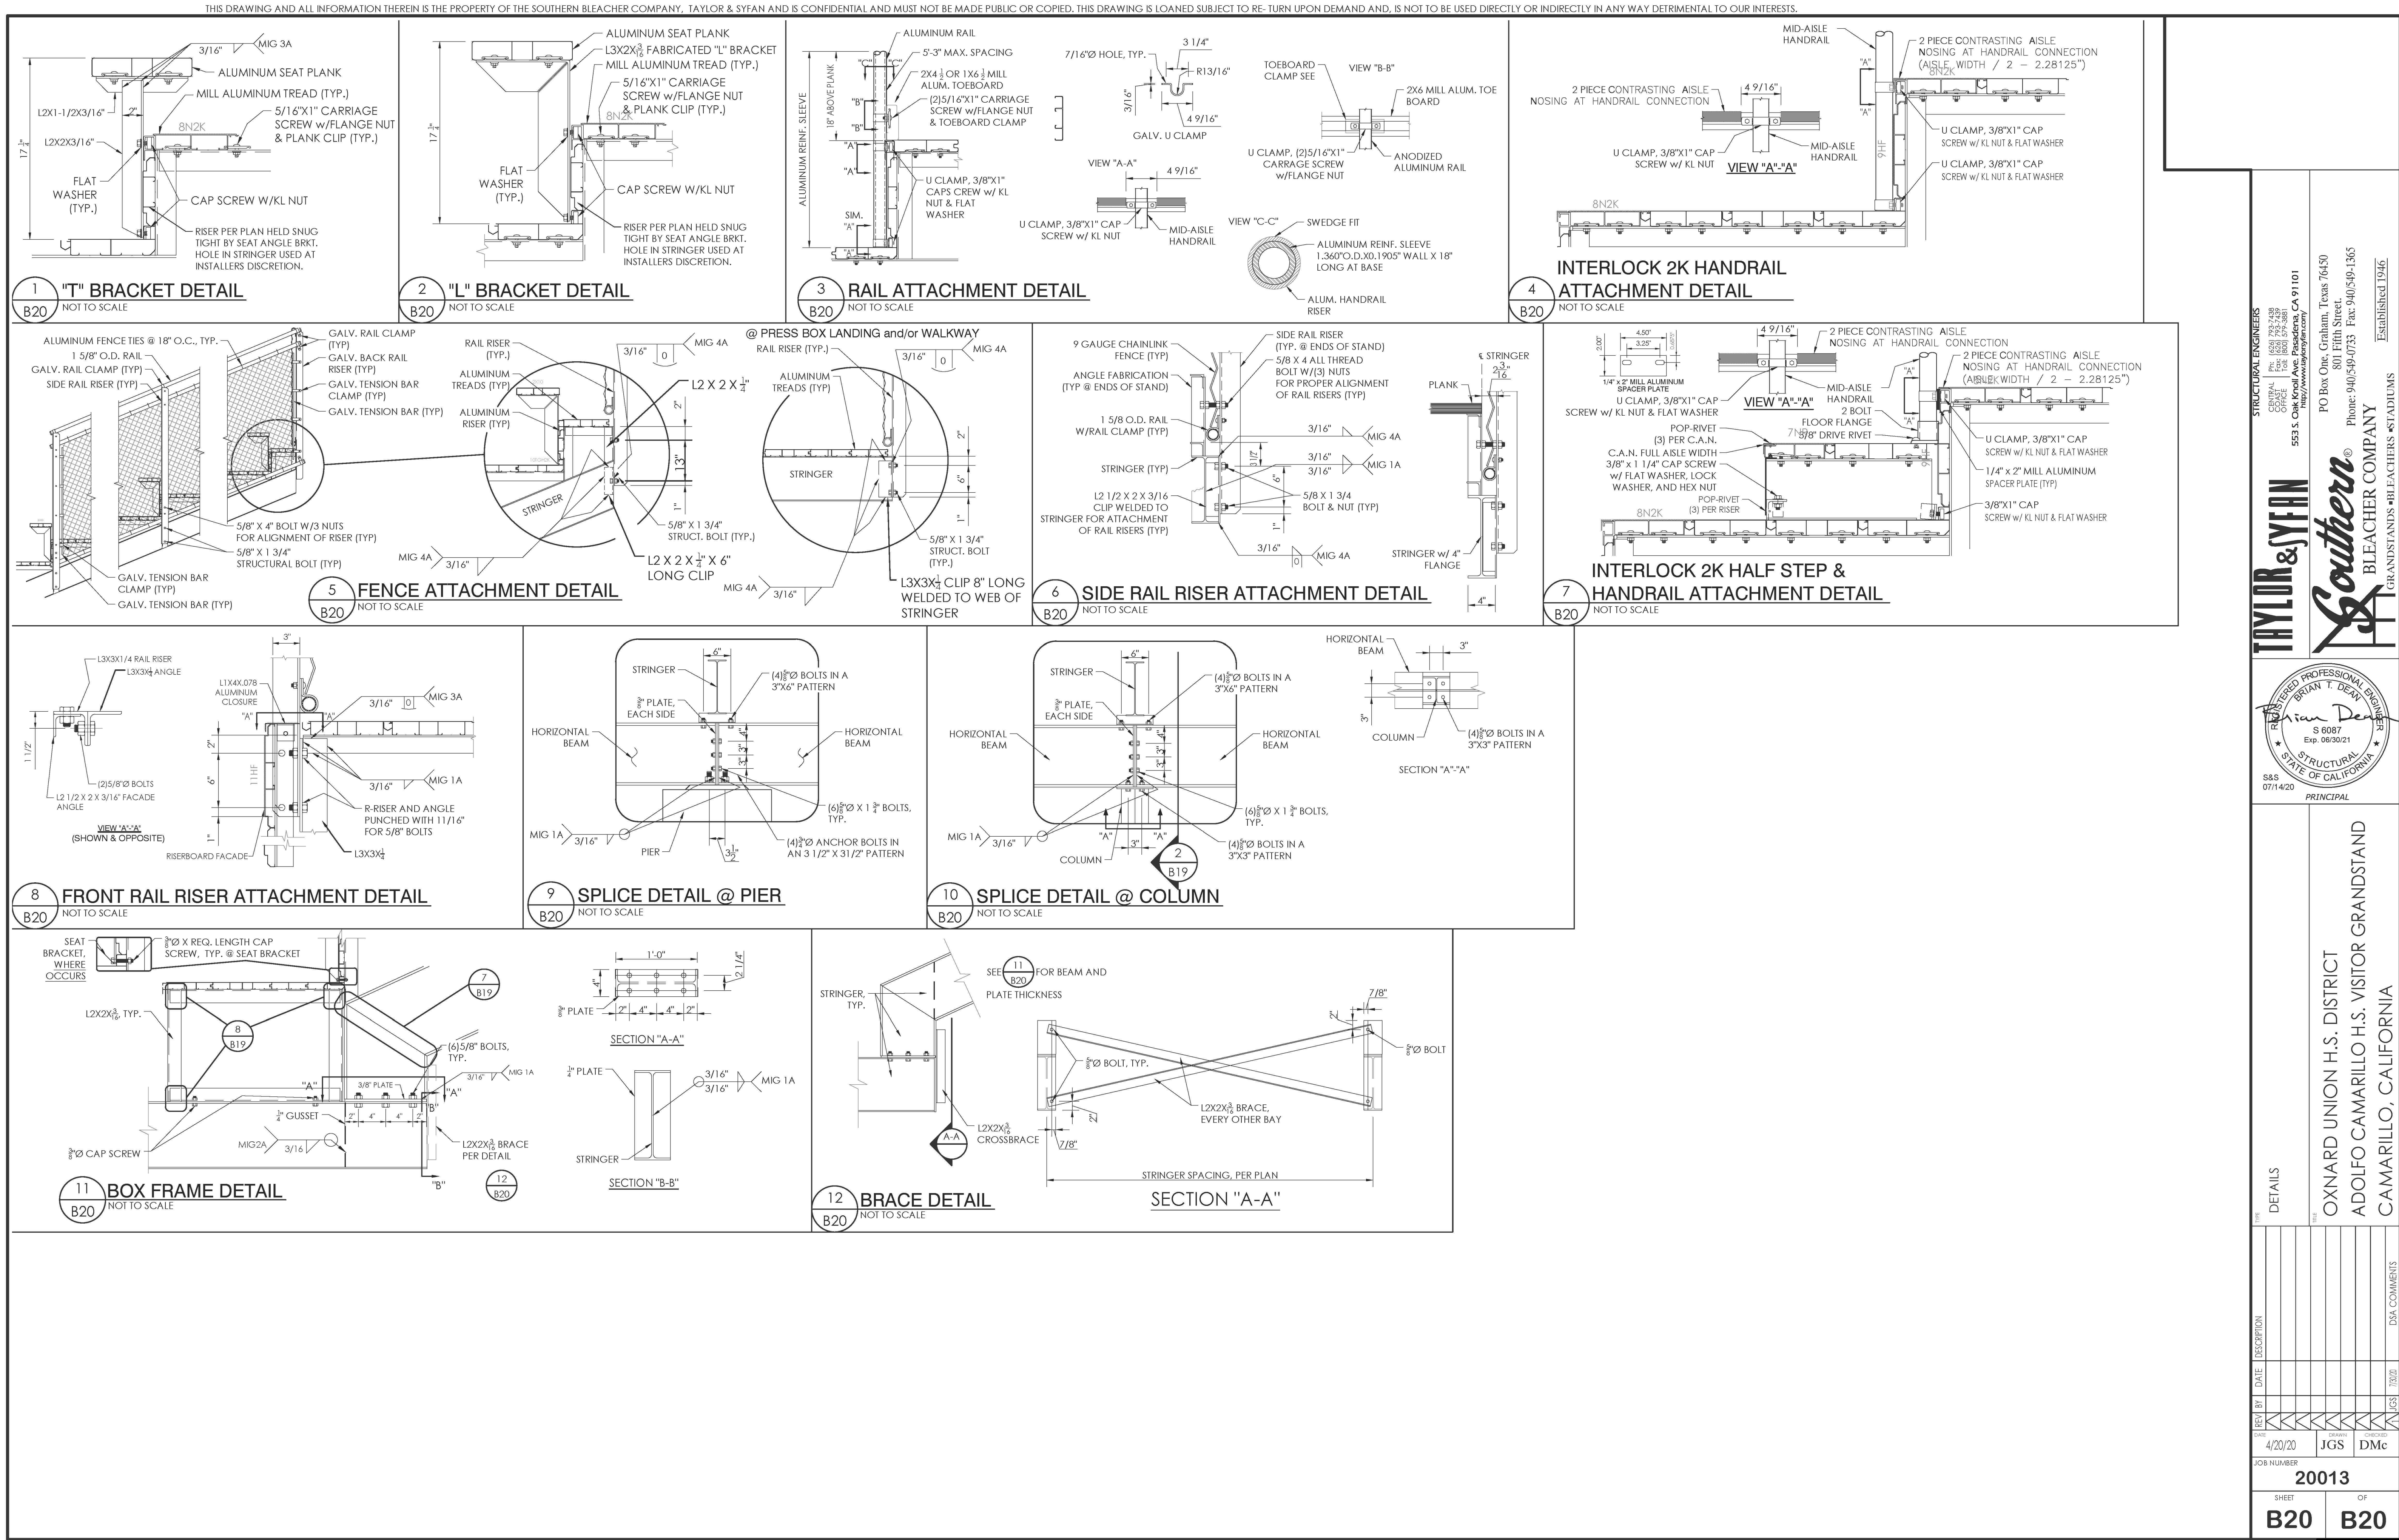







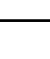
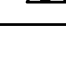
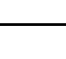
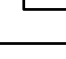

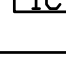
DETAILS

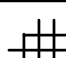SHEET NUMBER

B19

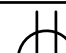


NO.	REASON	DATE

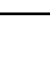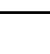SYMBOLS					
	SWITCHES & CONTROLS		POWER		LIGHTING/CEILING
	SWITCH, SINGLE POLE +48" ✖		SERVICE DISCONNECT, FUSED OR NON FUSED PER DRAWING		LIGHT, WALL MOUNTED, HEIGHT PER DRAWING, DETAILS PER FIXTURE SCHEDULE,
	SWITCH, DIMMER, SIZE PER LOAD OR SPECIFICATION +48" ✖		SERVICE DISCONNECT, MAGNETIC STARTER		LIGHT, WALL MOUNTED, HEIGHT PER DRAWING, DETAILS PER FIXTURE SCHEDULE, EMERGENCY LIGHT IF FILLED CENTER
	SWITCH, DIMMER 0-10V +48" ✖		SERVICE DISCONNECT, VFD		LIGHT, CEILING MOUNTED, DETAILS PER FIXTURE SCHEDULE
	SWITCH, 3 WAY, SINGLE POLE +48" ✖		OUTLET, SINGLE, 120V +18" ✖ SIZE PER CIRCUIT AND LOCATION REQUIREMENTS		LIGHT, CEILING MOUNTED, DETAILS PER FIXTURE SCHEDULE EMERGENCY LIGHT IF FILLED CENTER
	SWITCH, 4 WAY +48" ✖		OUTLET, DUPLEX, 120V +18" ✖ SIZE PER CIRCUIT AND LOCATION REQUIREMENTS		LIGHT, CEILING MOUNTED, PENDANT, DETAILS PER FIXTURE SCHEDULE
	SWITCH, KEY +48" ✖		OUTLET, HALF HOT, HALF SWITCHED, 120V +18" ✖ SIZE PER CIRCUIT AND LOCATION REQUIREMENTS		LIGHT, CEILING MOUNTED, PENDANT, DETAILS PER FIXTURE SCHEDULE EMERGENCY LIGHT IF FILLED CENTER
	SWITCH, PILOT LIGHT, SINGLE POLE +48" ✖		OUTLET, DOUBLE DUPLEX, 120V +18" ✖ SIZE PER CIRCUIT AND LOCATION REQUIREMENTS		FLUSH MOUNTED DOWN LIGHT, DETAILS PER FIXTURE SCHEDULE
	SWITCH, TIMER, 2 HR. NO HOLD MANUEL TYPE UNLESS NOTED OTHERWISE +48" ✖		OUTLET, DOUBLE DUPLEX, HALF HOT, HALF SWITCHED, 120V +18" ✖ SIZE PER CIRCUIT AND LOCATION REQUIREMENTS		FLUSH MOUNTED WALL WASH/ADJUSTABLE, DETAILS PER FIXTURE SCHEDULE
	SWITCH, VACANCY DETECTOR +48" ✖		OUTLET, SINGLE, 240V SIZE PER CIRCUIT AND LOCATION REQUIREMENTS		IN-GRADE RECESSED UP-LIGHT, DETAILS PER FIXTURE SCHEDULE
	OCCUPANCY SENSOR SINGLE CIRCUIT WALL SWITCH +48" ✖		OUTLET, SINGLE, 120/240V SIZE PER CIRCUIT AND LOCATION REQUIREMENTS		FLUSH MOUNTED DOWN LIGHT, SQUARE CAN, DETAILS PER FIXTURE SCHEDULE
	OCCUPANCY SENSOR DUAL CIRCUIT WALL SWITCH +48" ✖		OUTLET, SINGLE, 3 PHASE SIZE AND TYPE PER CIRCUIT REQUIREMENTS OR SPECIFICATION		FLUSH MOUNTED WALL WASH/ADJUSTABLE, SQUARE CAN, DETAILS PER FIXTURE SCHEDULE
	OCCUPANCY SENSOR SINGLE CIRCUIT DIMMER 120V WALL SWITCH - LIKE LUTRON +48" ✖		OUTLET, DUPLEX, 120V, GFCI +18" ✖ SIZE PER CIRCUIT AND LOCATION REQUIREMENTS		LIGHT, xxxxxx, DETAILS PER FIXTURE SCHEDULE
	OCCUPANCY SENSOR SINGLE CIRCUIT DIMMER 0-10V WALL SWITCH - LIKE LUTRON +48" ✖		OUTLET, DOUBLE DUPLEX, 120V, GFCI +18" ✖ SIZE AND TYPE PER CIRCUIT REQUIREMENTS OR SPECIFICATION		LIGHT, xxxxxx, DETAILS PER FIXTURE SCHEDULE
	CEILING MOUNTED MOTION SENSOR, ULTRA SOUND		OUTLET, DUPLEX, 120V, FLOOR MOUNT SIZE PER CIRCUIT AND LOCATION REQUIREMENTS		LIGHT, xxxxxx, DETAILS PER FIXTURE SCHEDULE
	CEILING MOUNTED MOTION SENSOR, INFRARED		OUTLET, DOUBLE DUPLEX, 120V, FLOOR MOUNT SIZE PER CIRCUIT AND LOCATION REQUIREMENTS		LIGHT, xxxxxx, DETAILS PER FIXTURE SCHEDULE
	CEILING MOUNTED MOTION SENSOR, COMBINATION ULTRA SOUND / INFRARED		OUTLET, PEDOC, DUPLEX, 120V, GFCI ✖ SIZE PER CIRCUIT AND LOCATION REQUIREMENTS		VANITY WALL LIGHT, DETAILS PER FIXTURE SCHEDULE
	CEILING MOUNTED RELAY / POWER PACK FOR LOW VOLTAGE MOTION SENSORS, SIZE PER CIRCUIT AND SENSOR REQUIREMENTS		OUTLET, PEDOC, DOUBLE DUPLEX, 120V, GFCI ✖ SIZE AND TYPE PER CIRCUIT REQUIREMENTS OR SPECIFICATION		TRACK LIGHT, DETAILS PER FIXTURE SCHEDULE
	CEILING MOUNTED RELAY SLAVE PACK FOR LOW VOLTAGE MOTION SENSOR, SIZE PER CIRCUIT AND SENSOR REQUIREMENTS		OUTLET, PEDOC, SINGLE, 120/240V, GFCI ✖ SIZE PER CIRCUIT AND LOCATION REQUIREMENTS		COVE LIGHT, DETAILS PER FIXTURE SCHEDULE
	THERMOSTAT, +48" ✖		OUTLET, SINGLE/2-PORT USB COMBO, 120V ✖ SIZE PER CIRCUIT AND LOCATION REQUIREMENTS		LIGHT, POLE-ARM, DETAILS PER FIXTURE SCHEDULE
	TIME CLOCK, POLES AND VOLTAGE AS NEEDED OR SPECIFIED		OUTLET, 4-PORT USB ✖ SIZE PER CIRCUIT AND LOCATION REQUIREMENTS		LIGHT, POLE-CENTER, DETAILS PER FIXTURE SCHEDULE
	EXTERIOR-PHOTO CELL, SIZE AND VOLTAGE PER CIRCUIT OR AS SPECIFIED INTERIOR-0-10V PHOTO SENSOR RE. DAYLIGHT CONTROLLER		OUTLET, DUPLEX EM CIRCUIT, 120V +18" ✖ SIZE PER CIRCUIT AND LOCATION REQUIREMENTS		LIGHT, BOLLARD SQUARE, DETAILS PER FIXTURE SCHEDULE
			JUNCTION BOX		LIGHT, BOLLARD ROUND, DETAILS PER FIXTURE SCHEDULE
					LANDSCAPE UP OR DOWN LIGHT, DETAILS PER FIXTURE SCHEDULE
			COMMUNICATIONS/CONTROLS		EXIT SIGN, DARK SPOT INDICATES DIRECTION THE LIGHTED FACE IS TO BE VISIBLE FROM, ARROWS INDICATE DIRECTION OF ARROWS ON THE SIGN FACE
					EXIT SIGN, DARK SPOTS INDICATE DIRECTION THE LIGHTED FACES ARE TO BE VISIBLE FROM, ARROWS INDICATE DIRECTION OF ARROWS ON THE SIGN FACE
	NOTES & MISC.		THERMOSTAT, +48" ✖		EXIT SIGN, DARK SPOTS INDICATE DIRECTION THE LIGHTED FACES ARE TO BE VISIBLE FROM, ARROWS INDICATE DIRECTION OF ARROWS ON THE SIGN FACE
	INDICATES PLAN KEYED NOTE		HUMIDITY SENSOR		COMBINATION EXIT SIGN, EMERGENCY LIGHT WITH BATTERY BACK UP
	INDICATES PLAN KEYED NOTE		SPEAKER AND BOX PROVIDED BY OTHERS, BOX PIPED AND INSTALLED BY E. C.		EMERGENCY LIGHT, BATTERY POWERED
	INDICATES PLAN KEYED NOTE		TELEPHONE OUTLET, +18" ✖		STEP/NICHE LIGHT, DETAILS PER FIXTURE SCHEDULE
	INDICATES REVISION		COMPUTER OUTLET, +18" ✖		LIGHT, WALL SMALL UP/DN-LIGHT, HEIGHT PER DRAWING, DETAILS PER FIXTURE SCHEDULE
	INDICATES FIXTURE TYPE		CABLE OUTLET, +18" ✖		ALL LIGHT FIXTURES ABOVE ARE EMERGENCY LIGHT IF FILLED CENTER
	INDICATES MECHANICAL FIXTURE TYPE		TELEPHONE OUTLET, FLOOR		FIRE
	INDICATES DETAIL		COMPUTER OUTLET, FLOOR		FIRE DUCT SMOKE DETECTOR
	PANEL, MOUNTING ACCORDING TO PLACEMENT ON PLANS		CABLE OUTLET, FLOOR		FIRE DUCT DAMPENER
	PANEL, CONTROL-LRG, MOUNTING ACCORDING TO PLACEMENT ON PLANS		COMBINATION TELEPHONE & COMPUTER OUTLET, +18" ✖		FIRE MINI STROBE
	PANEL, CONTROL-SML, MOUNTING ACCORDING TO PLACEMENT ON PLANS		TELEVISION OUTLET, +18" ✖		FIRE ALARM CHIME
	VALVE, ALARM CONTACT OR SOLENOID OPERATOR DEPENDING ON APPLICATION		DOOR BELL PUSH BUTTON		FIRE STROBE & HORN
	EYS FITTING, SIZE PER CONDUIT, LOCATE PER N.E.C.		DOOR BELL CHIME		FIRE ALARM PULL BOX
	SMOKE DETECTOR, CEILING OR WALL MOUNTED PER PLANS		DOOR BELL TRANSFORMER		WIRE TYPES
	COMBINATION SMOKE DETECTOR AND CO SENSOR		NURSES CALL LIGHT		HOME RUN IN CABLE OR CONDUIT (PER SPECIS AND CODE), CIRCUIT AND CIRCUIT & CONDUCTOR SIZE AS NOTED, CONDUIT PER NEC OR AS NOTED
	EXHAUST FAN		NURSES CALL SWITCH WITH PULL CORD		EXISTING WIRING TO REMAIN
	CEILING FAN		ELECTRIC DOOR STRIKE RELEASE		EXISTING WIRING TO BE REMOVED
	MOTOR		WIRELESS ACCESS POINT		NEW ABOVE FLOOR WIRING
	POWER SUPPLY		INTERCOM		NEW UNDER FLOOR WIRING
	POWER CENTER		KEY PAD		STUB UP TO OR DOWN FROM NEXT FLOOR LEVEL
	CURRENT LIMITER				STUB DOWN TO OR UP FROM THE NEXT FLOOR LEVEL
	✖ STANDARD HEIGHT TO MEET STATE ACCESSIBILITY REQUIREMENTS AND PROVISIONS OF THE ADA IS 36" - 48" AFF FOR SWITCHES AND THERMOSTATS, 15" - 48" FOR OUTLETS. HEIGHT SHOWN IN SYMBOL LIST IS PREFERRED HEIGHT TO BE CHANGED ONLY IF PHYSICAL REQUIREMENTS OF THE STRUCTURE OR CASEWORK REQUIRE. CHANGES MUST MEET STANDARDS IF OUTLET OR SWITCH IS FOR GENERAL USAGE. OUTLET TO BE MOUNTED AT HEIGHT SHOWN ON PLAN WHEN SPECIAL PURPOSE.				
SYMBOLS				SCALE: NONE	

- GENERAL
- All work is to be performed per the 2019 issue of the California Electrical Code and the 2019 California Energy Code as accepted by the City of OXNARD and all other applicable national, state and local codes and laws pertaining to electrical work.
 - All work in hazardous locations shall comply with CEC Art. 500 through 516 as applicable.
 - Nothing in these notes shall be construed as circumventing any more stringent specification or requirement of the contract documents.
 - Electrical Contractor shall visit the job site prior to bidding work and include in his bid the necessary costs required to complete this project according to the intent of the drawings.
 - Any discrepancies between site conditions and drawings shall be brought to the attention of the project coordinator or Architect prior to bid if possible.
 - Electrical work under this contract shall include all labor, materials and equipment necessary to complete the installation covered under the contract including control conduit and wiring as documented or inferred in the mechanical drawings.
 - All material and equipment furnished and or installed under this contract shall be new, free from defects, and shall be guaranteed for a period of one year from the date of final acceptance by owner or his representative. Should any problems develop during this warranty period due to faulty workmanship, material defects or equipment defects or failure, the Electrical Contractor shall correct the problem and repair or replace equipment or material without cost to the owners. All work shall be executed in a workmanlike manner and shall be neat in appearance as well as functional when completed.
 - Unless noted otherwise or coordinated with the General Contractor, the Electrical Contractor shall be responsible for all demolition, cutting, and patching relating to electrical work.
 - State handicap requirements are to be met per standards listed in 'SYMBOL LIST'.
 - Cut sheets shall be provided by Electrical Contractor for all equipment provided within contract scope of work.


- MATERIAL AND INSTALLATION
- All electrical materials and equipment are to be Underwriter's laboratory listed or listed by an equivalent nationally recognized testing laboratory accepted by the City of OXNARD. All materials shall be approved for the intended purpose and used for such purpose.
 - All 600-volt insulated wire in conduits shall be copper type THHN/THWN-2 unless noted otherwise.
 - All conductors size AWG #12 and smaller shall be solid, all conductors size #10 and larger shall be stranded.
 - All junction boxes shall be marked (in ink) with the panel number, circuit numbers, and system voltage contain within, ('Magic Markers' are acceptable). ie. 'LA'-1,3,5 277/480V or 'RA'-2,4,6 120/208V etc.
 - When conduit must cross traffic areas, the conduit shall cross perpendicular to the normal traffic pattern.
 - All ballasts are to be CEC listed.
 - All outdoor lighting fixtures are to be listed for wet or damp location depending on type of exposure.
 - All devices shall be grounded by means of a separate grounding conductor and either a wire bond from the device strap to the box or a self-grounding screw.
 - Each multiwire branch circuit shall be provided with a means that will simultaneously disconnect all ungrounded conductors at the point where the branch circuit originates. (CEC 210.4(B))
 - The ungrounded and grounded conductors of each multiwire branch circuit shall be grouped by wire ties or similar means in at least one location within the panelboard or other point of origination. (CEC 210.4(D))
 - All new overcurrent devices installed in existing panels/switchboards shall match or exceed the make, model and interrupting capacity of the existing overcurrent devices.

- COMPLETION
- Upon completion of work, Electrical Contractor shall insure the installation to be free from short circuits, phase grounds and neutral grounds.
 - All feeders shall have insulation tested prior to energization.
 - All panels, transformers, distribution boards, switches, etc. shall be labeled per Single Line Diagram using plastic plates with 3/8" high white letters on black backgrounds. Label shall include item name and voltage present. Transformer label shall include both primary and secondary voltages. Label shall be permanently attached using at least (2) round head stainless steel machine screws with minimum thread size 8-32.
 - Electrical Contractor shall furnish as-built drawings to Architect upon completion of work.
 - Electrical Contractor shall be available for night inspection and approval of completed work.
 - Prior to final energization, neutral feed shall be disconnected from the panel and bus with all load neutrals connected shall be tested in the presence of the electrical engineer for faults to ground.
 - All circuit breaker, neutral and ground lug connections shall be torqued per manufacturer's specifications in the presence of the electrical inspector.
 - The issuance of a permit shall not prevent the Building Official from requiring the correction of errors on these plans or from preventing any violation of the codes adopted by the city, relevant laws, ordinances, rules and/or regulations.

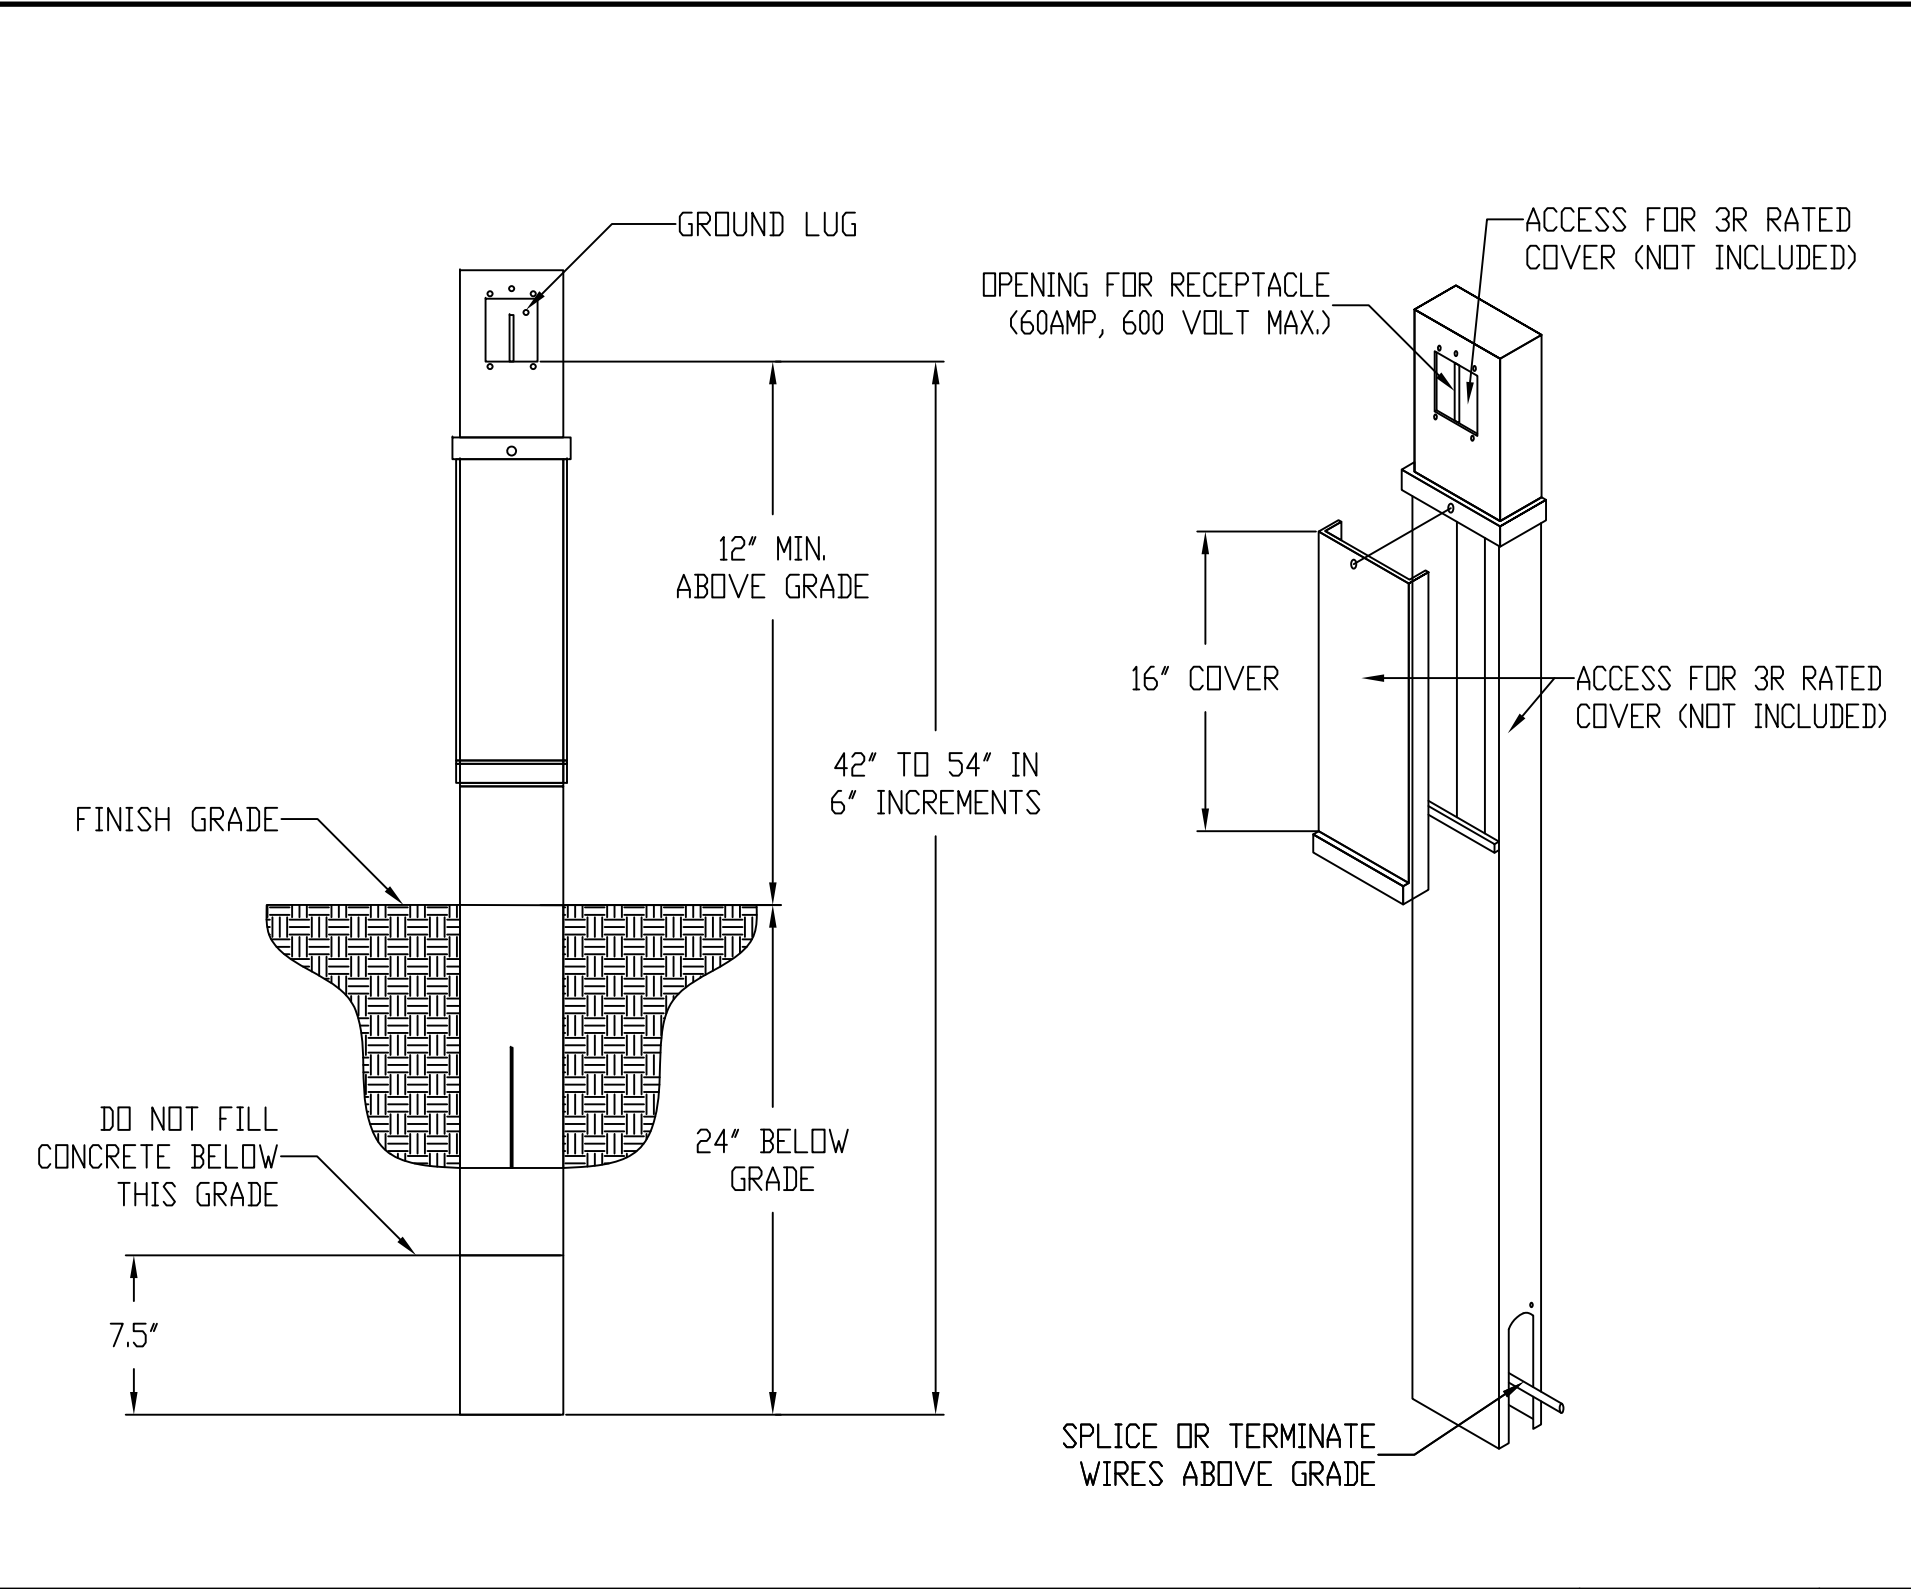


PEDESTAL DETAIL

SCALE: NONE

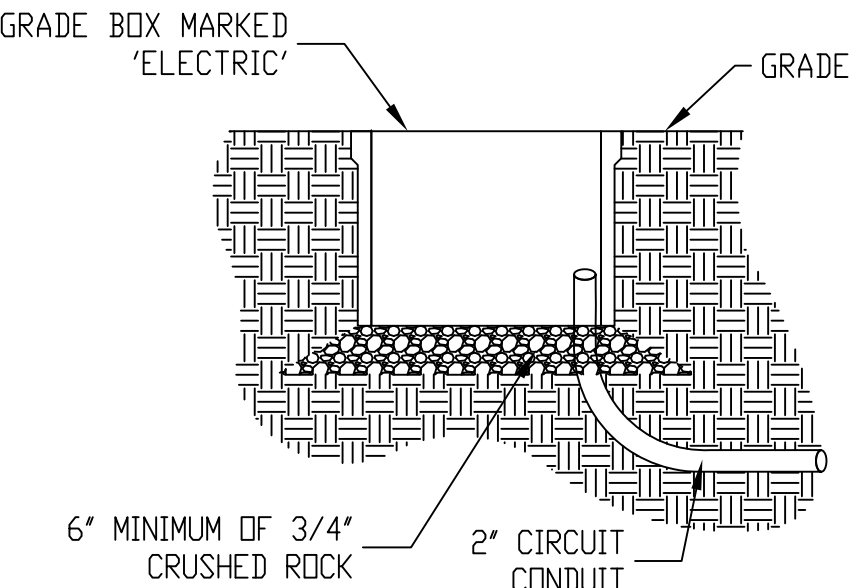

11 X 17 AND 16 X 24 GRADE BOX

SCALE: NONE

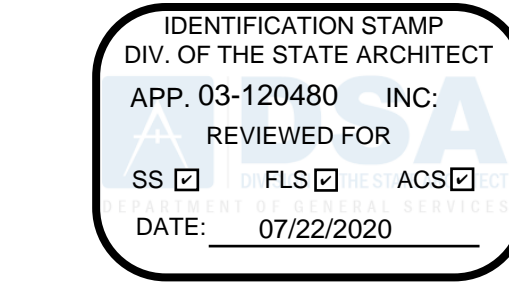

LITTLE
DIVERSIFIED ARCHITECTURAL CONSULTING



www.littleonline.com

This drawing and the design shown are the property of Little Diversified Architectural Consulting. The reproduction, copying or other use of this drawing without their written consent is prohibited and any infringement will be subject to legal action.
© Little 2019

OXNARD UNION
HIGH SCHOOL
DISTRICT

ADOLFO CAMARILLO HIGH SCHOOL
SOUTHERN BLEACHERS

4660 MISSION OAKS BLVD,
CAMARILLO, CA. 93012

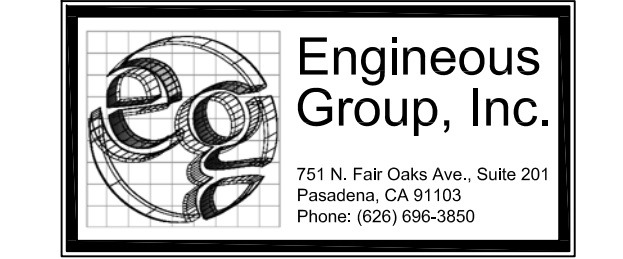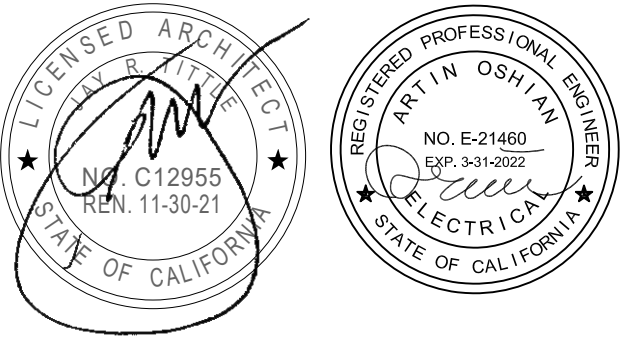

DSA SUBMITTAL

07/22/2020

NO.	REASON	DATE

PRINCIPAL IN CHARGE
B.E.S.
PROJECT MANAGER
S.A.M.
DESIGN TEAM
D.L.E.

ADOLFO CAMARILLO HIGH
SCHOOL SOUTHERN BLEACHERS

SYMBOLS AND NOTES

E-000

NOTES

SCALE: NONE

- POWER GENERAL NOTES
1. ALL CONDUITS SHALL BE RUN NEATLY AND PARALLEL OR PERPENDICULAR TO STRUCTURAL MEMBERS. CONDUIT ROUTING SHOWN ON PLAN IS DIAGRAMMATIC AND IS INTENDED TO SHOW POSSIBLE FUNCTIONAL ROUTE OF CONDUITS AND CONDUCTORS. IN SOME CASES THE DRAWING SHOWS ROUTING WHICH MAY NOT BE PARALLEL OR PERPENDICULAR TO BUILDING STRUCTURAL MEMBERS. THIS IS FOR CLARITY OF CIRCUITING AND NOT INTENDED TO APPROVE ANY DEVIATION FROM NEAT WORKMANSHIP.
 2. COMBINING OF HOMERUNS AND OTHER CIRCUITS OTHER THAN WHAT IS SHOWN ON PLAN WILL NOT BE APPROVED.
 3. CONDUITS AND ROUTING FOUND OBJECTIONABLE BY THE ARCHITECT WILL BE REWORKED AT ELECTRICAL CONTRACTORS EXPENSE.
 4. ELECTRICAL CONTRACTOR SHALL PROVIDE APPROVED SEISMIC STRUCTURAL SUPPORTS AS CURRENTLY ADOPTED BY IBC OR CBC WHERE APPLICABLE FOR ALL FIXTURES, BOXES AND OTHER ELECTRICAL EQUIPMENT.
 5. ELECTRICAL CONTRACTOR SHALL VERIFY LOCATIONS AND MOUNTING HEIGHTS OF ALL OUTLETS AND EQUIPMENT WITH ARCHITECTURAL PLANS, ELEVATIONS AND DETAILS.


POWER PLAN KEYED NOTES (NOT ALL MAY APPLY)

P1 1 1/2"C-6#8 THWN CU BETWEEN PULL BOXES FOR NEW PEDESTALS UNDER BLEACHERS. CONDUITS SHALL BE BURIED 24" BELOW GRADE. CONTRACTOR SHALL VERIFY EXISTING UNDERGROUND CONDUITS ROUTES AND PULL BOXES TO BE RE-USED OR INTERCEPTED, IF POSSIBLE, PRIOR TO CONSTRUCTION.

SITE PLAN KEY NOTES

SCALE: NONE

2

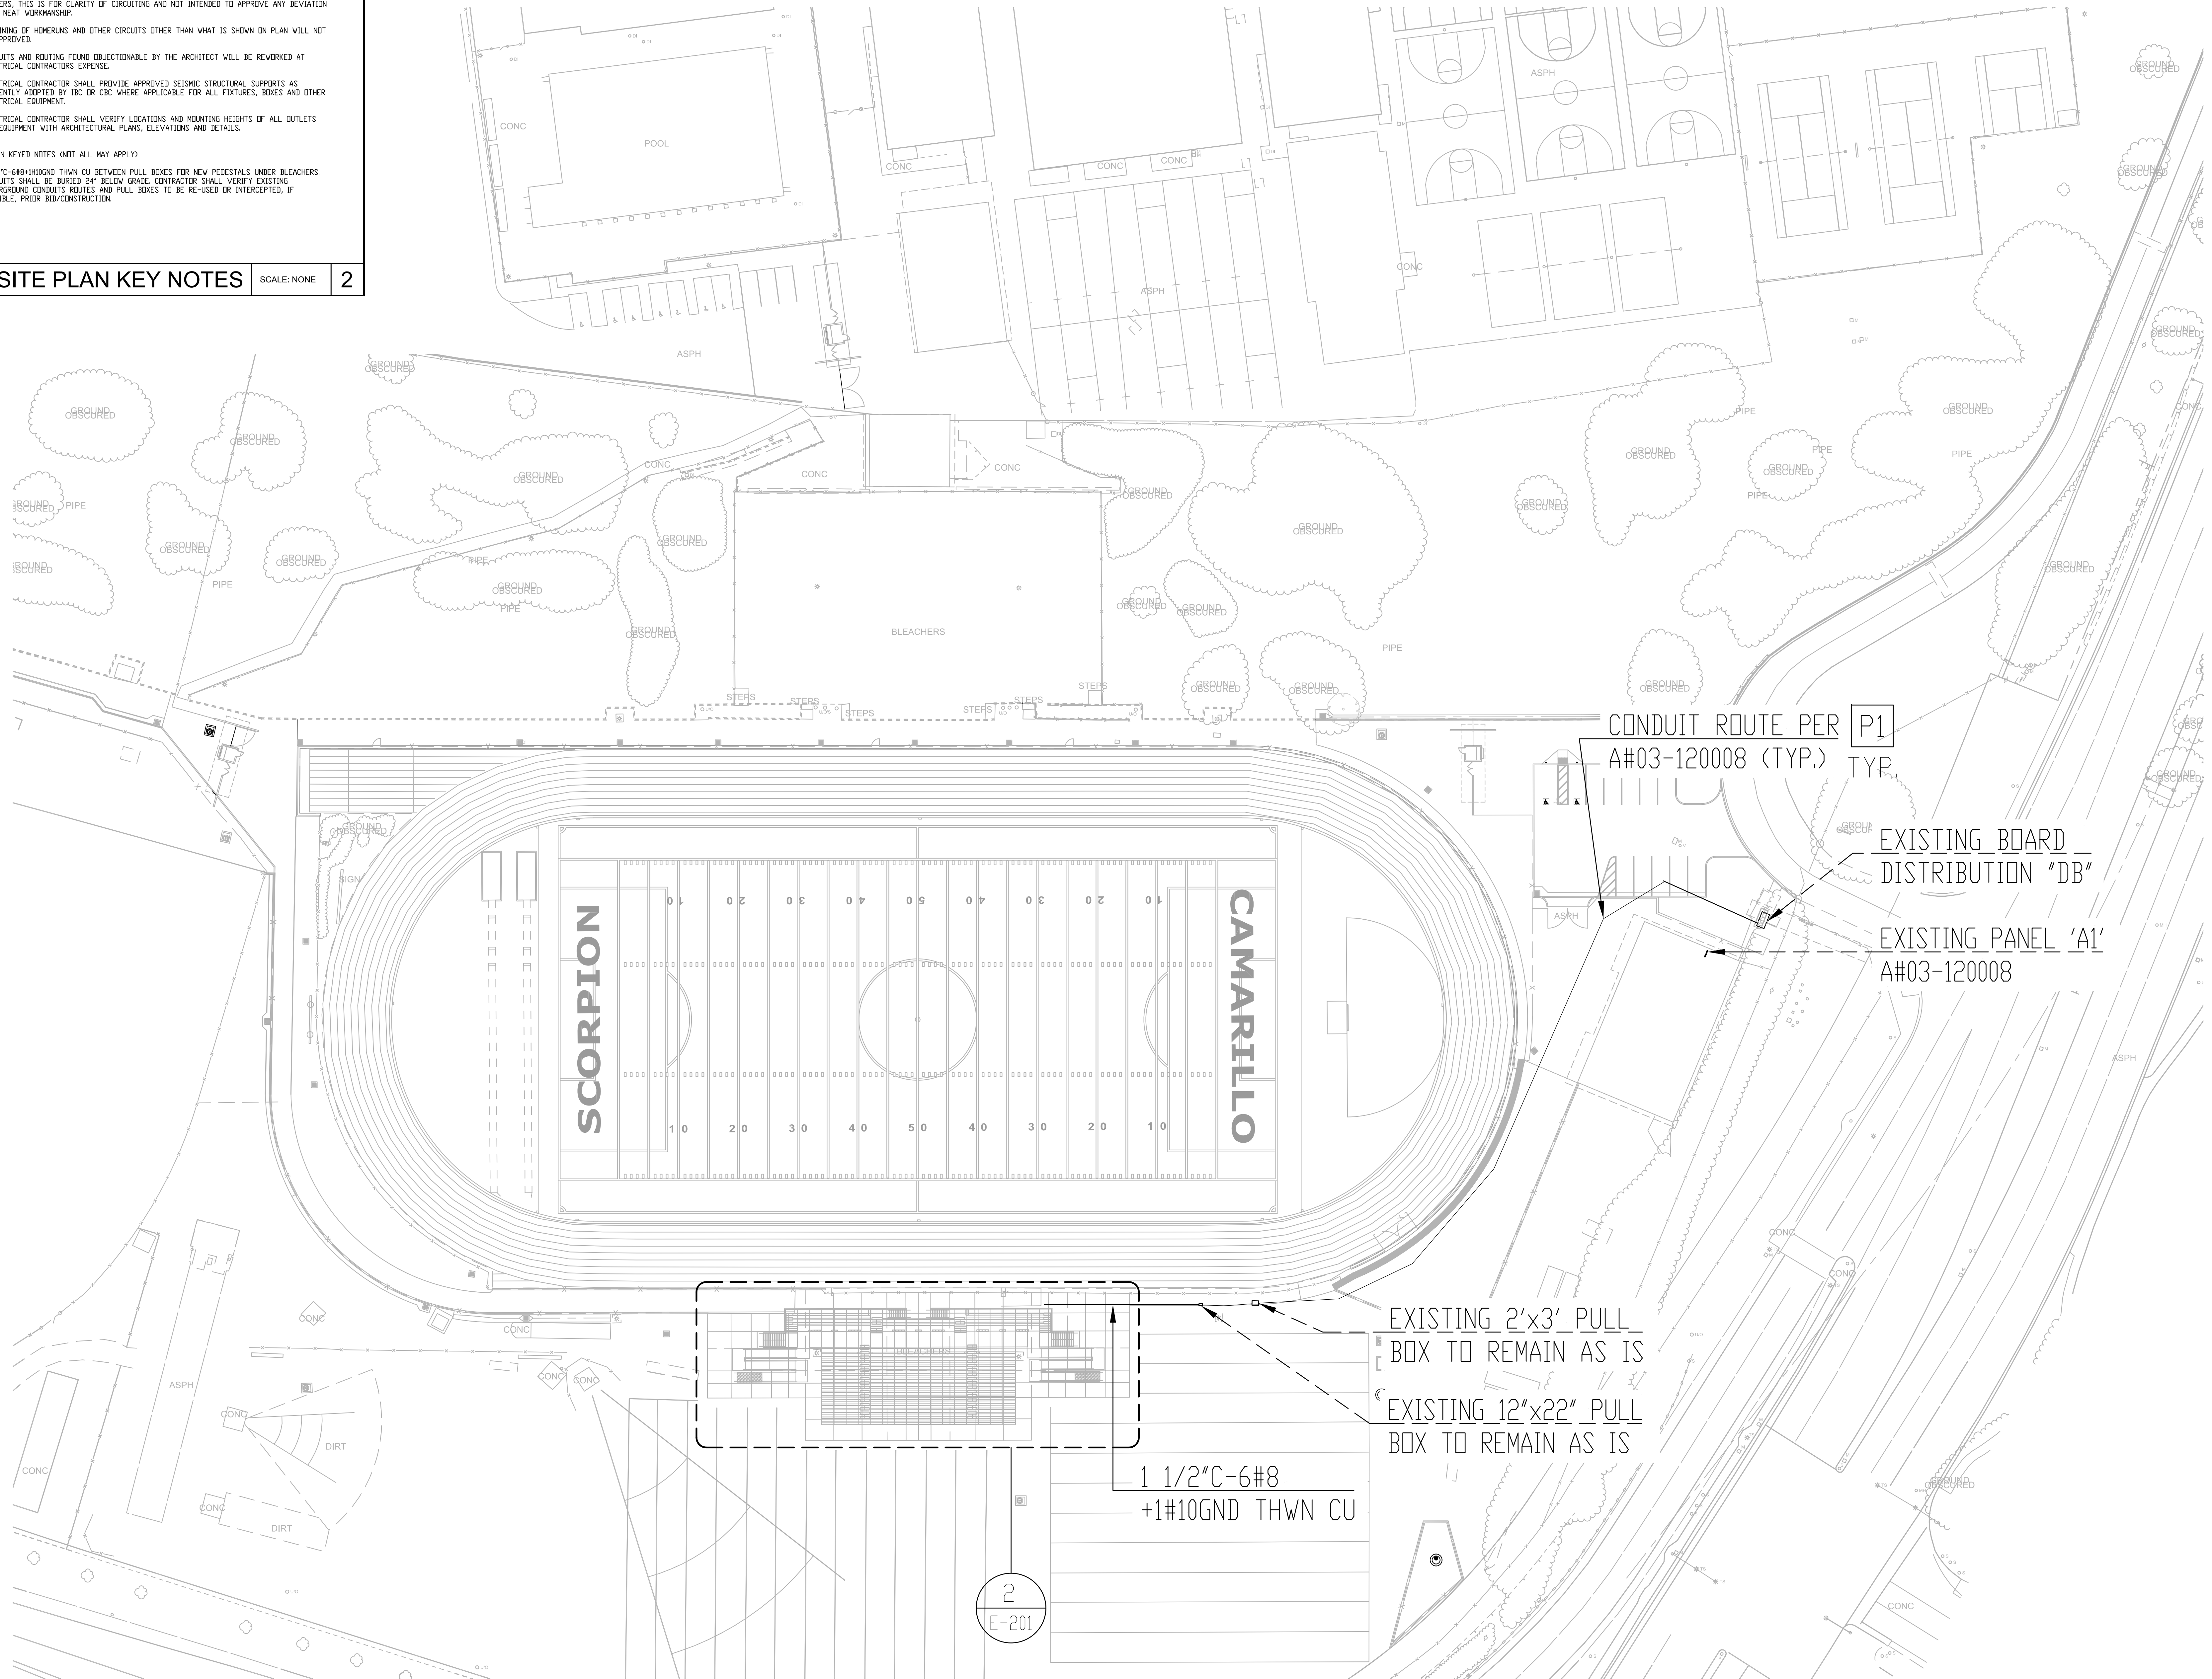

IDENTIFICATION STAMP
DIV. OF THE STATE ARCHITECT
APP. 03-120480 INC.
REVIEWED FOR
SS ☐ FLS ☐ ACS ☐
DATE: 07/22/2020

LITTLE
DIVERSIFIED ARCHITECTURAL CONSULTING

www.littleonline.com




This drawing and the design shown are the property of Little Diversified Architectural Consulting. The reproduction, copying or other use of this drawing without their written consent is prohibited and any infringement will be subject to legal action.

© Little 2019

**OXNARD UNION
HIGH SCHOOL
DISTRICT**

**ADOLFO CAMARILLO HIGH SCHOOL
SOUTHERN BLEACHERS**

**4660 MISSION OAKS BLVD.,
CAMARILLO, CA. 93012**

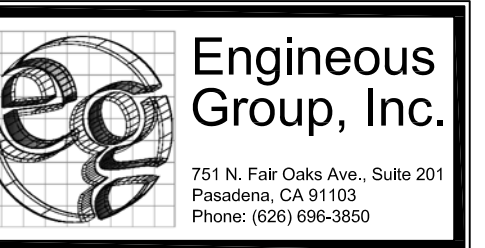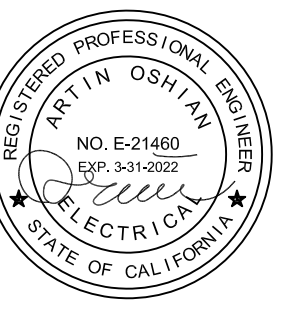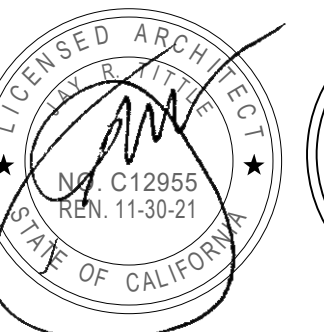

DSA SUBMITTAL

07/22/2020

NO.	REASON	DATE

PRINCIPAL IN CHARGE
B.E.S.
PROJECT MANAGER
S.A.M.
DESIGN TEAM
D.L.E.

**ADOLFO CAMARILLO HIGH
SCHOOL SOUTHERN BLEACHERS**


ELECTRICAL SITE PLAN

ELECTRICAL SITE PLAN

SCALE: 1/8"=1'-0"

1

E-200

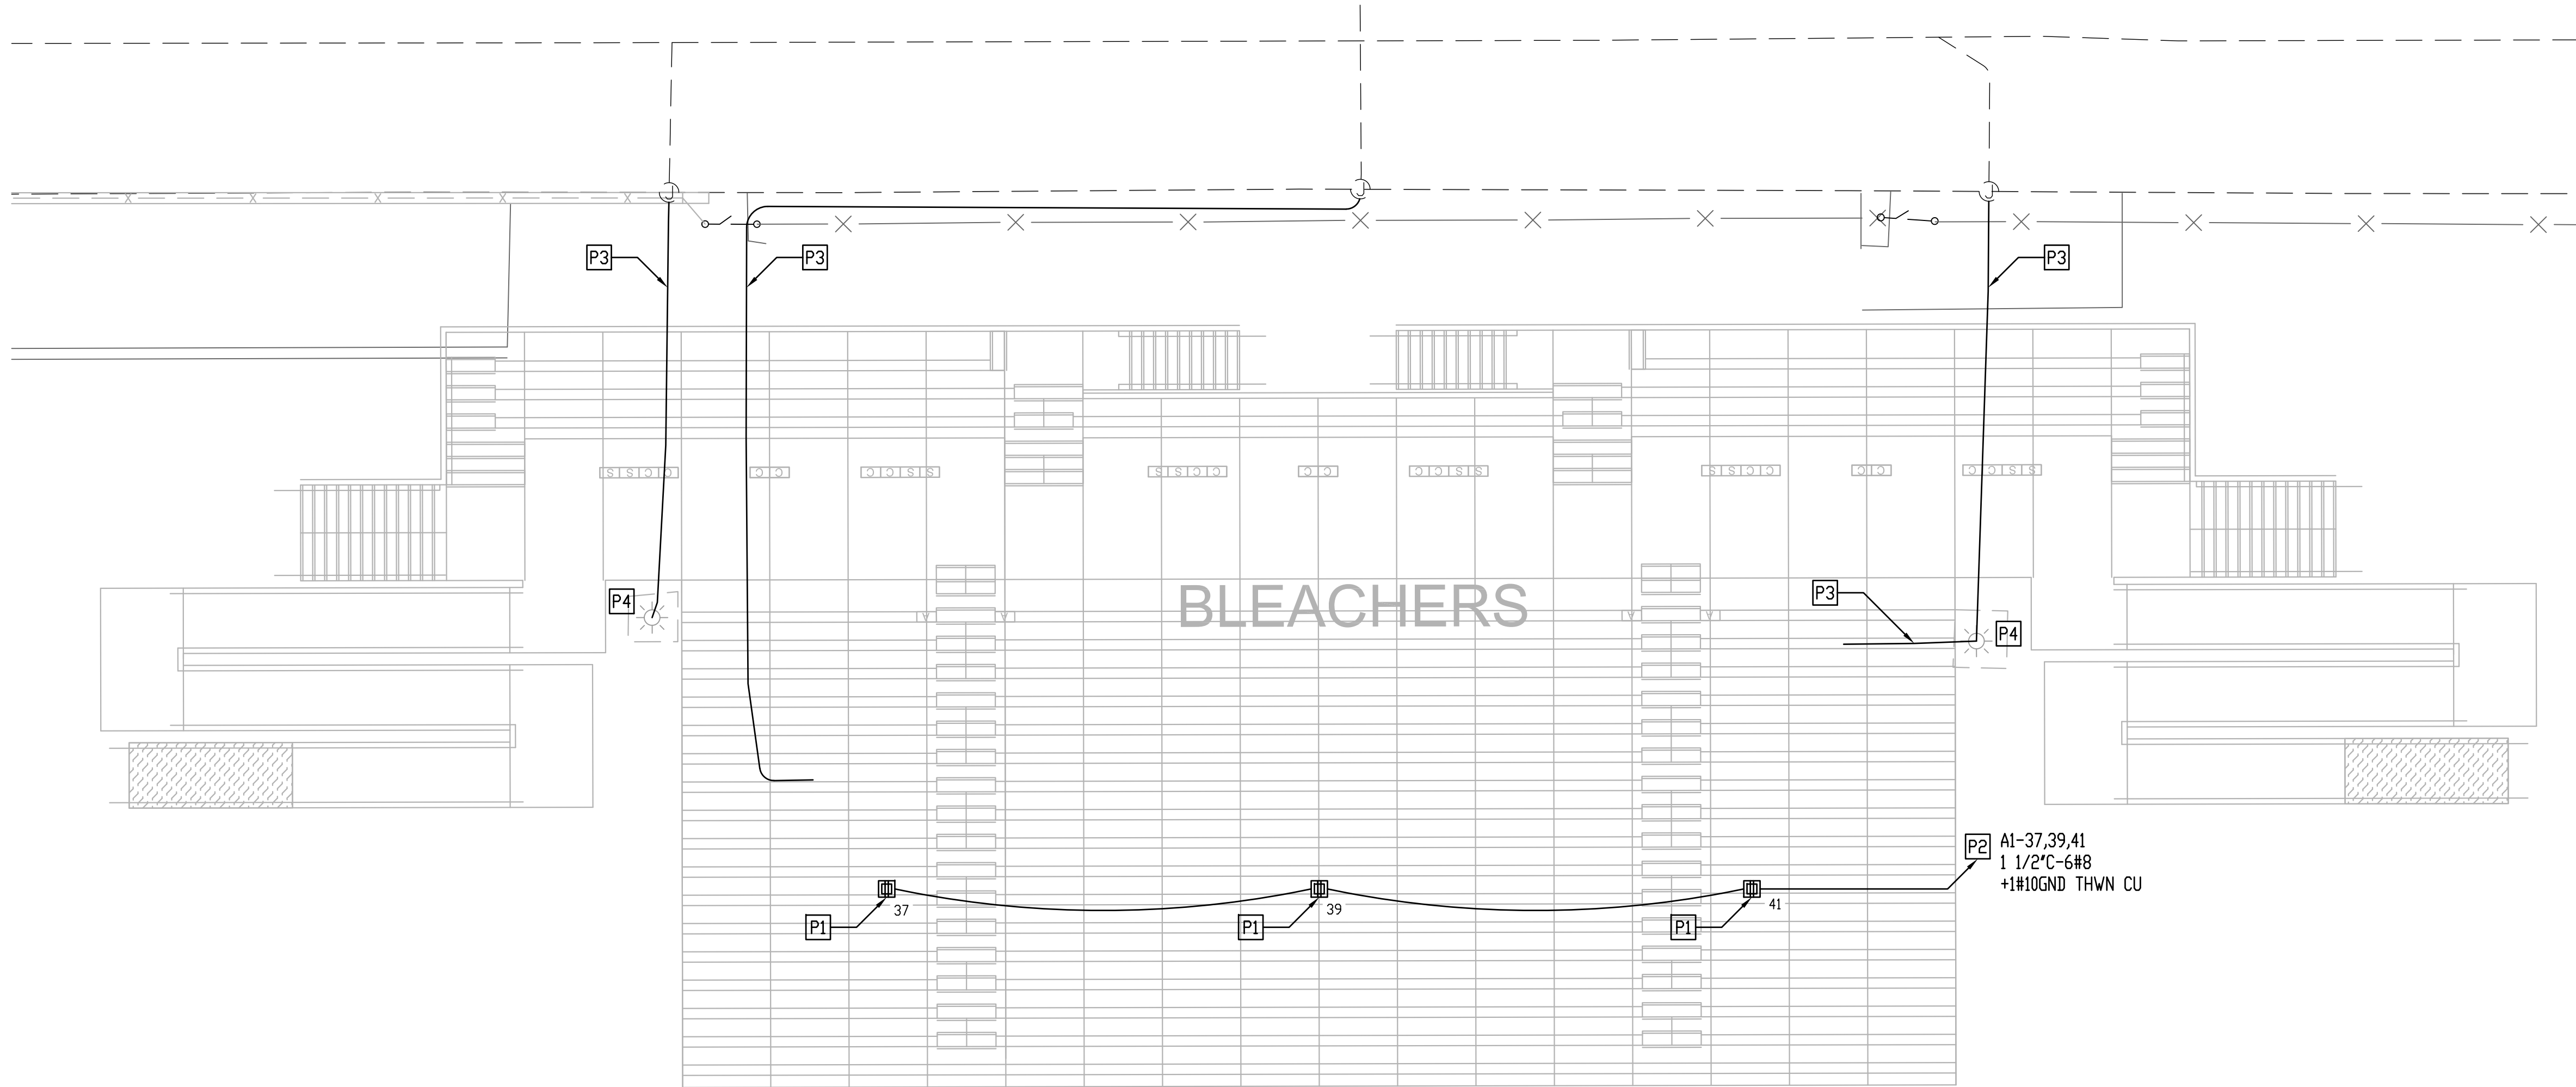

- POWER GENERAL NOTES
- ALL CONDUITS SHALL BE RUN NEATLY AND PARALLEL OR PERPENDICULAR TO STRUCTURAL MEMBERS. CONDUIT ROUTING SHOWN ON PLAN IS DIAGRAMMATIC AND IS INTENDED TO SHOW POSSIBLE FUNCTIONAL ROUTE OF CONDUITS AND CONDUCTORS. IN SOME CASES THE DRAWING SHOWS ROUTING WHICH MAY NOT BE PARALLEL OR PERPENDICULAR TO BUILDING STRUCTURAL MEMBERS. THIS IS FOR CLARITY OF CIRCUITING AND NOT INTENDED TO APPROVE ANY DEVIATION FROM NEAT WORKMANSHIP.
 - COMBINING OF HOMERUNS AND OTHER CIRCUITS OTHER THAN WHAT IS SHOWN ON PLAN WILL NOT BE APPROVED.
 - CONDUITS AND ROUTING FOUND OBJECTIONABLE BY THE ARCHITECT WILL BE REVOKED AT ELECTRICAL CONTRACTORS EXPENSE.
 - ELECTRICAL CONTRACTOR SHALL PROVIDE APPROVED SEISMIC STRUCTURAL SUPPORTS AS CURRENTLY ADOPTED BY IBC OR CBC WHERE APPLICABLE FOR ALL FIXTURES, BOXES AND OTHER ELECTRICAL EQUIPMENT.
 - ELECTRICAL CONTRACTOR SHALL VERIFY LOCATIONS AND MOUNTING HEIGHTS OF ALL OUTLETS AND EQUIPMENT WITH ARCHITECTURAL PLANS, ELEVATIONS AND DETAILS.


- POWER PLAN KEYED NOTES (NOT ALL MAY APPLY)
- P1** NEMA-3R RATED PEDESTAL MOUNTED GFCI RECEPTACLES, 18" HEIGHT 1P18-C-1T OR EQUAL. CONTRACTOR SHALL CONFIRM WITH DISTRICT/ARCHITECT PRIOR BID/INSTALLATION.
- P2** NEW UNDERGROUND CONDUITS AND CONDUCTORS FOR NEW PEDESTALS UNDER BLEACHERS SHALL BE ROUTED THROUGH EXISTING PULL BOXES TO EXISTING PANEL 'A'. CONTRACTOR SHALL VERIFY EXISTING QUANTITIES AND SIZES OF EXISTING CONDUITS AND CONDUCTORS IN PULL BOXES AND MODIFY PULL BOX SIZE IF NECESSARY, OTHERWISE RE-USE EXISTING EQUIPMENT PER CODE REQUIREMENTS.
- P3** EXISTING ELECTRICAL FEEDERS TO BE REMOVED AND REPLACED WITH NEW FEEDERS IF DAMAGED DURING CONSTRUCTION AND OVER EXCAVATION. CONTRACTOR SHALL VERIFY EXISTING QUANTITY AND SIZING TO PROCEED INSTALLATION OF NEW CONDUITS/CONDUCTORS.
- P4** EXISTING CONCRETE SLAB FOR LIGHTING POLE TO BE REPLACED WITH NEW CONCRETE SLAB UNDER THE BLEACHERS. LOCATION OF EXISTING HAND HOLD, JUNCTION BOX, AND CONDUITS AT EXISTING STADIUM LIGHT POLE TO BE RELOCATED. NEW LOCATION OF HAND HOLD, JUNCTION BOX, CONDUITS ON STADIUM LIGHT POLE TO BE ADJUSTED PER NEW HEIGHT OF NEW LIGHTING POLE CONCRETE SLAB.

POWER PLAN KEY NOTES SCALE: NONE 1

ELECTRICAL SEATING LAYOUT SCALE: 1/8"=1'-0" 2


PANELBOARD: A1 (EXISTING)														
BUS AMPS: 225A MAIN SIZE/TYPE: 225A MCB VOLTS/PHASE: 208Y/120V, 3PH, 4W SECTION: 1					FAULT CURRENT: REFER TO ONE-LINE DIAGRAM AIC RATING: REF 1-LINE SERVES: MOUNTING: SURFACE LOCATION: BUILDING 2'									
CKT NO.	DESCRIPTION	VOLTAMPS/PHASE			WIRE NO.	BKR AMP	P	F	BKR WIRE NO.	VOLTAMPS/PHASE			DESCRIPTION	CKT NO.
		A	B	C						A	B	C		
1	EXISTING LOAD	500			20	1	1	20	500				EXISTING LOAD	2
3	EXISTING LOAD		500			1	1	20		500			EXISTING LOAD	4
5	EXISTING LOAD			500	20	1	1	20			500		EXISTING LOAD	6
7	EXISTING LOAD	500			20	1	1	20	500				EXISTING LOAD	8
9	EXISTING LOAD		500		20	1	1	20		500			EXISTING LOAD	10
11	EXISTING LOAD			500	20	1	1	20			500		EXISTING LOAD	12
13	EXISTING LOAD	500							900		900		EXISTING FIELD POWER J-BOX	14
15	EXISTING LOAD		500		20	1	2	20		900			EXISTING FIELD POWER J-BOX	16
17	EXISTING LOAD			500	20	1	1	20			900		EXISTING FIELD POWER J-BOX	18
19					1	2	20		900				EXISTING FIELD POWER J-BOX	20
21						1	2			900				22
23						1	2	20			900		EXISTING FIELD POWER J-BOX	24
25						1	1		900			900		26
27	EXISTING CONVERSION UPS		2,500		30	2	1							28
29			2,500											30
31						1	1							32
33						1	1							34
35						1	1							36
37	OUTLET - VISITOR BLEACHERS	1,200			20	1			6,000				EXISTING SUB-PANEL 'A'	38
39	OUTLET - VISITOR BLEACHERS		1,200		20	1	3	70		6,000				40
41	OUTLET - VISITOR BLEACHERS			1,200	20	1	1				6,000			42
SUBTOTAL		2,700	5,200	5,200					9,700	8,800	9,200	SUBTOTAL		
TOTAL PHASE A - VA		12,400	LOAD		CONN. VA		DF	LOAD		CONN. VA		DF		
AMPS		103	COOLING				1.00	REFRIGERATION				1.00		
TOTAL PHASE B - VA		14,000	HEATING				0	SIGN/DISPLAY				1.25		
AMPS		117	LIGHTING				1.25	KITCHEN				1.00		
TOTAL PHASE C - VA		14,400	RECEPTACLES				1.0/5	EXISTING		12,000		1.00		
AMPS		120	MOTORS				1.00	LARGE MOTOR				1.25	TOTAL DEMAND	
TOTAL PANEL - VA		40,800	SUPP HEAT				1.00	SHOW WINDOW				1.25	40,800 VA	
AMPS		113	MISC EQUIP				1.00	LTG TRACK				1.00	113 A	
PANELBOARD NOTES														
N - NEW CIRCUITS, BREAKERS AIC RATING SHALL MATCH WITH EXISTING BREAKERS.														
LTG TRACK - TRACK LENGTH														
SIGN/DISPLAY - SIGNAGE & DISPLAY CASE														

EXISTING PANEL 'A1' SCHEDULE SCALE: NONE 4

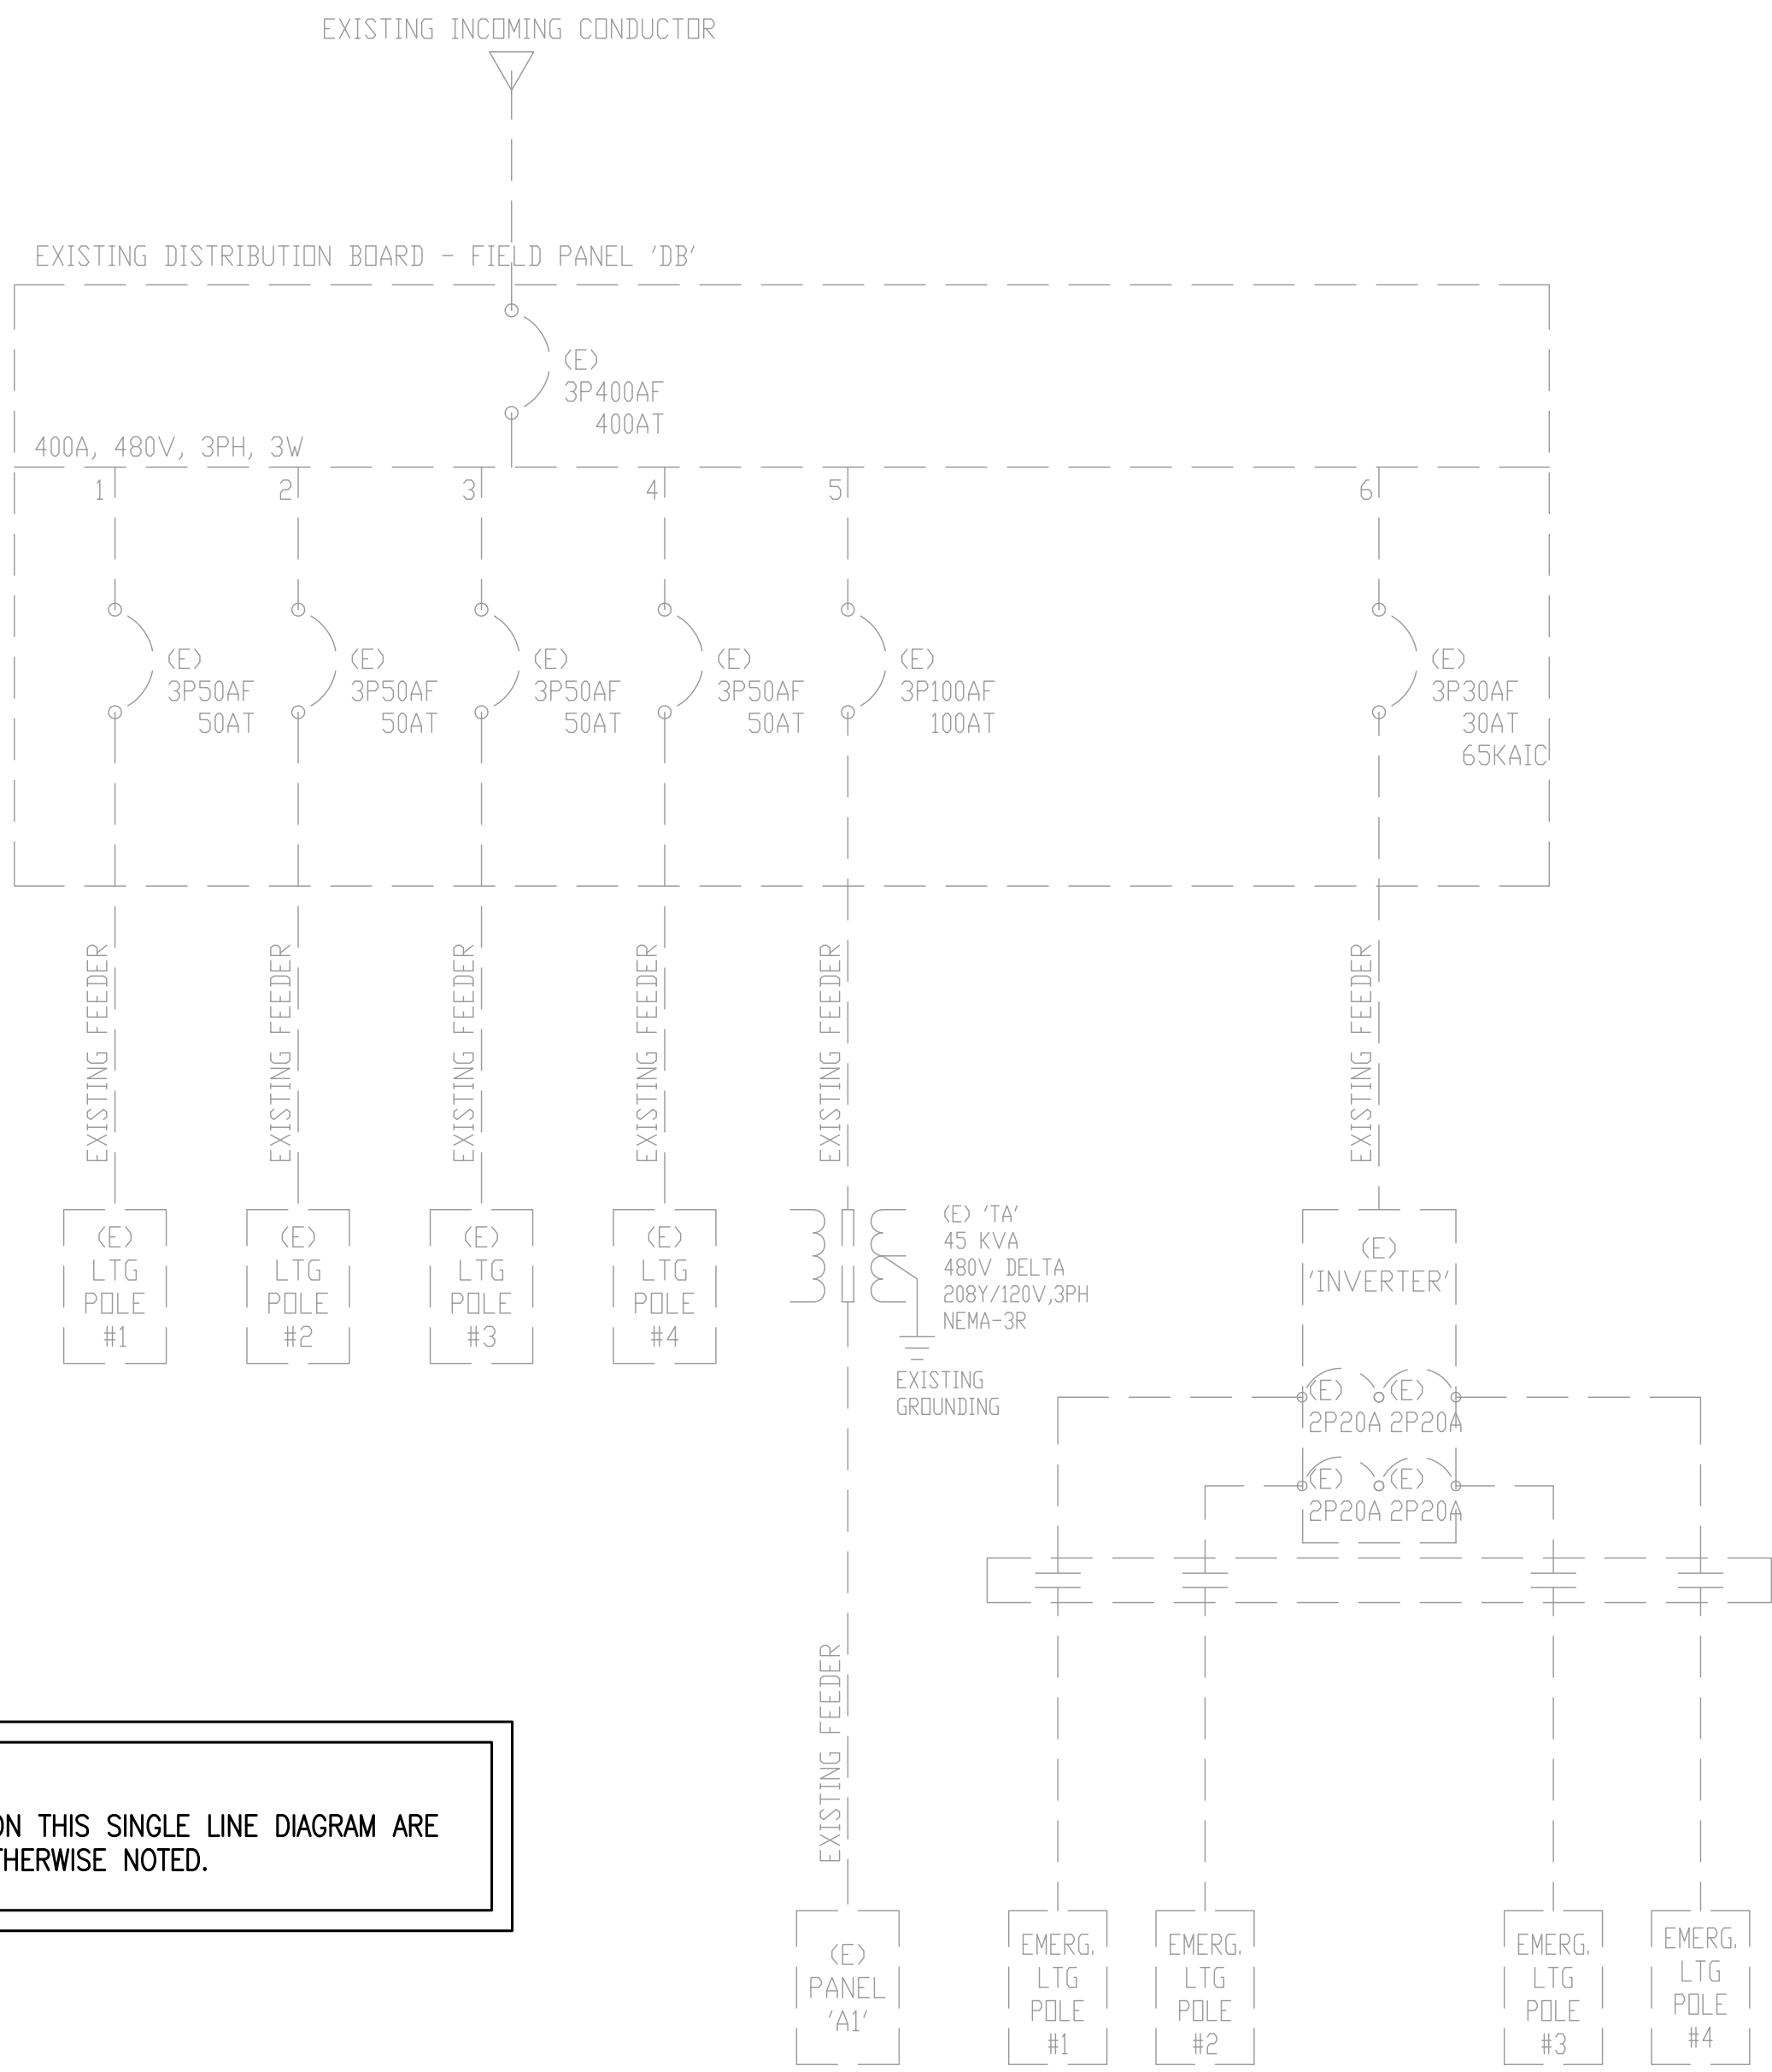

NOTE:
ALL ITEMS SHOWN ON THIS SINGLE LINE DIAGRAM ARE
EXISTING UNLESS OTHERWISE NOTED.

EXISTING PARTIAL SINGLE LINE DIAGRAM SCALE: NONE 3

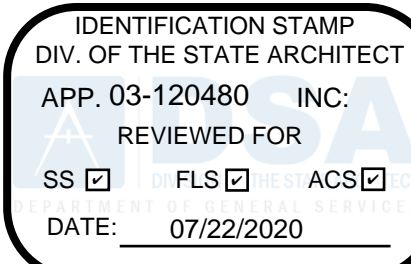

LITTLE
DIVERSIFIED ARCHITECTURAL CONSULTING

www.littleonline.com



This drawing and the design shown are the property of Little Diversified Architectural Consulting. The reproduction, copying or other use of this drawing without the written consent is prohibited and any infringement will be subject to legal action.

© Little 2019

**OXNARD UNION
HIGH SCHOOL
DISTRICT**

**ADOLFO CAMARILLO HIGH SCHOOL
SOUTHERN BLEACHERS**

**4660 MISSION OAKS BLVD.,
CAMARILLO, CA. 93012**

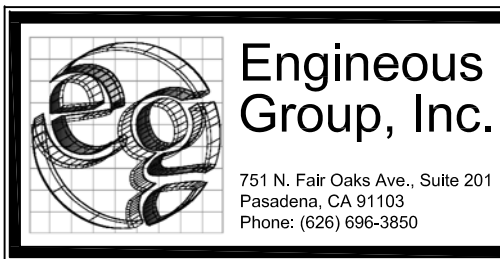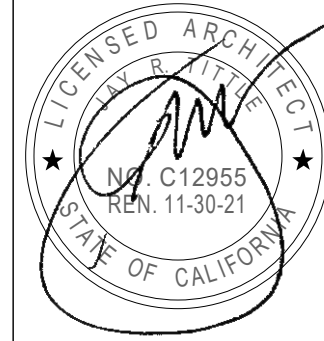

DSA SUBMITTAL

07/22/2020

NO.	REASON	DATE

PRINCIPAL IN CHARGE
B.E.S.
PROJECT MANAGER
S.A.M.
DESIGN TEAM
D.L.E.

**ADOLFO CAMARILLO HIGH
SCHOOL SOUTHERN BLEACHERS**

ELECTRICAL PLANS -
BLEACHERS

E-201